Planning Commission Resolution No. 20755

HEARING DATE: JULY 9, 2020

RH-2 (Residential-House, Two-Family) Zoning District

1650 Mission St. Suite 400 San Francisco, CA 94103-2479

Reception:

Fax. 415.558.6409

Planning Information: 415.558.6377

415.558.6378

Block/Lot: 4991/276

Record No.:

Zoning:

Project Address:

Project Sponsor: Jim Abrams, J. Abrams Law, P.C.

2019-002743CRV

One Maritime Plaza, Suite 1900,

San Francisco, CA 94111

853 Jamestown Avenue

40-X Height and Bulk District

Property Owner: Strada Jamestown Venture, LLC

San Francisco, CA 94124

Staff Contact: Xinyu Liang - (415) 575-9182

Xinyu.Liang@sfgov.org

RESOLUTION ADOPTING **FINDINGS** RELATED TO THE REQUESTED CONCESSION/INCENTIVE AND WAIVERS FROM DEVELOPMENT STANDARDS PURSUANT TO STATE DENSITY BONUS LAW (CA GOVT. CODE SECTION 65915) AND PLANNING CODE SECTION 206.6; AFFIRMING AND ADOPTING FINDINGS UNDER THE CALIFORNIA ENVIRONMENTAL QUALITY ACT, AND FINDINGS OF CONSISTENCY WITH THE GENERAL PLAN AND PLANNING CODE SECTION 101.1.

WHEREAS, on July 18, 2019, J. Abrams Law, on behalf of the Project Sponsor submitted, among other materials, a project application ("PRJ") for the proposed project, an application for approval under the Individually Requested State Density Bonus Program, and a notice to the Planning Department that Project applications pertain to a development project pursuant to both the Housing Accountability Act and the Permit Streamlining Act (Section 65920 et seq of the California Government Code).

WHEREAS, on August 29, 2019, the Department deemed the application complete.

WHEREAS, on December 11, 2019, the Department issued a letter to the Project Sponsor summarizing its analysis of the PRJ materials, including itemized analysis of the proposed project's conformity with applicable Planning Code provisions, applicable design guidelines, and the Individually Requested State Density Bonus Program ("Plan Check Letter").

WHEREAS, the Department has concluded that the proposed project, as revised to respond to the Plan Check Letter and as presented in the plan set attached hereto as Exhibit A conforms with applicable Planning Code provisions, applicable design guidelines and the Individually Requested State Density Bonus Program.

WHEREAS, The Planning Commission (hereinafter "Commission") conducted a duly noticed public hearing at a regularly scheduled meeting to consider the proposed project on July 9, 2020 and make findings required by the Individually Requested State Density Bonus Program; and,

WHEREAS, on March 2, 2006, the Commission adopted Motion No. 17200 certifying the Bayview Hunters Point Redevelopment Projects and Rezoning Final Environmental Impact Report (hereinafter "BVHP FEIR"). On March 2, 2006, the Commission adopted Motion No. 17201 adopting California Environmental Quality Act (hereinafter "CEQA") findings related to the Bayview Hunters Point Redevelopment Projects and Rezoning, including a Statement of Overriding Considerations and a Mitigation Monitoring and Reporting Program. The proposed project was considered as part of the BVHP FEIR and addressed in the CEQA findings adopted for the the Bayview Hunters Point Redevelopment Projects and Rezoning. Thus, the proposed project was eligible for an Addendum to the BVHP FEIR pursuant to CEQA Guidelines Section 15164, and the Addendum was issued on April 16, 2020. The Addendum concludes that the proposed project would not cause new significant impacts that were not identified in the BVHP FEIR, would not result in significant impacts that would be substantially more severe than those identified in the BVHP FEIR, and would not require new mitigation measures to reduce significant impacts; no changes have occurred with respect to circumstances surrounding the proposed project that would cause significant environmental impacts to which the project would contribute considerably, and no new information has been put forward to demonstrate that the proposed project would cause new significant environmental impacts or a substantial increase in the severity of previously identified significant impacts.

WHEREAS, the Commission has heard and considered the testimony presented to it at the public hearing and has further considered written materials and oral testimony presented on behalf of Department staff and other interested parties; and

WHEREAS, all pertinent documents may be found in the files of the Department, as the custodian of records, at 1650 Mission Street, Suite 400, San Francisco; and

MOVED, That the Planning Commission has reviewed and considered the portions of the BVHP FEIR that are relevant to the proposed project, finds that the Addendum to the EIR under case No. 2019-002743ENV is adequate, accurate, and objective, reflects the independent analysis and judgment of the Planning Department and the Planning Commission, and concurs with the determination that no additional environmental review is required for the reasons set forth in the Addendum; and

MOVED, That the Planning Commission reaffirms and adopts the CEQA Findings and Statement of Overriding Considerations adopted for the BVHP FEIR on March 2, 2006 with Motion No. 17201; and

MOVED, That the Planning Commission adopts the Mitigation and Monitoring Program (MMRP) attached to this Motion as Exhibit B; and

MOVED, that the Commission hereby finds that the requested concession/incentive for street frontages (Section 144) and the waiver from development standards for rear yard (Section 134) are necessary for the Project, and makes the following findings.

SAN FRANCISCO
PLANNING DEPARTMENT

FINDINGS

Having reviewed the materials identified in the preamble above, and having heard all testimony and arguments, this Commission finds, concludes, and determines as follows:

- 1. The above recitals are accurate and constitute findings of this Commission.
- 2. **Project Description.** The Project proposes new construction of 122 residential units in 20 buildings on a 6.87-acre vacant parcel along Jamestown Avenue. The unit size varies from 1,100 to 1,550 square feet, and each will contain two or three bedrooms. Most units will be three-story attached townhome-style condominiums with private garages at grade. In total, the project will include approximately 169,332 square feet of residential use with 153 private and 17 guest parking spaces, and 122 Class 1 and 8 Class 2 bicycle parking spaces.

The Project is pursuing the State Density Bonus Law pursuant to Planning Code Section 206.6 and California Government Code Section 65915. The base density includes the amount of residential development that could occur on the project site as-of-right without modifications to the physical aspects of the Planning Code. The RH-2 Zoning District permits up to two residential units per lot. The proposed development site could theoretically be subdivided into 50 code-compliant lot. Therefore, the maximum number of units allowed by the Zoning District (or the base density) is 100 dwelling units. The Project is seeking a density bonus of 22% for a total of 122 residential units. 22% of the base project, or 22 units, will be affordable. 12 of the units (12%) will be affordable to low-income households, five of the units (5%) will be affordable to moderate-income households, and the remaining five units (5%) will be affordable to middle-income households as defined by the Planning Code and Procedures Manual.

- 3. **Site Description and Present Use.** The Project Site consists of a 6.87-acre parcel located at 853 Jamestown Avenue in San Francisco's Bayview-Hunters Point neighborhood. It was previously occupied by a surface parking lot with perimeter fencing that served Candlestick Park until its demolition in 2014. The site gently slopes upward to the north and there is a steep incline between the project site and Bayview Park to the west. Given the relatively steep slopes on portions of the project site, approximately 3.5 acres of the 6.87-acre project site are suitable for development per the Project Sponsor
- 4. Surrounding Properties and Neighborhood. The Project Site is located within the RH-2 (Residential-House, Two-Family) Zoning District in the Candlestick Point SubArea Plan and Bayview Hunters Point Area Plan. The site is bordered to the north by multifamily residential buildings; Jamestown Avenue to the east; and Bayview Park, which is owned and operated by the San Francisco Recreation and Parks Department, to the west and south. The project site is approximately 0.5 miles east of the Le Conte stop of the T Muni Metro Rail Line, approximately one mile northeast of the Bayshore Caltrain Station, and 0.75 miles southeast of the Third Street/Jamestown Avenue on-ramp to southbound U.S. 101. The neighborhood is characterized by one- to two-story single-family homes across the street on Jamestown Avenue, and by three- to

four-story multifamily buildings immediately to the north. The project is also adjacent to the future redevelopment currently underway at Candlestick Point. Other zoning districts in the vicinity of the project site include RH-1(Residential-House, One-Family), C-2 (Community Business), and P (Public) Zoning District.

- 5. **Planning Code Section 206.6 Findings.** Pursuant to Planning Code Section 206.6(e), the Planning Commission shall make the following findings as applicable for any application for a Density Bonus, Incentive, Concession or Waiver for any Individually Requested Density Bonus Project:
 - A. The Housing Project is eligible for the Individually Requested Density Bonus Program pursuant to Planning Code Section 206.6(b).

The Project Site can accommodate at least five dwelling units on a vacant parking lot that is in the RH-2 Zoning District. The project would contain a total of 122 residential units in 20 building, including 12 units at 80% AMI, which qualifies for a 22% density bonus. The project is not seeking a density bonus under any other state or local density bonus programs; therefore, the project is eligible for the Individually Requested Density Bonus Program.

B. The Housing Project has demonstrated that any Concessions or Incentives reduce actual housing costs, as defined in Section 50052.5 of the California Health and Safety Code, or for rents for the targeted units, based upon the financial analysis and documentation provided.

The Project is requesting a concession and incentive for street frontage under the Individually Requested Density Bonus Program. Planning Code Section 144 requires every dwelling to have no more than one-third of the width of the ground story along the front lot line, or along a street-side lot line, be devoted to entrances to off-street parking. In addition, where two or more separate entrances are provided, there shall be a minimum separation between such entrances of six feet.

The Project Sponsor has sufficiently demonstrated that the requested concession reduces the overall cost of the Project. Subterranean parking would be required to reduce the amount of the ground floor devoted to off-street garage parking entrances. The Project Sponsor provides an estimate that the additional cost to building subterranean parking for 41 units at buildings 1-5 at \$80,000 per parking stall would increase the project cost by \$3.28 million. The requested incentive would result in cost reductions for the project that would offset the cost of providing affordable units on-site. An incentive to make a project as a whole, including the affordable housing units, economically feasible is a well-established use of an incentive.

C. If a waiver or modification is requested, a finding that the Development Standards for which the waiver is requested would have the effect of physically precluding the construction of the Housing Project with the Density Bonus or Concessions and Incentives permitted.

The Project includes the construction of 20 new residential buildings for a total of 122 units. In order to achieve the proposed residential density, the Project is requesting one waiver from development standards for the rear yard requirement. Planning Code Section 134 requires that the Project provide a

rear yard equal to 45 percent of the total lot depth. The proposed Buildings 6 to 16, which include 53 units, and the central trash enclosure would encroach into the required rear yard in order to better accommodate the internal circulation and the required private fire access road. Without the waivers, the Project will be physically precluded from constructing the project at the allowable density, including the 22 additional units as permitted under the Individually Requested Density Bonus Program, thus preventing the Project from achieving a 22% density bonus.

D. If the Density Bonus is based all or in part on donation of land, a finding that all the requirements included in Government Code Section 65915(g) have been met.

The Density Bonus for the Project is not based on any donation of land; and is therefore not applicable.

E. If the Density Bonus, Concession or Incentive is based all or in part on the inclusion of a Child Care Facility, a finding that all the requirements included in Government Code Section 65915(h) have been met.

The requested Density Bonus for the Project is not based on the inclusion of a Child Care Facility; and is therefore not applicable.

F. If the Concession or Incentive includes mixed-use development, a finding that all the requirements included in Government Code Section 65915(k)(2) have been met.

The requested Density Bonus for the Project does not involve a mixed-use development; and is therefore not applicable.

6. **General Plan Compliance.** The Project is, on balance, consistent with the following Objectives and Policies of the General Plan:

HOUSING ELEMENT

Objectives and Policies

OBJECTIVE 1:

IDENTIFY AND MAKE AVAILABLE FOR DEVELOPMENT ADEQUATE SITES TO MEET THE CITY'S HOUSING NEEDS, ESPECIALLY PERMANENTLY AFFORDABLE HOUSING.

Policy 1.1

Plan for the full range of housing needs in the City and County of San Francisco, especially affordable housing.

Policy 1.10

Support new housing projects, especially affordable housing, where households can easily rely on public transportation, walking and bicycling for the majority of daily trips.

Policy 1.2

Focus housing growth and infrastructure necessary to support growth according to community plans. Complete planning underway in key opportunity areas such as Treasure Island, Candlestick Park and Hunter's Point Shipyard.

Policy 1.10

Support new housing projects, especially affordable housing, where households can easily rely on public transportation, walking and bicycling for the majority of daily trips.

OBJECTIVE 4:

FOSTER A HOUSING STOCK THAT MEETS THE NEEDS OF ALL RESIDENTS ACROSS LIFECYCLES.

Policy 4.1

Develop new housing, and encourage the remodeling of existing housing, for families with children.

Policy 4.5

Ensure that new permanently affordable housing is located in all of the City's neighbor-hoods, and encourage integrated neighborhoods, with a diversity of unit types provided at a range of income levels.

OBJECTIVE 11:

SUPPORT AND RESPECT THE DIVERSE AND DISTINCT CHARACTER OF SAN FRANCISCO'S NEIGHBORHOODS.

Policy 11.1

Promote the construction and rehabilitation of well-designed housing that emphasizes beauty, flexibility, and innovative design, and respects existing neighborhood character.

Policy 11.2

Ensure implementation of accepted design standards in project approvals.

Policy 11.3

Ensure growth is accommodated without substantially and adversely impacting existing residential neighborhood character.

Policy 11.4:

Continue to utilize zoning districts which conform to a generalized residential land use and density plan and the General Plan.

Policy 11.6

Foster a sense of community through architectural design, using features that promote community interaction.

Policy 11.8

Consider a neighborhood's character when integrating new uses, and minimize disruption caused by expansion of institutions into residential areas.

OBJECTIVE 12:

BALANCE HOUSING GROWTH WITH ADEQUATE INFRASTRUCTURE THAT SERVES THE CITY'S GROWING POPULATION.

Policy 12.2

Consider the proximity of quality of life elements such as open space, child care, and neighborhood services, when developing new housing units.

Policy 12.3

Ensure new housing is sustainably supported by the City's public infrastructure systems.

OBJECTIVE 13

PRIORITIZE SUSTAINABLE DEVELOPMENT IN PLANNING FOR AND CONSTRUCTING NEW HOUSING.

Policy 13.1

Support "smart" regional growth that located new housing close to jobs and transit.

URBAN DESIGN ELEMENT

Objectives and Policies

OBJECTIVE 1:

EMPHASIS OF THE CHARACTERISTIC PATTERN WHICH GIVES TO THE CITY AND ITS NEIGHBORHOODS AN IMAGE, A SENSE OF PURPOSE, AND A MEANS OF ORIENTATION.

Policy 1.3

Recognize that buildings, when seen together, produce a total effect that characterizes the city and its districts.

Policy 1.7

Recognize the natural boundaries of districts, and promote connections between districts.

BAYVIEW HUNTERS POINT AREA PLAN

HOUSING

Objectives and Policies

OBJECTIVE 6:

ENCOURAGE THE CONSTRUCTION OF NEW AFFORDABLE AND MARKET RATE HOUSING AT LOCATIONS AND DENSITY LEVELS THAT ENHANCE THE OVERALL RESIDENTIAL QUALITY OF BAYVIEW HUNTERS POINT.

Policy 6.1

Encourage development of new affordable ownership units, appropriately designed and located and especially targeted for existing Bayview Hunters Point residents.

Policy 6.5

In the vicinity of Bayview Hill, encourage well-sited housing development that complements the natural areas and open space, as well as provides for local economic development.

URBAN DESIGN

Objectives and Policies

OBJECTIVE 10:

ENHANCE THE DISTINCTIVE AND POSITIVE FEATURES OF BAYVIEW HUNTERS POINT.

Policy 10.1

Better define Bayview's designated open space areas by enabling appropriate, quality development in surrounding areas.

OBJECTIVE 11

IMPROVE DEFINITION OF THE OVERALL URBAN PATTERN OF BAYVIEW HUNTERS POINT.

Policy 11.2

Increase awareness and use of the pedestrian/bicycle trail system that links subareas in Bayview Hunters Point with the rest of the City.

CANDLESTICK POINT SUBAREA PLAN

LAND USE

OBJECTIVE 1:

REALIZE THE FULL POTENTIAL OF THE UNDERUTILIZED CANDLESTICK POINT BY CREATING A COMPLETE AND THRIVING NEW NEIGHBORHOOD INTIMATELY CONNECTED TO THE BAYVIEW AND THE REST OF THE CITY, IN A WAY THAT FULLY

REALIZES ITS SHORELINE LOCATION AND ACTS AS AN ECONOMIC CATALYST FOR THE REST OF THE BAYVIEW.

Policy 11.2

Take full advantage of the underutilized site by providing high density sustainable development.

COMMUNITY DESIGN & BUILT FORM

OBJECTIVE 3:

CREATE A DIVERSE AND EXCITING URBAN NEIGHBORHOOD THAT IS ENGAGING, COMFORTABLE, AND HAS CONVENIENT ACCESS TO AMENITIES, OPTIMIZES ITS WATERFRONT SETTING AND REFLECTS SAN FRANCISCO BUILT FORM AND CHARACTER IN A CONTEMPORARY WAY.

Policy 3.2

Ensure a block pattern and street network that is tied to the adjacent neighborhood, is coherent, and provides the development with organization and orientation.

Policy 3.3

Create a street system where streets are clearly an element of the public realm.

Policy 3.4

Provide a development with a variety of building heights and sizes as a means to create variety and avoid monotonous development.

Policy 3.6

Assure high quality architecture of individual buildings that work together to create a coherent and identifiable place while being individually distinguishable.

The Department finds that the Project is, on balance, consistent with the Candlestick SubArea Plan, the Bayview Hunters Point Plan and the Objectives and Policies of the General Plan. The Project would provide 122 residential units, helping alleviate San Francisco's severe housing crisis. Additionally, the Project also includes new on-site below market-rate (BMR) units. 22 residential units will be dedicated to low to middle-income households. The proposed 20 new buildings would be interspersed with open space, including a new central community park and play area, and several garden paseos. The Project introduces a contemporary architectural vocabulary that is sensitive to the prevailing scale and neighborhood fabric. All the townhomestyle condominiums are similar in style, size, and density to the existing townhouses that immediately to the north of the site. All the units would range from approximately 1,100 to 1,550 square feet with 67% of homes with two bedrooms, two-and-a-half baths and 33% of homes with three bedrooms, three-and-a-half baths.

The Project will improve the public rights of way with new streetscape improvements. Along the Jamestown Avenue, quality streetscape design with a new 15-foot wide sidewalk is proposed. In order to fully integrate

the proposed subdivision with the City at large, the proposed private street will extend the neighborhood's street grid into the parcel. The built form would try to replicate the typical San Francisco residential development and building modulation

- 7. **Planning Code Section 101.1(b)** establishes eight priority-planning policies and requires review of permits for consistency with said policies. On balance, the project complies with said policies in that:
 - A. That existing neighborhood-serving retail uses be preserved and enhanced and future opportunities for resident employment in and ownership of such businesses be enhanced.

The project site does not possess any neighborhood-serving retail uses. The Project provides 122 new dwelling units, which will enhance the nearby retail uses by providing new residents, who may patron and/or own these businesses.

B. That existing housing and neighborhood character be conserved and protected in order to preserve the cultural and economic diversity of our neighborhoods.

The Project would not negatively affect the existing housing and neighborhood character. The Project would not displace any housing given the existing project site consists wholly of a paved vacant parking lot. The Project would improve the existing character of the neighborhood by developing 20 residential buildings with 122 dwelling units and include 22 on-site affordable units.

C. That the City's supply of affordable housing be preserved and enhanced,

The Project does not currently possess any existing affordable housing. The Project will comply with the City's Inclusionary Housing Program by providing 22 below-market-rate dwelling units. Therefore, the Project will increase the stock of affordable housing units in the City.

D. That commuter traffic not impede MUNI transit service or overburden our streets or neighborhood parking.

The Project would not impede MUNI transit service or overburden local streets or parking. The Muni bus line 29 is one block north of the proposed development site. The Project will provide off-street parking at the principally permitted amounts and sufficient bicycle parking for residents and their guests. The project would also implement a TDM plan, which would further reduce its vehicle travel demand.

E. That a diverse economic base be maintained by protecting our industrial and service sectors from displacement due to commercial office development, and that future opportunities for resident employment and ownership in these sectors be enhanced.

The Project is wholly a residential building and would not negatively affect the industrial and service sectors, nor would it displace any existing industrial uses.

F. That the City achieve the greatest possible preparedness to protect against injury and loss of life in an earthquake.

The Project will be designed and will be constructed to conform to the structural and seismic safety requirements of the Building Code. This proposal will not impact the property's ability to withstand an earthquake.

G. That landmarks and historic buildings be preserved.

The Project Site does not contain any City Landmarks or historic buildings.

H. That our parks and open space and their access to sunlight and vistas be protected from development.

The Project would not have an adverse effect on the City's parks and open space and their access to sunlight and vistas.

NOW THEREFORE BE IT RESOLVED that the Commission hereby ADOPTS the findings for the requested incentives, concessions, and waivers as described in this Resolution, and makes a condition of the Project and relevant BVHP FEIR mitigation measures identified in the MMRP attached hereto at Exhibit B.

I hereby certify that the foregoing Resolution was adopted by the Commission at its meeting on July 9, 2020.

Jonas P. Ionin

Commission Secretary

AYES: Koppel, Moore, Chan, Diamond, Fung, Imperial, Johnson

NAYS: None

ABSENT: None

ADOPTED: July 9, 2020







JAMESTOWN
CANDLESTICK POINT
SAN FRANCISCO, CA
JUNE 25, 2020



LOCATION MAP

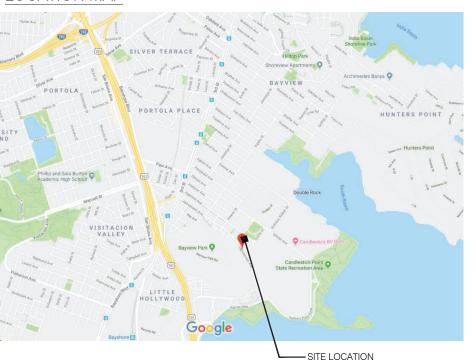

VICINITY MAP

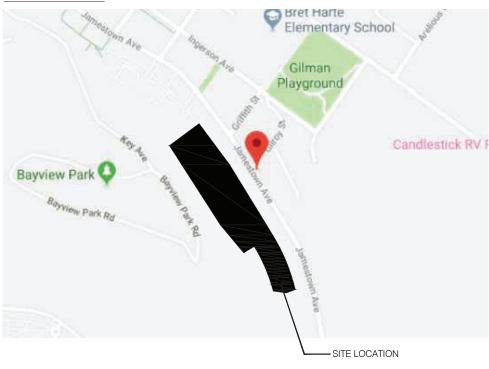

JAMESTOWN

CANDLESTICK POINT

SAN FRANCISCO, CALIFORNIA

PRELIMINARY PROJECT ASSESSMENT APPLICATION
ORIGINAL SUBMITTAL DATE: MARCH 05, 2019
RESUBMITTAL DATE: MARCH 09, 2020
RESUBMITTAL DATE: JUNE 05, 2020
RESUBMITTAL DATE: JUNE 25, 2020



APPLICANT:

STRADA INVESTMENT GROUP

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LANDSCAPE:

EINWILLERKUEHL

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ARCHITECT:

HUNT HALE JONES ARCHITECTS

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COLOR SCHEME B
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COLOR SCHEME B

PROJECT SUMMARY

PROJECT ADDRESS: 853 JAMESTOWN AVE. & HARNEY WAY

ASSESSOR PARCEL NUMBER: BLOCK 4991 LOT 276

ZONING: RH-2

LOT AREA: 299,257 SF. (6.78 ACRES) - BUILDABLE ±3.5 ACRES / 52%

 RESIDENTIAL
 67,162 SF (22%)

 OPEN PARKING & DRIVES
 52,762 SF (17%)

OPEN 972 SF
DRIVES 51,790 SF
USABLE OPEN SPACE (SEE SHEET A2.6 FOR CALCULATIONS)
COMMON (PARK) 4,921 SF
PRIVATE (TERRACES AND DECKS) 8,281 SF

HEIGHT LIMIT: 40'-0" (38'-0" TO 40'-0" PROPOSED)

NO. OF STORIES THREE

PUBLIC (HILLSIDE)

NUMBER OF BLDGS. 20
GROSS SQ.FT. 169,332 SF
NUMBER OF UNITS: 122 UNITS

PLAN 1 - 1,296 SF (3 BD. & 3.5 BTHS): 5 UNITS
PLAN 2 - 1,324 SF (3 BD & 3 BTHS): 18 UNITS
PLAN 3 - 1,527 SF (3 BD & 3.5 BTHS): 18 UNITS
PLAN 4 - 1,279 SF (2 BD & 2.5 BTHS): 27 UNITS
PLAN 5 - 1,279 SF(2 BD & 2.5 BTHS): 13 UNITS
PLAN 6 - 1,289 SF (2 BD & 2.5 BTHS): 13 UNITS
PLAN 7 - 1,605 SF (2 BD & 2.5 BTHS): 28 UNITS

122 UNITS

DENSITY (UNITS PER ACRE): 18 DUA PER TOTAL LOT AREA 35 DUA PER BUILDABLE LOT AREA

PARKING

AUTO: 170 SPACES

- 153 PRIVATE - 17 GUEST (1 ADA)

154,673 SF

BICYCLE: 130

122 PRIVATE (IN GARAGES)8 (CLASS 2 IN PARK)

OCCUPANCY: R2/L

CONSTRUCTION TYPE: V-B (BLDGS. TYPE A & B) V-A (BLDG. TYPE C)

V-A (BLBG. TTT L O)

SPRINKLER: NFPA-13

ACCESSIBILTY:

DWELLING UNITS: 122 - 16 CARRIAGE UNITS = 106 DWELLING UNITS TOTAL 10% OF THE 106 QUALIFYING UNITS TO BE ADAPTABLE: 106 X 0.1 = 10.6 UNITS

11 UNITS REQUIRED; 11 PROPOSED

PARKING: 1 SPACE

PATH OF TRAVEL: BLDGS. 6 THRU 16, PARKING, POCKET PARK & RIGHT OF WAY (SHT. A4.2)

CUT FILL CALCS:

PROPOSED TOTAL CUT: 10,158 CUBIC YARDS PROPOSED TOTAL FILL: 4,903 CUBIC YARDS NET TOTAL CUT: 5, 255 CUBIC YARDS

PROJECT OVERVIEW

PROJECT DESCRIPTION - JAMESTOWN AVENUE (NO ADDRESS BLOCK 4991; LOT 276):

THE SITE IS A 6.865-ACRE PROPERTY WITHOUT AN ADDRESS, LOCATED ALONG JAMESTOWN AVENUE (BLOCK 4991; LOT 276), IN SAN FRANCISCO. THE SITE IS CURRENTLY OCCUPIED BY A SURFACE PARKING LOT THAT SERVED CANDLESTICK PARK UNTIL ITS DEMOLITION IN 2014 AND IS LOCATED IN A RESIDENTIAL HOUSE, TWO-FAMILY (RH-2) USE DISTRICT AND A 40-X HEIGHT AND BULK DISTRICT. THE PROPERTY IS CENTERED ON A QUIET SLOPED HILLSIDE AT THE NEXUS OF THE BAYVIEW HEIGHTS NEIGHBORHOOD AND THE FUTURE 702-ACRE REDEVELOPMENT CURRENTLY UNDERWAY AT CANDLESTICK POINT WHICH WILL BRING UP TO 6,000 NEW RESIDENTIAL UNITS, 300,000 SQUARE FEET OF RETAIL, 2 MILLION SQUARE FEET OF OFFICE, AND 121 ACRES OF OPEN RECREATION SPACE TO THE SURROUNDING CANDLESTICK POINT AND BAYVIEW COMMUNITIES. THE PARCEL IS BORDERED BY MULTI-FAMILY RESIDENTIAL BUILDINGS AT ADJACENT PARCELS.

THE SITE IS LOCATED A HALF MILE FROM THE LE CONTE STOP OF THE T-THIRD STREET METRO LINE, LESS THAN ONE MILE FROM THE BAYSHORE CALTRAIN STATION, AND HAS IMMEDIATE ACCESS TO THE US-101 FREEWAY WHICH WILL OFFER FUTURE RESIDENTS EASY ACCESS TO BOTH DOWNTOWN SAN FRANCISCO AND SILICON VALLEY JOBS. THESE TRANSIT ADJACENCIES AND THE SITE'S RESIDENTIAL SURROUNDINGS COUPLED WITH SAN FRANCISCO'S HOUSING DEFICIT PRESENT AN IDEAL OPPORTUNITY FOR RESIDENTIAL REDEVELOPMENT.

THE PLAN CONFORMS TO THE EXISTING RH-2 ZONING AND CALLS AN ADDENDUM TO THE PREVIOUSLY APPROVED 2010 CANDLESTICK POINT-HUNTERS POINT SHIPYARD PHASE II DEVELOPMENT PLAN PROJECT EIR (THE "CANDLESTICK EIR"), AMONG OTHER APPROVALS.

PROPOSED REDEVELOPMENT:

THE PROPOSED REDEVELOPMENT ENVISIONS THE CONSTRUCTION OF 122, 3-STORY ATTACHED TOWNHOME STYLE RESIDENCES TOTALING 160,434 SF. THE COMMUNITY OF 20 NEW BUILDINGS WOULD BE INTERSPERSED WITH OPEN SPACE, INCLUDING A NEW CENTRAL COMMUNITY PARK AND PLAY AREA, AND SEVERAL GARDEN PASEOS THAT WOULD CONTRIBUTE TO AND ENHANCE THE EXISTING RESIDENTIAL COMMUNITY THAT SURROUNDS THE PROPERTY TODAY.

THE PROPOSED TOWNHOME-STYLE CONDOMINIUMS ARE SIMILAR IN STYLE, SIZE, AND DENSITY TO THE EXISTING TOWNHOME COMMUNITIES THAT IMMEDIATELY NEIGHBOR THE SITE AS WELL AS THOSE AT THE NEARBY SHIPYARDS DEVELOPMENT. THE TOWNHOMES WOULD RANGE FROM APPROXIMATELY 1,100 TO 1,550 SQUARE FEET WITH 67% OF HOMES WITH TWO BEDROOMS, TWO-AND-A-HALF BATHS AND 23% OF HOMES WITH THREE BEDROOMS, THREE-AND-A-HALF BATHS AND WOULD PROVIDE A RARE OWNERSHIP OPPORTUNITY SUITABLE TO FIRST-TIME SAN FRANCISCO HOME BUYERS. ADDITIONALLY, APPROXIMATELY TWO-THIRDS OF THE HOMES WOULD INCLUDE PRIVATE ROOF DECKS AND/OR BALCONIES.

COMMUNITY AMENITIES/LANDSCAPE:

TO ENHANCE THE PROJECT AND NEIGHBORING COMMUNITY, THE PROJECT ENVISIONS CREATING CENTRAL GATHERING SPACES THAT WILL CAPITALIZE ON SURROUNDING VIEWS OF THE BAY AS WELL AS ACTIVATING THE PREVIOUSLY NEGLECTED SPAN OF JAMESTOWN AVENUE FRONTING THE SITE WITH NEW HARDSCAPE AND PLANTING. ADDITIONALLY, A LANDSCAPED LANDING AT THE SOUTHERNMOST PORTION OF THE PROPERTY WILL PROVIDE A FLUID CONNECTION TO FUTURE PARKS AND OPEN SPACE PLANNED BY THE DEVELOPER OF CANDLESTICK POINT. THE .14 ACRE CENTRAL COMMUNITY PARK WILL BE A PRIVATELY OWNED AND MAINTAINED SPACE WITH A PERMANENT PUBLIC ACCESS EASEMENT, ADDING NO ADDITIONAL COSTS TO THE CITY'S PARKS MAINTENANCE BUDGET.



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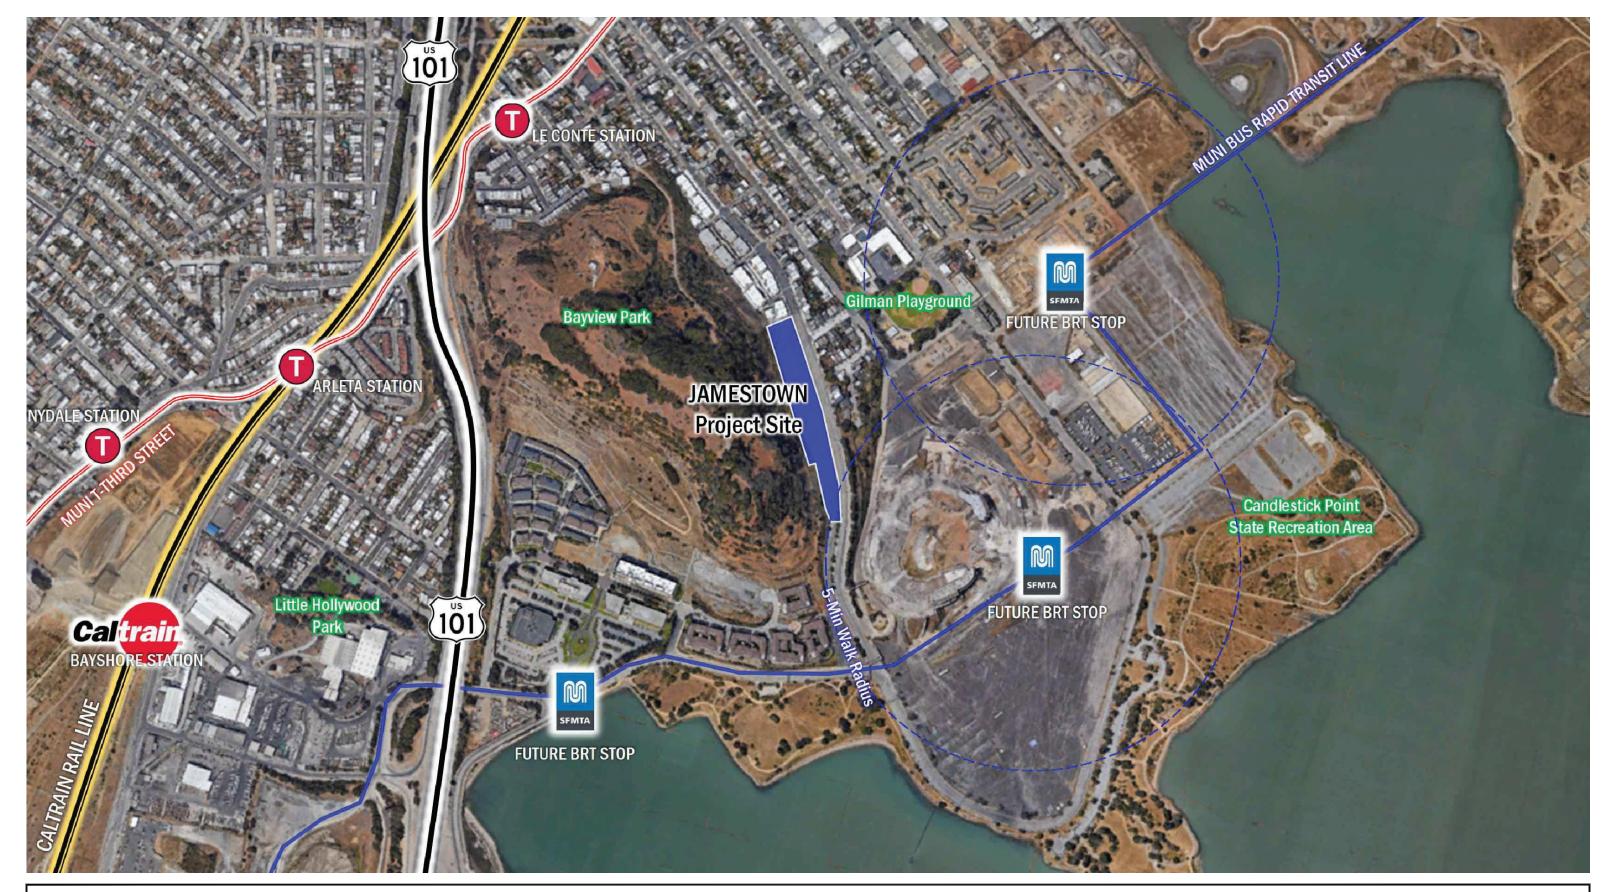
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PROJECT SUMMARY & PROJECT DESCRPTION

PRELIMINARY PROJECT ASSESSMENT APPLICATION
ORIGINAL SUBMITTAL DATE: MARCH 05, 2019
RESUBMITTAL DATE: MARCH 09, 2020
RESUBMITTAL DATE: JUNE 05, 2020
RESUBMITTAL DATE: JUNE 25, 2020

AT.U

DATE: 06.25.2020 PROJECT: 348001





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EXISTING HUNTERS POINT CONTEXTUAL SITE LOCATION

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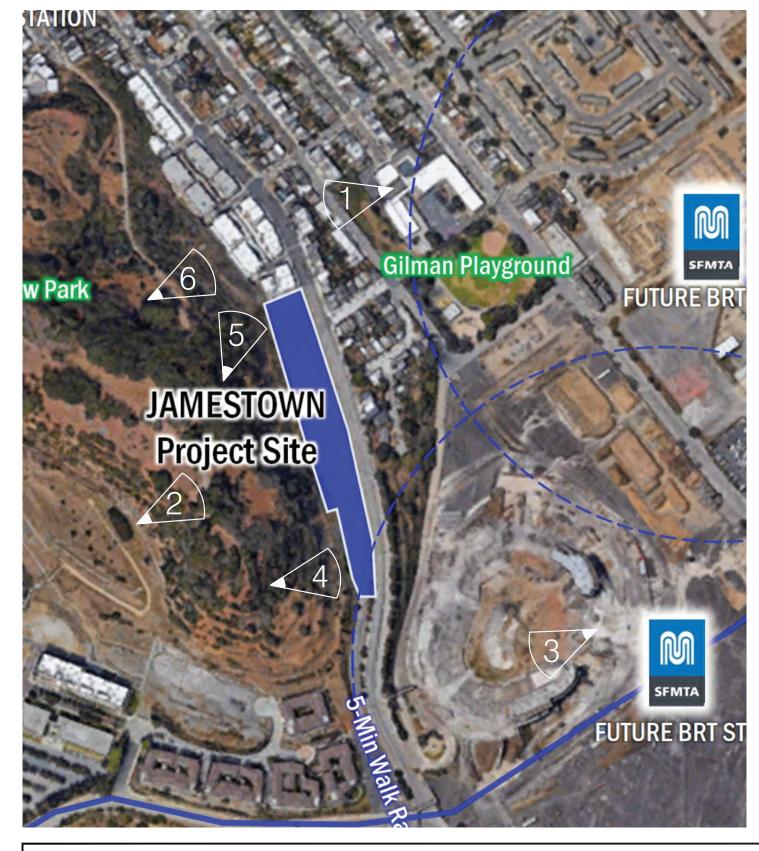
RESUBMITTAL DATE: MARCH 09, 2020
RESUBMITTAL DATE: JUNE 05, 2020
RESUBMITTAL DATE: JUNE 25, 2020

A1.1

SCALE: 1"=300'-0"

DATE: 06.25.2020

PROJECT: 348001





VIEW TOWARD DOWNTOWN 6



ADJACENT BUILDINGS TO THE NORTH 1



VIEW ACROSS STREET 5



VIEW ACROSS JAMESTOWN 2



VIEW TOWARD DOWNTOWN 4



PROPOSED DEVELOPMENT AT BALLPARK SITE 3



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CONTEXTUAL SITE PHOTOS

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A1.2

SCALE: 1"=200'-0" DATE: 06.25.2020 PROJECT: 348001





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FUTURE HUNTERS POINT CONTEXTUAL DIAGRAM

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MARCH 09, 2020 JUNE 25, 2020

A1.3

SCALE: 1"=100'-0" DATE: 06.25.2020 PROJECT: 348001



NORTH ENRTY FROM JAMESTOWN



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RENDERINGS

A1.4

SCALE: N.T.S.

DATE: 06.25.2020
PROJECT: 348001



GARDEN PASEO



VIEW FROM JAMESTOWN





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JUNE 25, 2020

RENDERINGS

SCALE: DATE: 06.25.2020 PROJECT: 348001



DOWNHILL VIEW



COMMUNITY PARK & CENTRAL DRIVE AISLE

JAMESTOWN CANDLESTICK POINT SAN FRANCISCO, CA



PART II
PROPOSED SITE DETAILS

BUILDING SUMMARY BLDGS. 1, 4 & 5 (9 UNITS) PLAN 1 LIVING 1.29

PLAN 1 LIVING 1,296 SF. X 1 = 1,296 SF. PLAN 2 LIVING 1,324 SF. X 4 = 5,296 SF. PLAN 3 LIVING 1,527 SF. X 4 = 6,108 SF.

T2,700 SF. X 3 BLDGS. = 38,100 GROSS SF. BLDGS. 2 & 3 (7 UNITS)

PLAN 1 LIVING 1,296 SF. x 1 = 1,296 SF.

PLAN 1 LIVING 1,296 SF. x 1 = 1,296 SF.
PLAN 2 LIVING 1,324 SF. x 3 = 3,972 SF.
PLAN 3 LIVING 1,527 SF. x 3 = 4,581 SF.
9,849 SF. x 2 BLDGS. = 19,698 GROSS SF.

BLDGS. 6 & 7 (4 UNITS) PLAN 5 LIVING 1,279 SF. x 2 = 2,558 SF.

PLAN 6 LIVING 1,289 SF. x 2 = $\frac{2,578 \text{ SF.}}{5,136 \text{ SF.}}$ x 2 BLDGS. = 10,272 GROSS SF.

BLDGS. 8 THRU 16 (5 UNITS)

PLAN 4 LIVING 1,279 SF. x 3 = 3,837 SF.

PLAN 5 LIVING 1,279 SF. x 1 = 1,132 SF.

PLAN 6 LIVING 1,289 SF. x 1 = 1,289 SF.

6,258 SF. x 9 BLDGS. = 56,322 GROSS SF.

BLDGS. 17 & 18 (8 UNITS)

PLAN 7 LIVING 1,605 SF. x 8 = 12,840 SF. x 2 BLDGS. = 25,680 GROSS SF.

BLDGS. 19 & 20 (6 UNITS)

PLAN 7 LIVING 1,605 SF. x 6 = 9,630 SF. x 2 BLDGS. = 19,260 GROSS SF.

TOTAL LIVING = 169,332 GROSS SF

BUILDING DESCRIPTIONS

BLDGS. 1 THRU 5: TYPE A (41 UNITS)- 1 THRU 41

FOOTAGE 1,296 - 1,527 SF\UNIT STORIES THREE

BED & BATH 3 BEDRM & $3\frac{1}{2}$ BATHS PARKING 18 SPACES - 44% 2 CAR SIDE BY SIDE

23 SPACES - 56% 1 CAR
FEATURES OPTIONAL ROOF DECK

BLDGS. 6 THRU 16: TYPE B (53 UNITS)- 42 THRU 94

FOOTAGE 1,279 - 1,289 SF STORIES THREE

BED & BATH 2 BEDRM & 2 1/2 BATHS

PARKING 13 SPACES - 24% 2 CAR SIDE BY SIDE

40 SPACES - 76% 1 CAR
FEATURES OPTIONAL ROOF DECK

BLDGS. 17 THRU 20: TYPE C (28 UNITS)- 95 THRU 122

FOOTAGE 1,605 - 2,428 SF. STORIES THREE

BED & BATH 2 BEDRM & 2 ½ BATHS
PARKING 28 SPACES - 100% 1 CAR

SITE LEGEND

1. BLDG. TYPE A - BLDGS. 1 THRU 5 3 STORY, TYPE VB, NFPA 13

2. BLDG. TYPE B - BLDGS. 6 THRU 16 3 STORY, TYPE VB, NFPA 13 W/ ACCESSIBLE GROUND FLOOR AT LOCATIONS SHOWN

3. BLDG. TYPE C - BLDGS. 17 THRU 20 4 STORY, TYPE VA, NFPA 13

4. RETAINING WALL

GUEST PARKING (15 TOTAL)

6. PARKING DRIVE AISLE

7. COMMON USE PASEOS

8. VEHICULAR ENTRY

9. RIDE SHARE PARKING STALL

10. ACCESSIBLE PARKING STALL


11. TRASH ENCLOSURE

12. ACCESSIBLE ROUTES

13. CLASS 2 BIKE PARKING (15 SPACES)

4. E.V. CHARGING STATION (NOTE - INTERIOR OF ALL UNIT GARAGES TO PROVIDE CHARGING CAPABILITY)

. BIKE REPAIR STATION

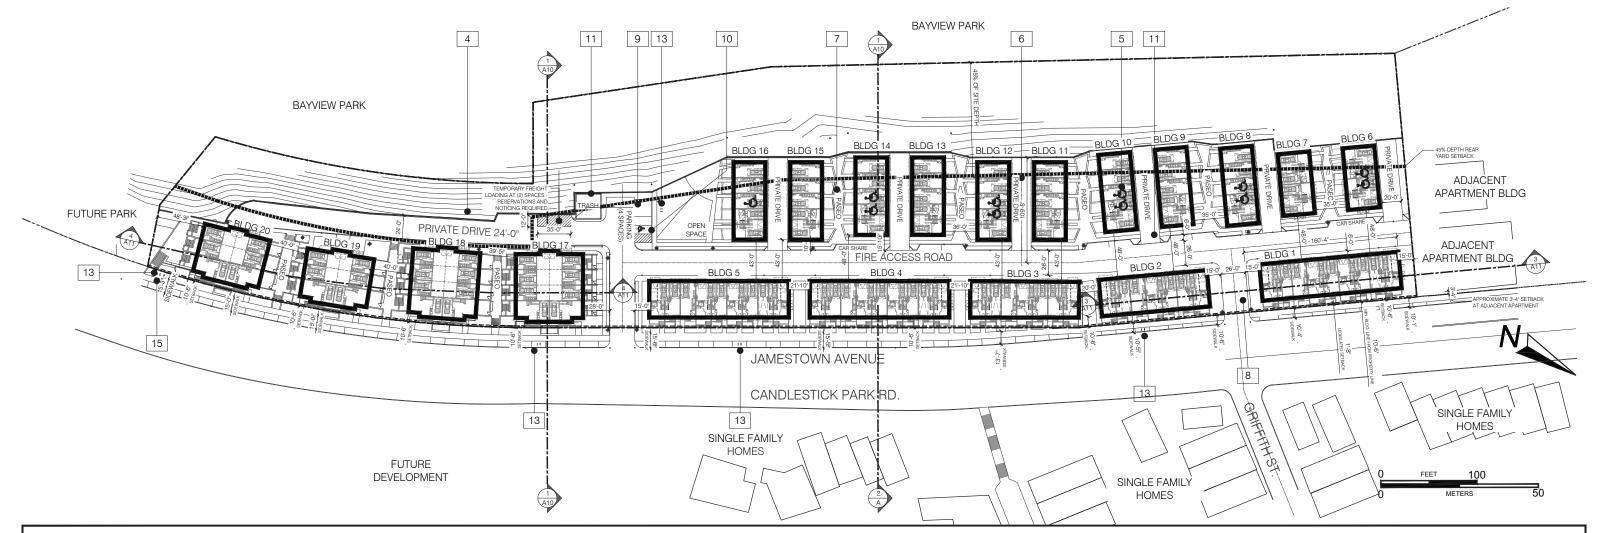



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ARCHITECTURAL SITE PLAN

PRELIMINARY PROJECT ASSESSMENT APPLICATION
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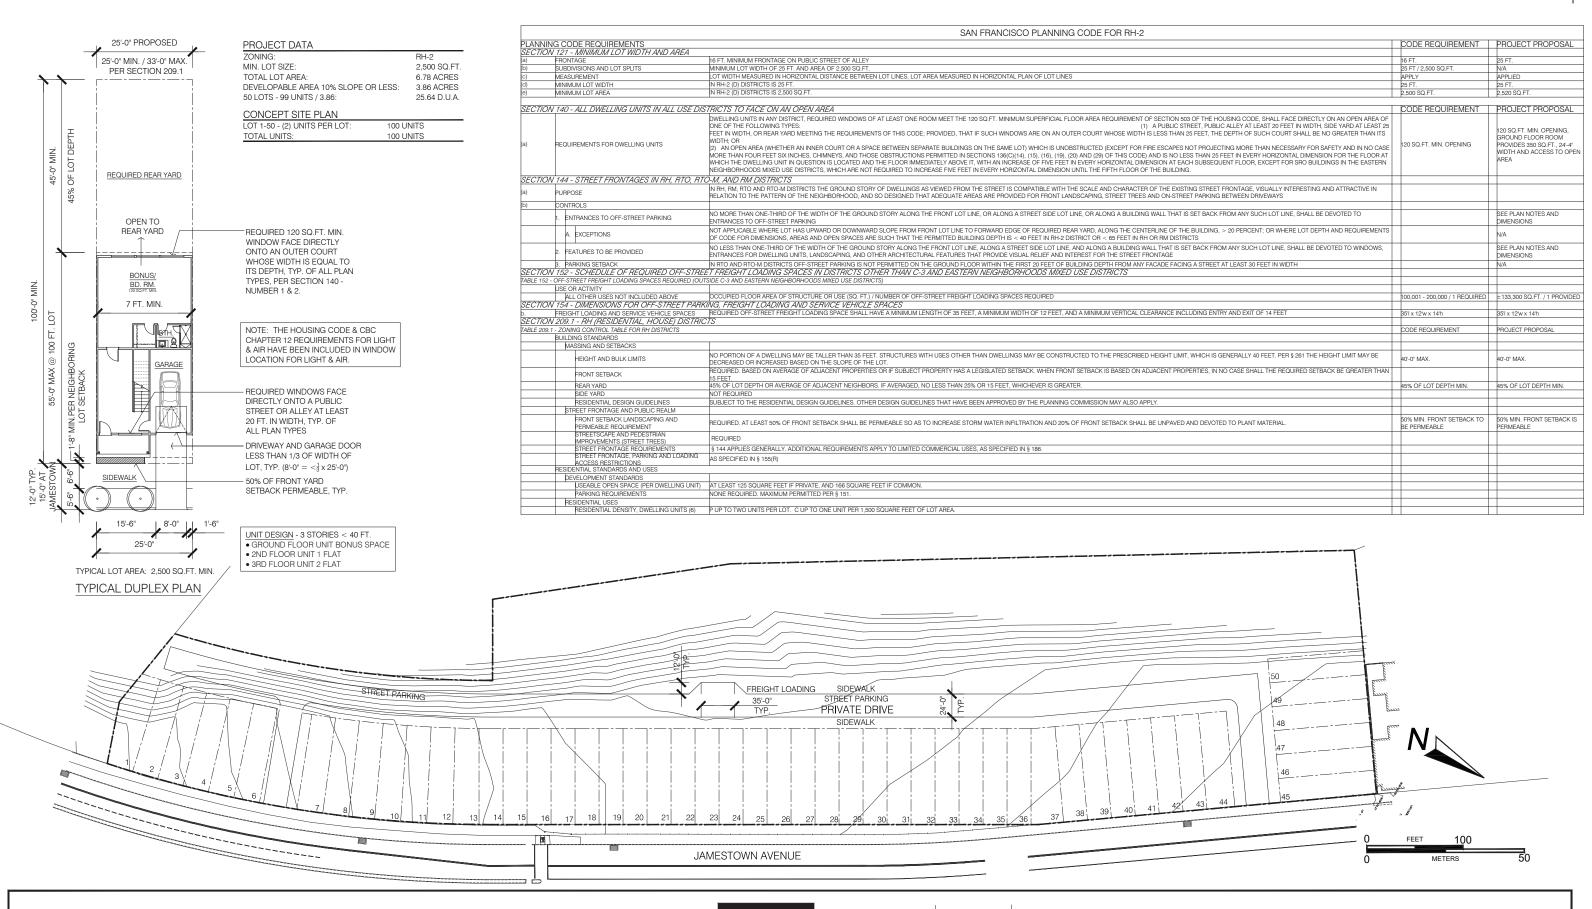
JUNE 25, 2020

RESUBMITTAL DATE:

SCALE: 1"=50'-0"

DATE: 06.25.2020

PROJECT: 348001





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STATE DENSITY BONUS BASE SITE PLAN

JUNE 25, 2020

PRELIMINARY PROJECT ASSESSMENT APPLICATION
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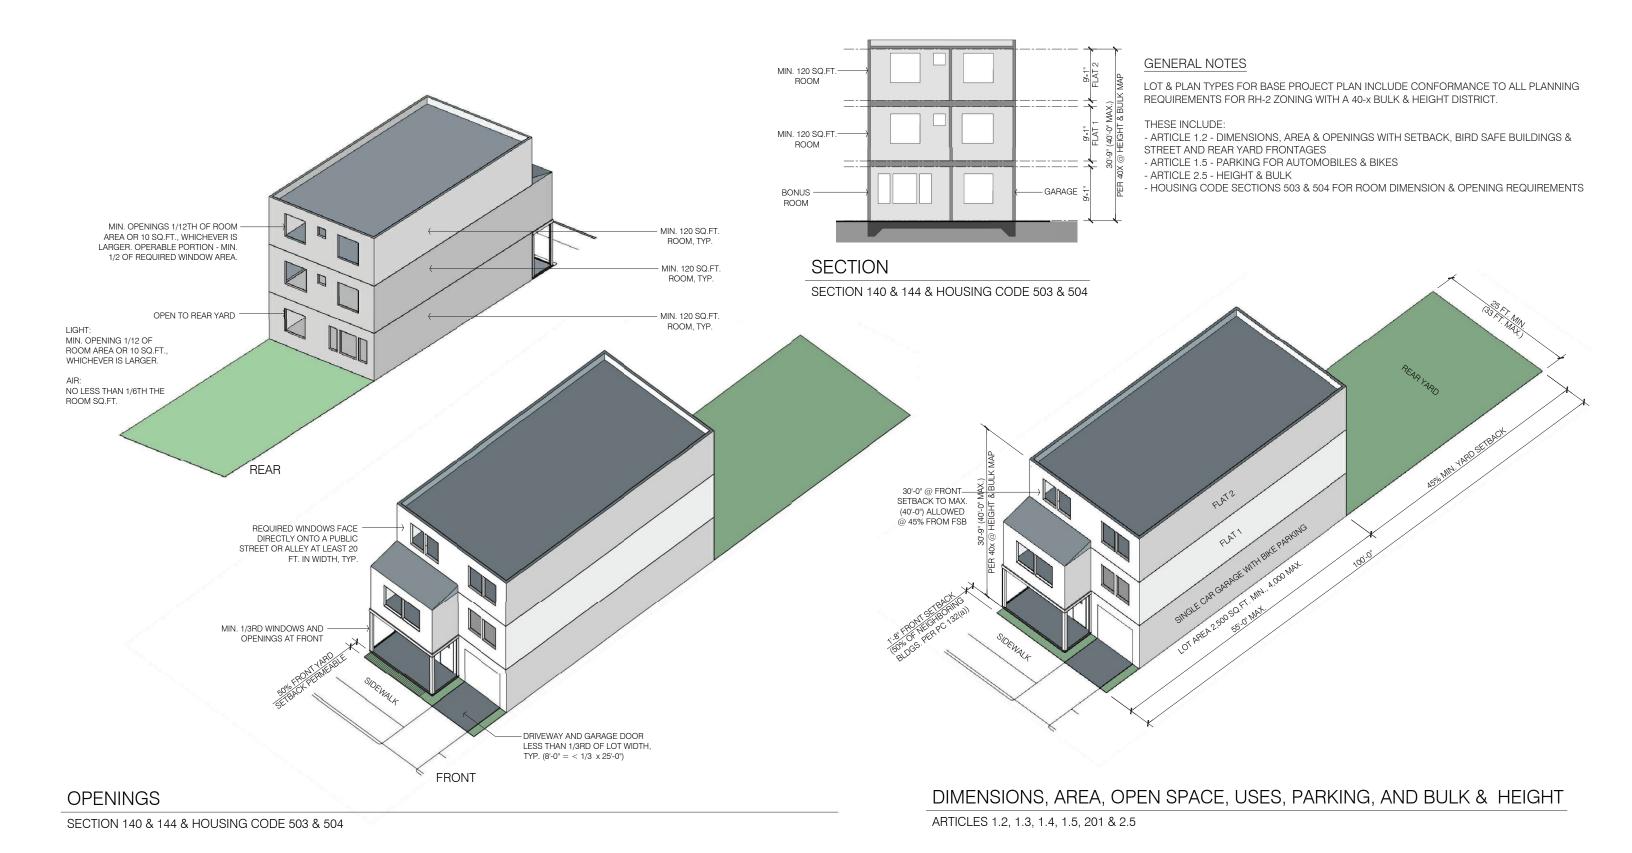
RESUBMITTAL DATE:

A2.1

SCALE: 1"=50'-0"

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STATE DENSITY BONUS BASE PROJECT PLAN DIAGRAMS

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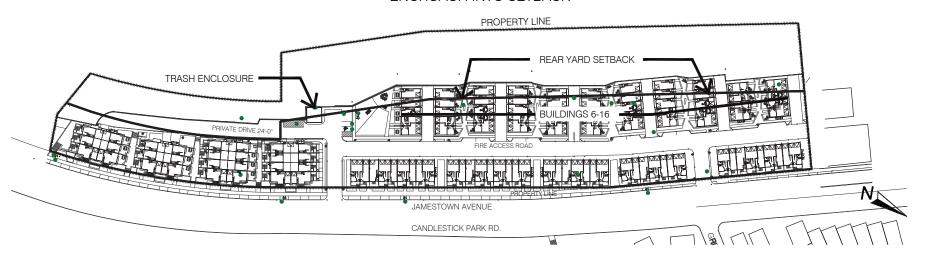
A2.2

SCALE: 1/8"=1'-0" DATE: 06.25.2020 PROJECT: 348001

INDIVIDUALLY REQUESTED STATE DENSITY BONUS PROGRAM

1. PC 134 - REAR YARD REQUIREMENT: WAIVER

- 1. REAR YARD REQUIRED TO BE 45% OF LOT DEPTH
- 1.1. 45% OF LOT DEPTH SETBACK INDICATED AT DASHED LINE
- 2. BUILDINGS 6-16 AND TRASH ENCLOSURE ENCROACH INTO SETBACK



PLANNING CODE SECTION 134 - REAR YEAR REQUIREMENT. BUILDINGS 1-16 ENCROACH ON THE PROJECT'S REQUIRED SETBACK. IF CONSIDERED INDIVIDUALLY, THE STANDARD FOR OPEN SPACE AT EACH UNIT IS MET, BUT WITHOUT A WAIVER OF THE PLANNING CODE SECTION 134 REAR YARD REQUIREMENT THE PROJECT WOULD NOT BE ABLE TO ACCOMMODATE THE ADDITIONAL PERMITTED DENSITY.



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WAIVERS, CONCESSIONS & INCENTIVES

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A2.3


SCALE:1/16" = 1'-0" DATE: 06.25.2020 PROJECT: 348001

1. PC SEC. 144 STREET FRONTAGE: CONCESSIONS AND INCENTIVES

AT BUILDINGS 1 THRU 16

1. PLANNING CODE SECTION 144 - STREET FRONTAGES IN RH, RTO, RTO-M, AND RM DISTRICTS. THE STREET FRONTAGE REQUIREMENT FOR THIS SITE REQUIRES THAT NO MORE THAN 1/3RD OF THE WIDTH OF THE GROUND STORY BE DEVOTED TO OFF-STREET PARKING, WHILE AT LEAST 1/3RD OF THE WIDTH OF THE GROUND STORY MUST BE DEVOTED TO WINDOWS, ENTRANCES, LANDSCAPING OR OTHER ARCHITECTURAL FEATURES. ACCOMMODATING A STANDARD OFF-STREET VEHICLE ENTRANCE AT ONE-THIRD OF THE PROPOSED BUILDINGS WOULD REDUCE THE TOTAL AMOUNT OF BUILDINGS DUE TO EACH BUILDING'S INCREASED WIDTH. THIS REDUCED NUMBER OF BUILDINGS CANNOT ACCOMMODATE THE ADDITIONAL PERMITTED DENSITY. FURTHER, POOLING PARKING FOR THE INDIVIDUAL UNITS TOGETHER WOULD REMOVE SPACE ON THE GROUND FLOOR NEEDED TO ACCOMMODATE THE ADDITIONAL PERMITTED DENSITY.

THIS INCENTIVE WILL RESULT IN IDENTIFIABLE AND ACTUAL COST REDUCTIONS TO PROVIDE FOR THE PROJECT'S AFFORDABLE HOUSING COSTS. CRITICALLY, THE STREET FRONTAGE IS NECESSARY TO REDUCE THE COST BURDEN OF THE AFFORDABLE UNITS ON THE PROJECT SO THAT THE PROJECT CAN ATTRACT COMMERCIALLY REASONABLE FINANCING. AN INCENTIVE TO MAKE A PROJECT AS A WHOLE, INCLUDING THE AFFORDABLE HOUSING UNITS, ECONOMICALLY FEASIBLE IS A WELL-ESTABLISHED USE OF AN INCENTIVE. (WOLLMER V. CITY OF BERKELEY (2009) 179 CAL.APP.4TH 933, 945-46.) SUBTERRANEAN PARKING WOULD BE REQUIRED IN ORDER TO REDUCE THE AMOUNT OF THE GROUND FLOOR DEVOTED TO OFF-STREET GARAGE PARKING ENTRANCES. SUBTERRANEAN PARKING WOULD CALLING FOR A SINGLE INGRESS AND EGRESS GARAGE DOOR FOR EACH BUILDING WOULD CALL FOR SUBSTANTIAL GRADING. IN TOTAL, THE ADDITIONAL COST TO BUILDING SUBTERRANEAN PARKING FOR 41 UNITS AT BUILDINGS 1-5 AT 80,000 PER PARKING STALL WOULD INCREASE THE PROJECT COST BY \$3.28 MILLION.

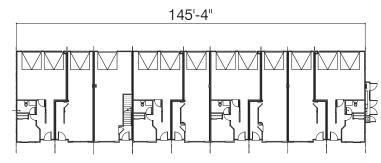

CURRENTLY PROPOSED 9 PLEX NON COMPLIANT PER SECTION 144



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WAIVERS, CONCESSIONS & INCENTIVES

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A2.4

SCALE:1/16" = 1'-0" DATE: 06.25.2020 PROJECT: 348001

ACCESSIBILITY SUMMARY

REQUIRED NUMBER OF UNITS - CBC CHPT. 1102A.3 10% OF QUALIFYING UNITS = 10% OF 91 UNITS = 9.1 = 10 UNITS LOCATIONS ALONG BLDGS. 'TYPE B', PENDING FINAL GRADING PLAN

REQUIRED PARKING - CBC CHPT. 1109A.1 SPACES:


2% OF ASSIGNED SPACES CBC CHPT. 1109A.3= 2% OF 163 SPACES = 4 SPACES 5% OF UNASSIGNED SPACES CBC CHPT. 1109A.5= 5% OF 17 SPACES = 1 SPACE

REQUIRED ROUTES -PARKING - CBC CHPT. 1109A.7 EXTERIOR - CBC CHPT, 1110A.1

PUBLIC & COMMON SPACES - CBC CHPT. 11B-101.1

SITE LEGEND

- BLDG. TYPE A BLDGS. 1 THRU 5 3 STORY, TYPE VB, NFPA 13
- 2. BLDG. TYPE B BLDGS. 6 THRU 16 3 STORY, TYPE VB, NFPA 13 W/ ACCESSIBLE GROUND FLOOR AT LOCATIONS SHOWN
- BLDG. TYPE C BLDGS. 17 THRU 20 4 STORY, TYPE VA, NFPA 13
- **RETAINING WALL**
- **GUEST PARKING (15 TOTAL)**
- PARKING DRIVE AISLE
- COMMON USE PASEOS
- VEHICULAR ENTRY
- RIDE SHARE PARKING STALL
- ACCESSIBLE PARKING STALL
- TRASH ENCLOSURE
- ACCESSIBLE ROUTES
- 13. CLASS 2 BIKE PARKING (15 SPACES)
- 14. E.V. CHARGING STATION (NOTE INTERIOR OF ALL UNIT GARAGES TO PROVIDE CHARGING CAPABILITY)

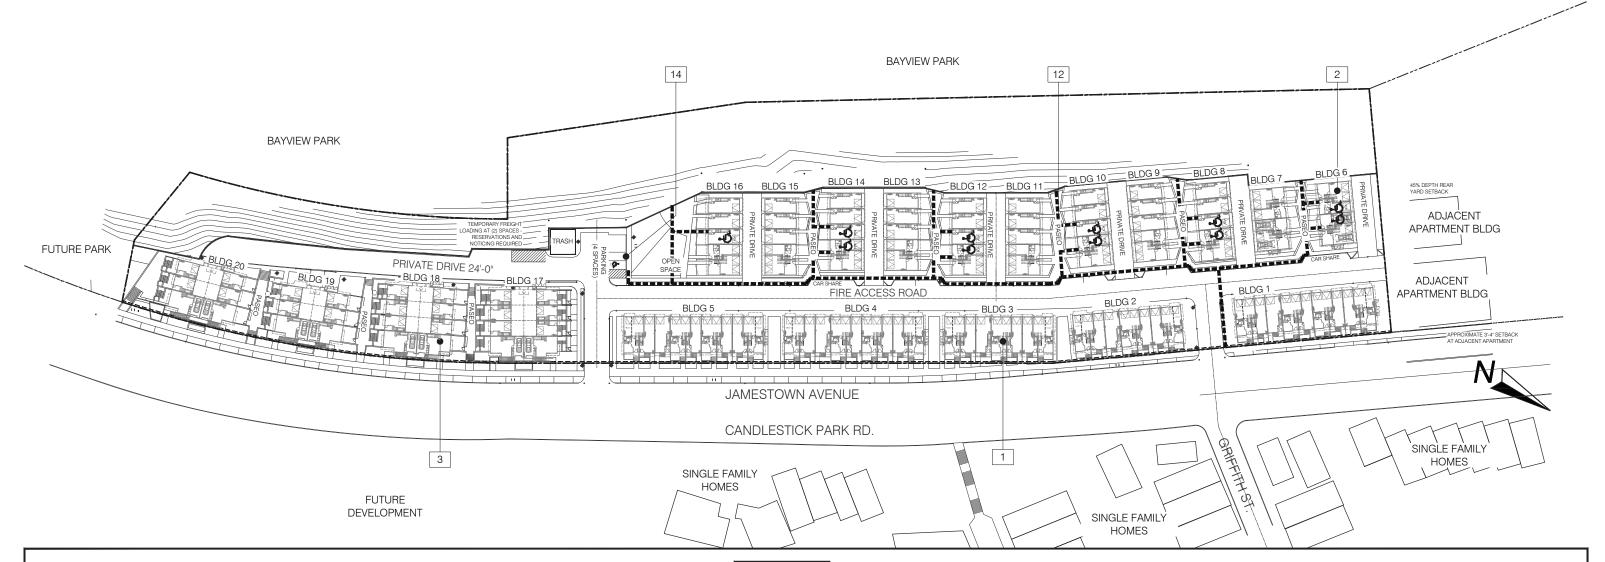



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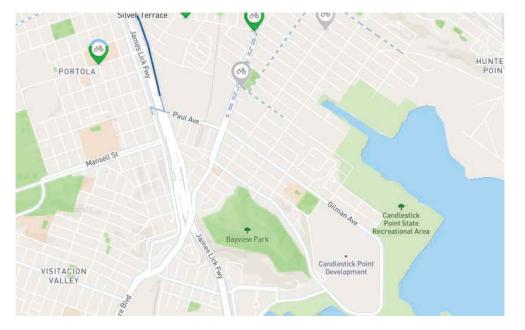
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ADA SITE PLAN

SCALE: 1"=50'-0"

DATE: 06.25.2020 PROJECT: 348001



BIKE SHARE STATIONS


LEGEND

PARKING



ACCESSIBLE

CAR SHARE

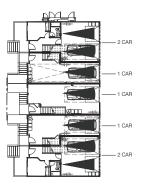

TYP. BLDG.

PARKING SUMMARY

MAX. ALLOWED:

1.5/ UNIT

 $\overline{122 \text{ UNITS}} = \overline{153 \text{ CARS}}$

- 122 UNITS x 1.5 = 183 SPACES

SUMMARY:

PRIVATE (ASSIGNED): 153 SPACES


PLAN # # CARS 5 UNITS = 5 CARS 18 UNITS = 18 CARS PLAN 1 -1 CAR PLAN 2 -1 CAR PLAN 3 -2 CARS 18 UNITS = 36 CARS 27 UNITS = 27 CARS 13 UNITS = 13 CARS PLAN 4 -1 CAR 1 CAR PLAN 5 -13 UNITS = 26 CARS 28 UNITS = 28 CARS PLAN 6 -2 CARS PLAN 7 - 1 CAR

GUEST (UNASSIGNED): 17 SPACES = 8% ACCESSIBLE = 1 SPACE CAR SHARE = 2 SPACE = 14 SPACES GENERAL

TOTAL PARKING: 170 SPACES PROVIDED

BIKE PARKING

C1 TYPE WITHIN UNIT: C2 TYPE ON SITE: C2 TYPE OFF SITE - ON JAMESTOWN, SEE LANDSCAPE PLAN: 36
(SEE L5.0 PROJECT DIAGRAMS FOR DETAILS)

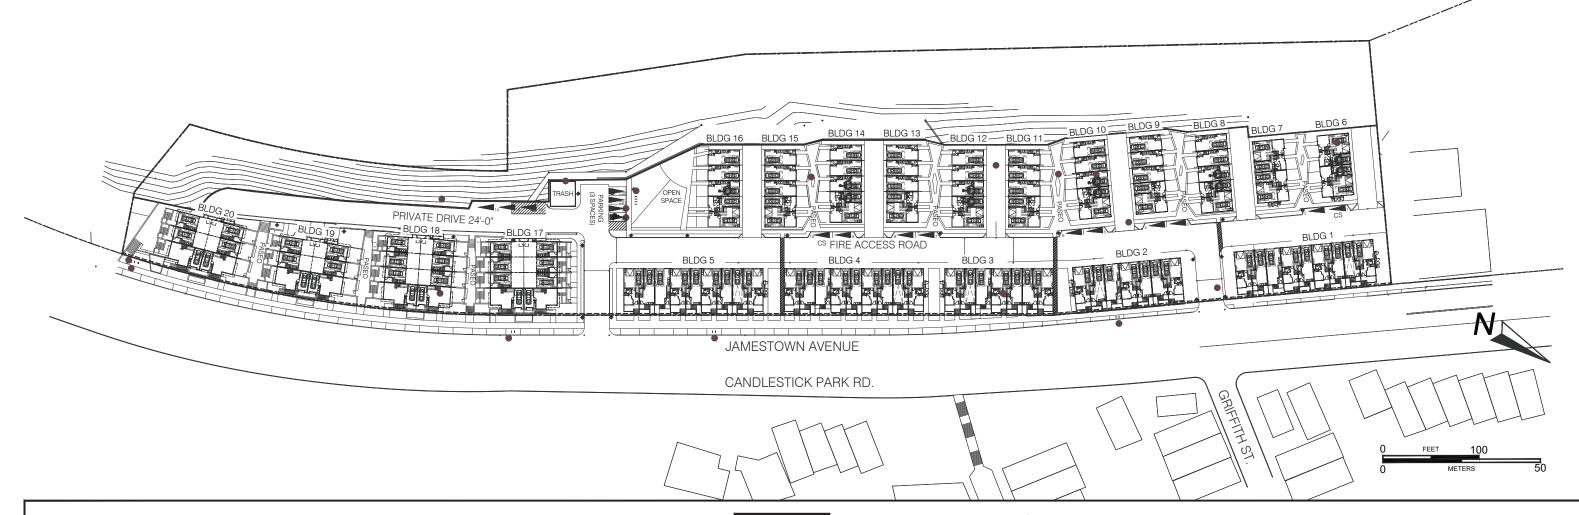



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PARKING DIAGRAM

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SITE PLAN



COMMON OPEN SPACE 1 - DETAIL PLAN

LOT COVERAGE BY TYPE

TOTAL LOT AREA: TOTAL BUILDABLE LOT AREA


> RESIDENTIAL BLDG. PARKING AREA OPEN PARKING DRIVE AISLE

TOTAL HARDSCAPE: BUILDIABLE OPEN SPACE AREA: 299,257 SF. (6.78 ACRES) (±3.5 ACRES), 152,460 SQ.FT.

67,162 SF (22.5%) 52,762 SF (17.5%) 972 SÉ 51,790 SF

119,924 SQ.FT. (40%) 167,517 SQ. FT. (60%)

COMMON OPEN SPACE

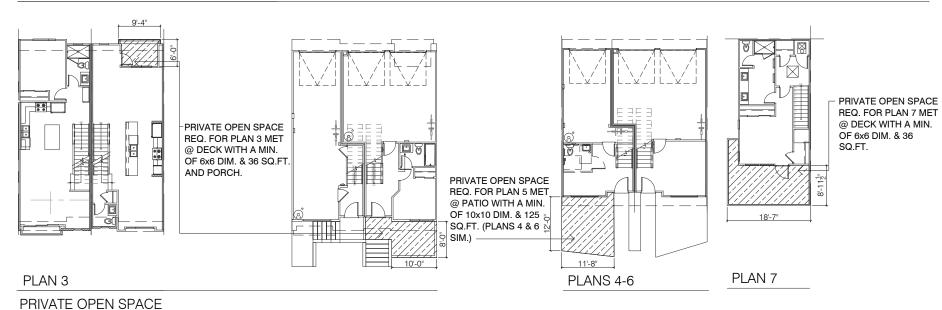

OPEN SPACE / PRIVATE OPEN SPACE (PER SECTION 135)

USABLE OPEN SPACE (PER SECTION 135 D, 1 & TABLE 135A):

USABLE OPEN SPACE IS ACHIEVED W/ BOTH COMMON & PRIVATE OPEN SPACE. SEE BELOW FOR CODE SPECIFIC REQUIREMENTS.

A. PRIVATE USABLE OPEN SPACE: (SEE UNIT AND BUILDING PLANS.)

- 99 UNITS PROVIDE PRIVATE OPEN SPACE PER ZONING CODE

(46) UNITS W/ BALCONIES AND PORCHES MEET OR EXCEED REQUIRED 6x6 & 36 SQ.FT. MIN. (53) UNITS W/ GROUND FLOOR PATIOS MEET OR EXCEED REQUIRED 10x10 & 125 SQ.FT. MIN.

PLAN	# UNITS	QUALIFYING BALCONY/DECK	GROUND FLR PRIVATE OPEN SPACE	SUPPLEMENTAL OPEN SPACE
1	(5)			830 SQ.FT.
2	(18)			2,988 SQ.FT.
3	(18)	147 SQ.FT.		N/A
4,5 & 6	(53)		125 SQ.FT. MIN.	N/A
7	(28)	36 SQ.FT. MIN.		N/A

COMMON USABLE OPEN SPACE: (SEE SITE PLAN)

1. (23) UNITS ARE USING COMMON OPEN SPACE TO PROVIDE USABLE OPEN SPACE REQUIREMENT.

- PLAN 1 & 2 @ BLDG.'s 1-5 WILL REQUIRE COMMON OPEN SPACE

2. REQUIRED OPEN SPACE

- (23 UNITS)(1.33)(125 SQ.FT)=3,818 SQ.FT.

3. PROPOSED COMMON OPEN SPACE

- SEE SITE PLAN & COMMON OPEN SPACE DIAGRAMS 1 & 2

	USABLE OPEN SPACE SUMMARY - SECTION 135							
USABLE OPEN SPACE - SECTION 135 (d) (1):			REQUIRED	PROPOSED				
d.	BUILDIN	T REQUIRED - USABLE OPEN SPACE SHALL BE PROVIDED FOR EACH IG IN THE AMOUNTS SPECIFIED HEREIN AND IN TABLES 135A AND B FOR ITRICT IN WHICH THE BUILDING IS LOCATED; PROVIDED.						
	1.	FOR DWELLINGS OTHER THAN THOSE SPECIFIED IN PARAGRAPHS (d)(2) THROUGH (d)(5) BELOW, THE MINIMUM AMOUNT OF USABLE OPEN SPACE TO BE PROVIDED FOR USE BY EACH DWELLING UNIT SHALL BE AS SPECIFIED IN THE SECOND COLUMN OF TABLE 135A IF SUCH USABLE OPEN SPACE IS ALL PRIVATE. WHERE COMMON USABLE OPEN SPACE IS USED TO SATISFY ALL OR PART OF THE REQUIREMENT FOR A DWELLING UNIT, SUCH COMMON USABLE OPEN SPACE SHALL BE PROVIDED IN AN AMOUNT EQUAL TO 1.33 SQUARE FEET FOR EACH ONE SQUARE FOOT OF PRIVATE USABLE OPEN SPACE SPECIFIED IN THE SECOND COLUMN OF TABLE 135A. IN SUCH CASES, THE BALANCE OF THE REQUIRED USABLE OPEN SPACE MAY BE PROVIDED AS PRIVATE USABLE OPEN SPACE, WITH FULL CREDIT FOR EACH SQUARE FOOT OF PRIVATE USABLE OPEN SPACE SO PROVIDED.						
MINIMO	IM USA	ABLE OPEN SPACE FOR DWELLING UNITS AND GROUP						
HOUSII	NG OU	TSIDE THE EASTERN NEIGHBORHOODS MIXED USE						
DISTRIC	<u> ÇT - TA</u>	B <u>LE 135A:</u>						
	RH-2	SQUARE FEET OF USABLE OPEN SPACE REQUIRED FOR EACH DWELLING UNIT IF ALL PRIVATE	125 SQ.FT.	53 UNITS (IN BUILDINGS 6 - 16) @ 125 SQ.FT. EACH = 6,625 SQ.FT.				
			36 SQ.FT.	46 UNITS (IN BUILDINGS 1-5 & 17-20 @ 36 SQ.FT. EACH = 1,656 SQ.FT.				
	RH-2	RATIO OF COMMON USABLE OPEN SPACE THAT MAY BE SUBSTITUTED FOR PRIVATE	(1.33) x 125 SQ.FT.	23 UNITS @ 166 SQ.FT. EACH = 3,818 SQ.FT.				
,	DD1 (4.75	THOARLE OREN ORAGE ARRITIONAL OTANICARRO						
Г.	PRIVATE	USABLE OPEN SPACE: ADDITIONAL STANDARDS						
	1.	MINIMUM DIMENSIONS AND MINIMUM AREA. ANY SPACE CREDITED AS PRIVATE USABLE OPEN SPACE SHALL HAVE A MINIMUM HORIZONTAL DIMENSION OF SIX FEET AND A MINIMUM AREA OF 36 SQUARE FEET IF LOCATED ON A DECK, BALCONY, PORCH OR ROOF, AND SHALL HAVE A MINIMUM HORIZONTAL DIMENSION OF 10 FEET AND A MINIMUM AREA OF 100 SQUARE FEET IF LOCATED ON OPEN GROUND, A TERRACE OR THE SURFACE OF AN INNER OR OUTER COURT.						
		DECKS - MIN. 6 FT. HORIZONTAL	6 FT.	SEE PLANS				
		GROUND - MINIMUM 10 FT. HORIZONTAL	10 FT.	SEE PLANS				
	COMMC	ON USABLE OPEN SPACE						
		MINIMUM 15 FT. IN EVERY DIRECTION		SEE PLANS				



JAMESTOWN CANDLESTICK POINT SAN FRANCISCO, CA

PARK COMMON OPEN SPACE 2 - DETAIL PLAN



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ON SITE OPEN SPACE DIAGRAM

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SCALE: 1"=100'-0" DATE: 06.25.2020

PROJECT: 348001



FRONT ELEVATION



REAR ELEVATION



SIDE ELEVATION

W/O UTILITY CLOSETS




STANDARDS FOR BIRD-SAFE BUILDINGS - SECTION 139

- 1. LOCATION RELATED STANDARDS, SECTION 139 (c) (1)
 - BUILDINGS LOCATED INSIDE OPEN SPACES 2 ACRES AND LARGER DOMINATED BY VEGETATION (URBAN BIRD REFUGE)
 - PROJECT IS IN URBAN BIRD REFUGE
 - EXEMPT PROPOSED PROJECT PER SECTION 139 (c) (3) (A) (i)
 - LESS THAN 45 FT. IN HEIGHT
 - LESS THAN 50% GLAZING PER WALL

LIGHTING, SECTION 139 (c) (1) (B)

- EXTERIOR LIGHTING TO BE MINIMAL AND NIGHT-SKY DOWNLIGHTS ONLY
- SEE NOTE AT MATERIALS LEGEND
- 2. FEATURE RELATED STANDARDS, SECTION 139 (c) (2)
 - APPLIED TO BUILDING FEATURES WITH UNBROKEN GLAZED SEGMENTS OF 24 SQ.FT. OR GREATER
 - EXEMPT PROPOSED PROJECT PER SECTION 139 (c) (3) (A) (i)
 - LESS THAN 45 FT. IN HEIGHT
 - LESS THAN 50% GLAZING PER WALL

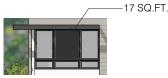


LARGEST UNBROKEN GLAZED SEGMENT IS LESS THAN 24 SQ.FT., SEE FEATURE RELATED STANDARDS, SECTION 139 (c) (2).

<50% OF WALL TO BE DOOR / WINDOW OPENINGS (EX. FRONT ELEVATION):

WALL AREA: 4092 SQ. FT. DOOR / WINDOW AREA: 1,256 SQ.FT.

31% OF WALL AREA IS DOOR / WINDOW DOOR / WINDOW %:

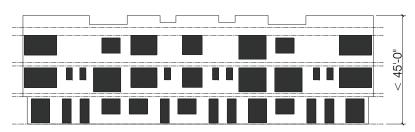

SIDE ELEVATION

W/ UTILITY CLOSETS



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BIRD SAFETY

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JUNE 25, 2020

RESUBMITTAL DATE:

SCALE: 1/8"=1'-0" DATE: 06.25.2020 PROJECT: 348001



PART III LANDSCAPE









Concept Sketch Jamestown Avenue West End

The proposed landscape design celebrates the distant landscape views to the Bay, the local native plants and biodiversity on the adjacent hillside at Bayview Park, and its local neighborhood context. Compliance with San Francisco's Green Landscaping Ordinance and Tier 2 of the San Francisco Water Efficient Landscape Ordinance has been integrated into a holistic planting design for the site.

The Jamestown sidewalk is an important part of a public trail to the park system adjacent to the Bay. Amenities including seating, bike repair, and shaded areas are provided to augment the rich planting along the walk.



Concept Sketch Jamestown Avenue East End

JAMESTOWN CANDLESTICK POINT SAN FRANCISCO, CA

EINWILLERKUEHL LANDSCAPE ARCHITECTURE



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Landscape Site Plan

L1.0

Project Application DATE: 06.05.2020 PROJECT: 348001







Overlook Open Space Detail Plan

Park Open Space Detail Plan

Typical Alley and Paseo Detail Plan



JAMESTOWN
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EINWILLERMUEHL iandscapearchitecture



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Landscape Detailed Site Plans L2.0

LZ.0

Project Application
DATE: 06.05.2020
PROJECT: 348001



Planting Strategy: The proposed landscape planting strategy will be developed from the local context and geology. The adjacent hillside's serpentine soils will define a plant palette of native and serpentine tolerant plants. Planting within the developed areas of the project will be in harmony with this baseline condition--utilizing some of the plants seen on the hillside, but adapting the layout and composition of material to suit a variety of recreational and people driven programming.

Program Strategy: The proposed landscape program will include classic, practical elements that encourage a connected resilient community. Opportunities for passive and active as well as large groups and small groups are provided at a variety of places within the project. Along Jamestown Avenue a series of different gestures composed of planting, furniture, and site organization that addresses the public way and provides interest and opportunities for small park and plaza moments.







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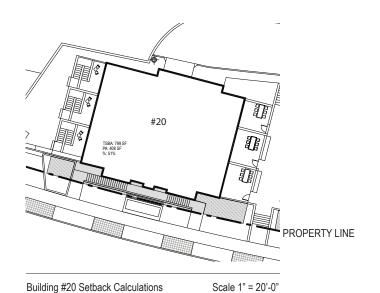
Landscape Precedent Photos


L3.0


Project Application
DATE: 06.05.2020
PROJECT: 348001

OHUNT HALE JONES ARCHITECTS

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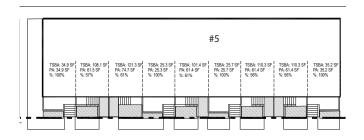
#17

| 150A 467 55 | PA 47 55 55 | N. 54% |

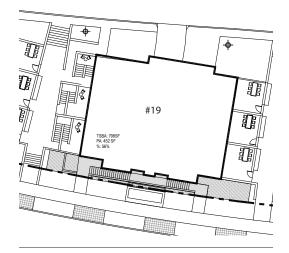
Building #19 Setback Calculations

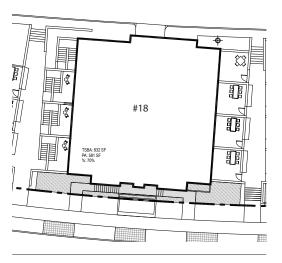Building #18 Setback Calculations


Building #17 Setback Calculations




Building #5 Setback Calculations

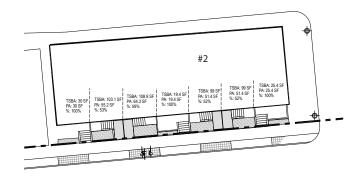


Building #2 Setback Calculations

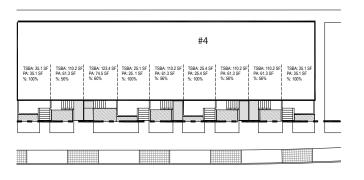


Building #4 Setback Calculations

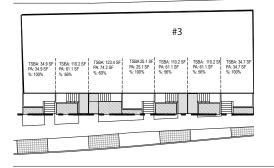

Building #3 Setback Calculations

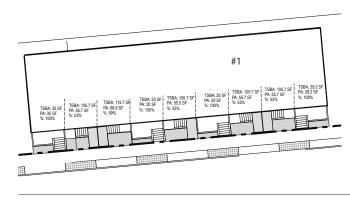

Building #1 Setback Calculations

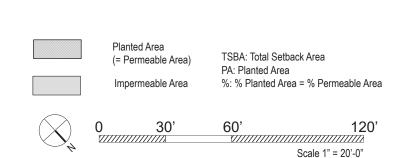

In compliance with the setback requirements from Planning Code Section 132 in Guide to San Francisco Green Landscapeing Ordinance.



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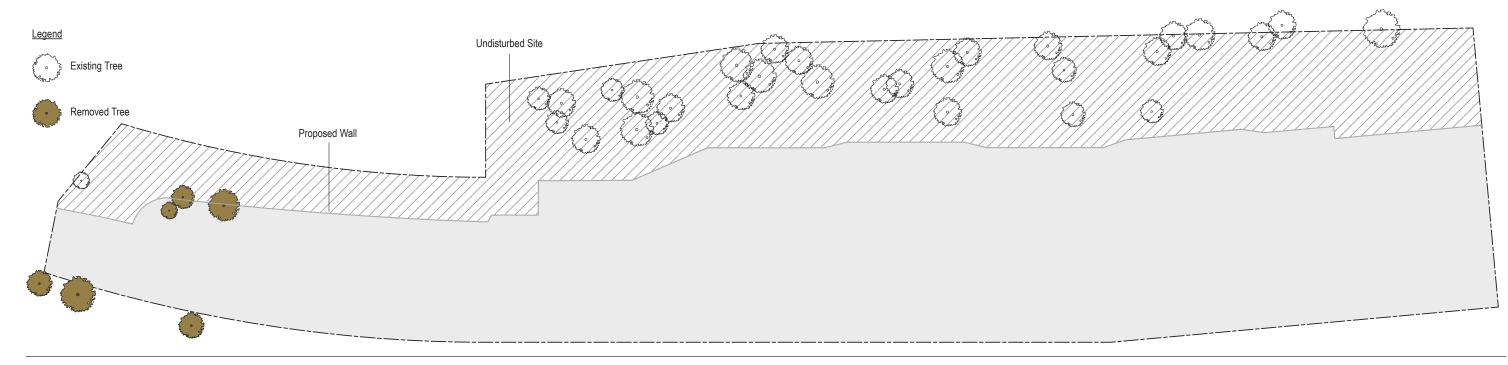
444 Spear Street, Suite 105 San Francisco, CA 94105 www.hunthalejones.com


> t. 415-512-1300 f. 415-288-0288


Compliance with Green Landscape Ordinance

L4.0

Project Application
DATE: 06.26.2020
PROJECT: 348001



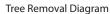

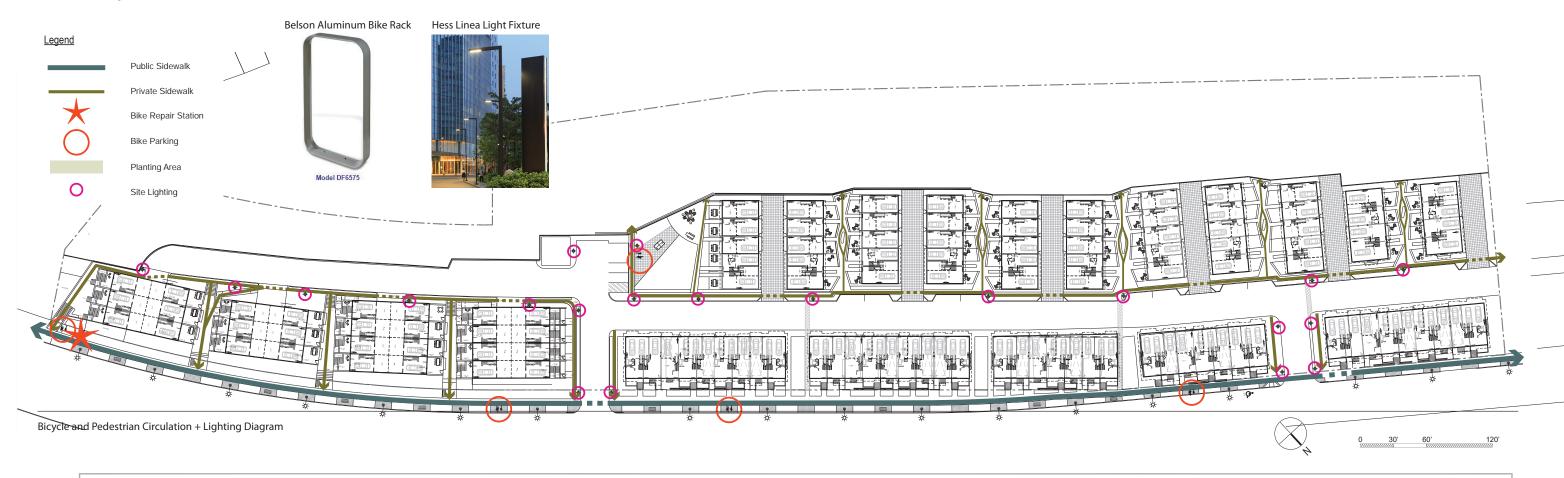



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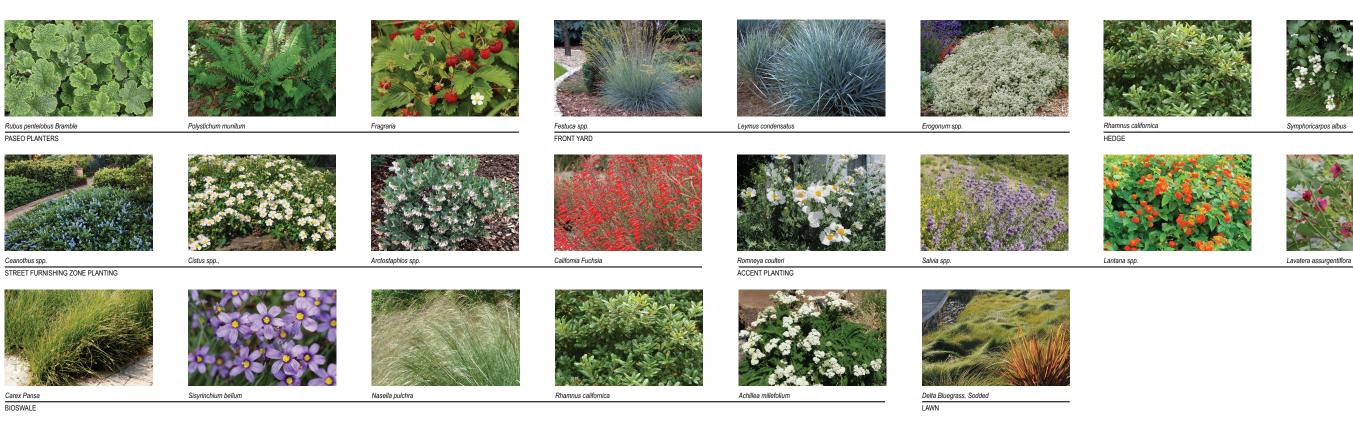
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Project Diagrams L5.0

Project Application
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PROJECT: 348001





BIOSWALE TREE



PASEO TREE



PASEO TREE



SPECIMEN OAK



FRONTAGE 1 TREE



FRONTAGE 2 TREE



COURT TREE



STREET TREE

PLANTING CONCEPT STATEMENT

Located adjacent to the bayview hill park, the planting design will showcase local native plants that extend and connect to the existing native plants that extend and connect to the successful in the bayview in san francisco. The planting design of the public open space melds with the streetscape and provides variety throughout the site. Microclimates inform the planting design is created from durable native plants that extend and connect to the existing native plants that have been proven to be successful in the bayview in san francisco. The planting design of the public open space melds with the streetscape and provides variety throughout the site. Microclimates inform the planting design is created from durable native plants that extend and connect to the existing native plants that extend and connect to the existing native plants that extend and connect to the existing native plants that extend and connect to the existing native plants that extend and connect to the planting design of the public open space melds with the streetscape and provides variety throughout the site. Microclimates inform the planting design of the public open space melds with the streetscape and provides variety throughout the site. Microclimates inform the planting design of the public open space melds with the streetscape and provides variety throughout the site. Microclimates inform the planting design of the public open space melds with the streetscape and provides variety throughout the site. Microclimates inform the planting design of the public open space melds with the streetscape and provides variety throughout the site. Microclimates inform the planting design of the public open space melds with the streetscape and provides variety throughout the site. Microclimates inform the planting design of the variety of sun exposures or the site of the variety of sun exposures or the site of the variety of sun exposures or the site of the variety of sun exposures or the site of the variety of sun exposures or the site of the variety

IRRIGATION CONCEPT STATEMENT

The irrigation design for the site shall comply with the state of california model water efficient landscape ordinance (title 23 - division 2-chapter 2.7) and the city of san francisco water efficient landscape standards. The irrigation systems will be automatically controlled by an et irrigation systems will be automatically controller capable of multiple programming and independent timing of individual irrigation systems. The controller will have a 24-hour clock to allow multiple start times and repeat cycles to adjust for soil percolation rates. The irrigation systems will consist primarily of low volume, low flow bubblers for trees, point source drip irrigation for shrubs and groundcovers, and low flow irrigation phydrozone. The irrigation systems will be grouped onto separate valves according to sun exposure and water use to allow for irrigation application by hydrozone. The irrigation systems will be grouped onto separate valves according to sun exposure and water use to allow for irrigation phydrozone. The irrigation systems will be grouped onto separate valves according to sun exposure and water use to allow for irrigation phydrozone. The irrigation systems will be grouped onto separate valves according to sun exposure and water use to allow for irrigation phydrozone. The irrigation systems will be grouped onto separate valves according to sun exposure and water use to allow for irrigation systems will be grouped onto separate valves. designed to run during nighttime hours when irrigation is most efficient.



JAMESTOWN CANDLESTICK POINT SAN FRANCISCO, CA






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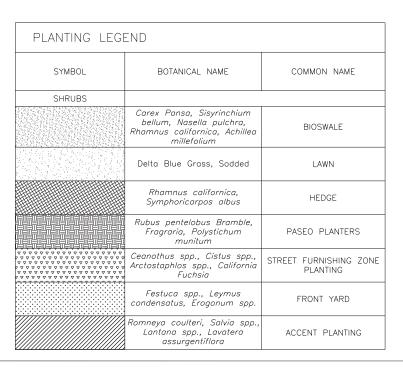
t. 415-512-1300 f. 415-288-0288


Planting Palette L6.0

Project Application DATE: 06.05.2020 PROJECT: 348001



PLANTING LEGEND				
SYMBOL	BOTANICAL NAME COMMON NAME			
TREES				
	Platanus racemosa "Roberts" BIOSWALE TREE			
	Pinus radiata, Cupressus macrocarpa	PASEO TREE		
	Quercus suber	SPECIMEN OAK		
	Cercis occidentalis FRONTAGE 1 TR			
The state of the s	Lyonothamnus floribundus	FRONTAGE 2 TREE		
of the second	Lophostemon Confertus	CORT TREE		
Δ	Quercus agrifolia STREET TREE			

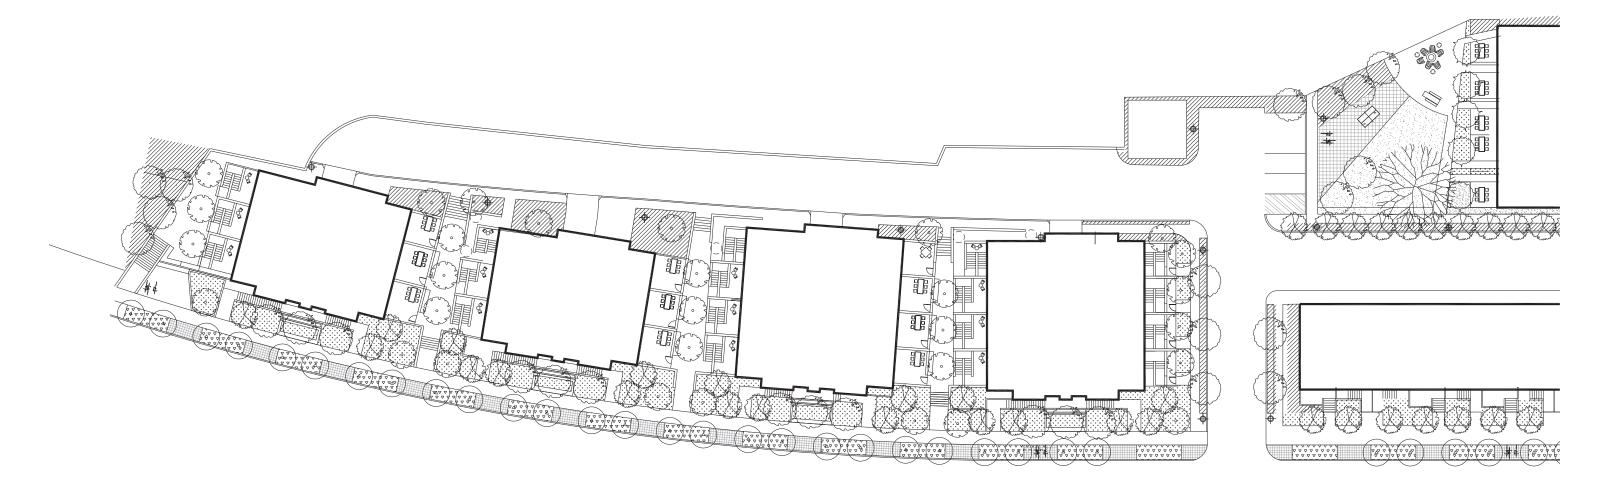

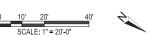








Architecture Planning Interiors


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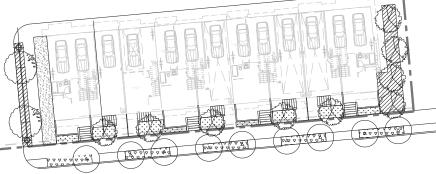
> t. 415-512-1300 f. 415-288-0288

Planting Plan L7.0

Project Application
DATE: 06.26.2020
PROJECT: 348001



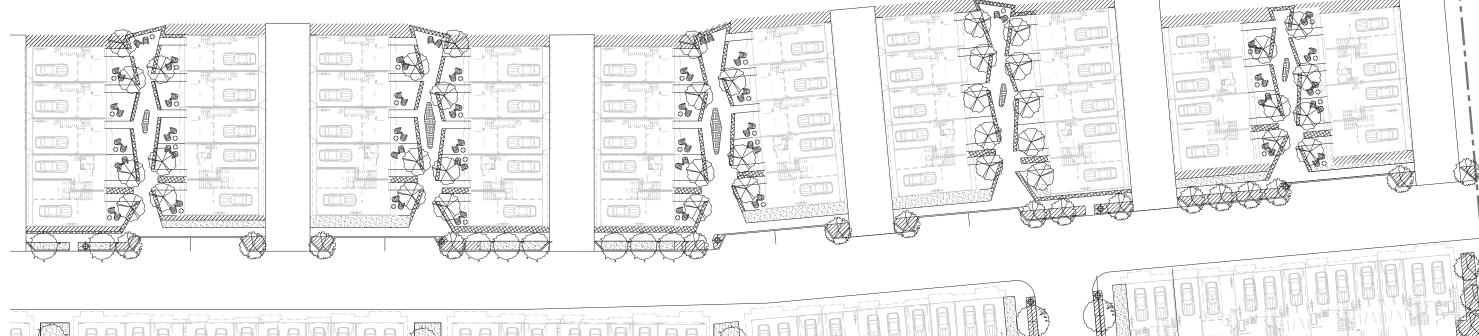

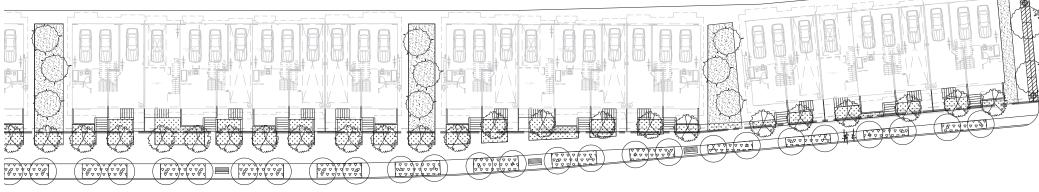

PLANTING LEGEND				
SYMBOL	BOTANICAL NAME COMMON NAME			
TREES				
	Platanus racemosa "Roberts" BIOSWALE TREE			
	Pinus radiata, Cupressus macrocarpa	PASEO TREE		
	Quercus suber	SPECIMEN OAK		
	Quercus Iobata FRONTAGE 1 Tf			
The state of the s	Cercis occidentalis	FRONTAGE 2 TREE		
Read States	Lyonothamnus floribundus	CORT TREE		
Δ	Quercus agrifolia	STREET TREE		

PLANTING LEGEND				
SYMBOL	BOTANICAL NAME	COMMON NAME		
SHRUBS				
	Carex Pansa, Sisyrinchium bellum, Nasella pulchra, Rhamnus californica, Achillea millefolium	BIOSWALE		
	Delta Blue Grass, Sodded	LAWN		
	Rhamnus californica, Symphoricarpos albus	HEDGE		
	Rubus pentelobus Bramble, Fragraria, Polystichum munitum	PASEO PLANTERS		
	Ceanothus spp., Cistus spp., Arctostaphlos spp., California Fuchsia	STREET FURNISHING ZONE PLANTING		
	Festuca spp., Leymus condensatus, Erogonum spp.	FRONT YARD		
	Romneya coulteri, Salvia spp., Lantana spp., Lavatera assurgentiflora	ACCENT PLANTING		









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Planting Plan L8.0

Project Application
DATE: 06.05.2020
PROJECT: 348001



GARDEN PASEO



VIEW FROM JAMESTOWN



DOWNHILL VIEW



COMMUNITY PARK & CENTRAL DRIVE AISLE

PART IV BUILDING TYPES

BUILDING TYPE A (9 PLEX)

EXAMPLE FOR BUILDINGS 1, 4 & 5



RENDERING



BUILDING TYPE A (9 PLEX) - FRONT ELEVATION



LEFT ELEVATION



RIGHT ELEVATION



ROOF PLAN

UPPER FLOOR PLAN

MAIN FLOOR PLAN

GROUND FLOOR PLAN

BUILDING 1

BUILDING 1

JAMESTOWN CANDLESTICK POINT SAN FRANCISCO, CA

149'-4"



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BLDG TYPE A (9 PLEX) - BLDG 1 (BLDGS. 4,5 SIM)

JUNE 25, 2020

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A4.0

BUILDING TYPE A (7 PLEX)

EXAMPLE FOR BUILDINGS 2 & 3



RENDERING



BUILDING TYPE A (7 PLEX) - FRONT ELEVATION



REAR ELEVATION



LEFT ELEVATION



RIGHT ELEVATION



JAMESTOWN
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ROOF PLAN
BUILDING 2

UPPER FLOOR PLAN

MAIN FLOOR PLAN

GROUND FLOOR PLAN

BUILDING 2



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BLDG TYPE A (7 PLEX) - BLDG 2 (BLDG 3 SIM)

JUNE 25, 2020

PRELIMINARY PROJECT ASSESSMENT APPLICATION
ORIGINAL SUBMITTAL DATE: MARCH 05, 2019
RESUBMITTAL DATE: MARCH 09, 2020
RESUBMITTAL DATE: JUNE 05, 2020

RESUBMITTAL DATE:

A4.1


BUILDING TYPE B (4 PLEX)

EXAMPLE FOR BUILDINGS 6 & 7




ROOF PLAN

BUILDING 6

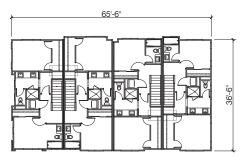


UPPER FLOOR PLAN

BUILDING 6

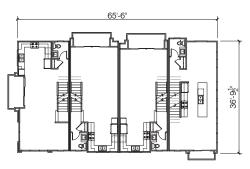

MAIN FLOOR PLAN

BUILDING 6

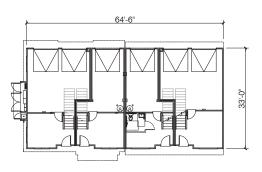

GROUND FLOOR PLAN

UILDING 6

RENDERING



BUILDING TYPE B (4 PLEX) - FRONT ELEVATION



REAR ELEVATION



LEFT ELEVATION



RIGHT ELEVATION

RESUBMITTAL DATE:



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BLDG TYPE B (4 PLEX) - BLDG 6 (BLDGS. 7-16 SIM.)

JUNE 25, 2020


PRELIMINARY PROJECT ASSESSMENT APPLICATION
ORIGINAL SUBMITTAL DATE: MARCH 05, 2019
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RESUBMITTAL DATE: JUNE 05, 2020

SCALE: 1/4"=1'-0"

DATE: 06.25.2020 PROJECT: 348001


BUILDING TYPE C (8 PLEX)

EXAMPLE FOR BUILDINGS 17 & 18 (19 & 20 SIM.)

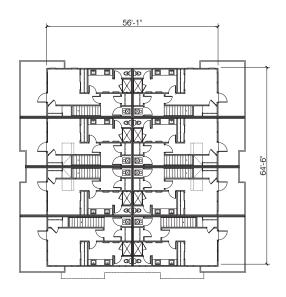


UPPER FLOOR PLAN

BUILDING 1

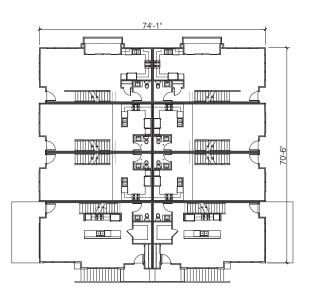


MAIN FLOOR PLAN

BUILDING 17

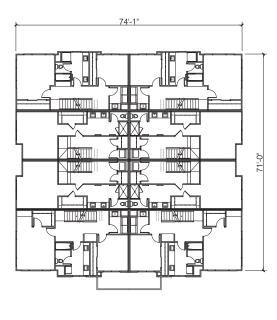

TOP FLOOR PLAN

BLIII DING 1

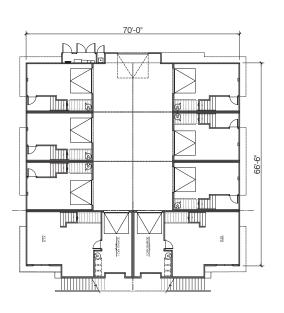

GROUND FLOOR PLAN

BUILDING 17







BUILDING TYPE C (8 PLEX) - FRONT ELEVATION



REAR ELEVATION



LEFT ELEVATION



RIGHT ELEVATION

RESUBMITTAL DATE:



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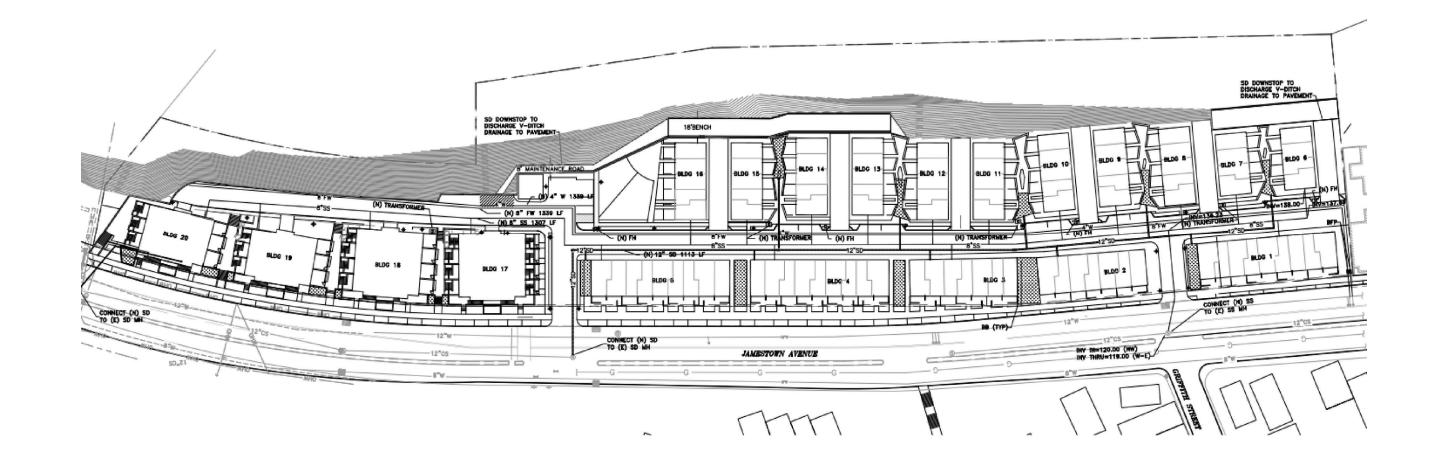
> t. 415-512-1300 f. 415-288-0288

BLDG TYPE C (8 PLEX) - BLDG 17 (18-20 SIM.)

JUNE 25, 2020

PRELIMINARY PROJECT ASSESSMENT APPLICATION
ORIGINAL SUBMITTAL DATE: MARCH 05, 2019
RESUBMITTAL DATE: MARCH 09, 2020
RESUBMITTAL DATE: JUNE 05, 2020

A4.3



PART V CIVIL ENGINEERING

VESTING TENTATIVE PARCEL MAP JAMESTOWN AVENUE (NO ADDRESS; BLOCK 4991; LOT 276) CITY AND COUNTY OF SAN FRANCISCO, CALIFORNIA

GENERAL NOTES

OWNER:

DIMENSIONS:

STRADA JAMESTOWN VENTURE LLC C/O STRADA INVESTMENT GROUP 101 MISSION STREET, SUITE 420 SAN FRANCISCO, CA 94105

(415) 263-9151 JESSE BLOUT, AUTHORIZED AGENT

FREYER & LAURETA, INC. 150 EXECUTIVE PARK BLVD, SUITE 4200 SAN FRANCISCO, CA 94134 2. CIVIL ENGINEER:

(415) 534-7070 RICHARD LAURETA, RCE 055783

GEOTECHNICAL ENGINEER:

101 CALIFORNIA STREET, SUITE 875 SAN FRANCISCO, CA 94111 (510) 717-7100

4. ZONING CONFORMANCE: THE PLAN CONFORMS TO THE EXISTING RH-2 ZONING AND CALLS AN ADDENDUM TO THE PREVIOUSLY APPROVED 2010 CANDLESTICK POINT-HUNTERS POINT SHIPYARD PHASE II DEVELOPMENT PLAN PROJECT EIR (THE "CANDLESTICK EIR"). AMONG OTHER APPROVALS.

5. PROPOSED LAND USE: THE PROPOSED REDEVELOPMENT ENVISIONS THE CONSTRUCTION OF 122, 3-STORY ATTACHED TOWNHOME STYLE RESIDENCES TOTALING 160 434 SQ. THE COMMUNITY OF 20 NEW BUILDINGS WOULD BE INTERSPERSED WITH OPEN SPACE, INCLUDING A NEW CENTRAL COMMUNITY PARK AND PLAY AREA, AND SEVERAL GARDEN PASEOS THAT WOULD CONTRIBUTE TO AND ENHANCE THE EXISTING RESIDENTIAL COMMUNITY THAT SURROUNDS THE PROPERTY TODAY.

THE PROPOSED TOWNHOME—STYLE CONDOMINIUMS ARE SIMILAR IN STYLE, SIZE, AND DENSITY TO THE EXISTING TOWNHOME COMMUNITIES THAT IMMEDIATELY NEIGHBOR THE SITE AS WELL AS THOSE AT THE NEARBY SHIPYARDS DEVELOPMENT. THE TOWNHOMES WOULD RANGE FROM APPROXIMATELY 1,100 TO 1,550 SQUARE FEET WITH 67% OF HOMES WITH TWO BEDROOMS, TWO—AND—A—HALF BATHS AND WOULD PROVIDE A RARE OWNERSHIP OPPORTUNITY SUITABLE TO FIRST—TIME SAN FRANCISCO HOME BUYERS. ADDITIONALLY, APPROXIMATELY

TWO-THIRDS OF THE HOMES WOULD INCLUDE PRIVATE ROOF DECKS AND/OR BALCONIES. ALL DIMENSIONS SHOWN ARE PRELIMINARY AND SUBJECT TO FINAL DESIGN AND MAPPING.

SURVEYOR'S STAMP

[FOR EXAMINATION ONLY] CURT CHAPPELL, PLS SURVEYOR FREYER & LAURETA, INC.

ENGINEER'S STATEMENT

THIS VESTING TENTATIVE PARCEL MAP HAS BEEN PREPARED BY ME OR UNDER MY DIRECTION IN ACCORDANCE WITH STANDARD ENGINEERING PRACTICE.


[FOR EXAMINATION ONLY]

JEFFREY J. TARANTINO, P.E. VICE PRESIDENT FREYER & LAURETA, INC.



SHEET INDEX

COVER SHEET
EXISTING SITE CONDITIONS
PROPOSED PARCELIZATION
STREET IMPROVEMENTS
STREET CROSS SECTIONS
UNDERGROUND UTILITY PLAN
(PANING PLAN STORM WATER MANAGEMENT PLAN EROSION CONTROL PLAN SFFD FIRE TRUCK ACCESS PARKING AND STRIPING PLAN

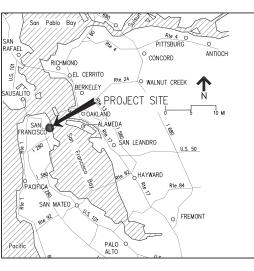

VICINITY MAP

NO SCALE



SITE PLAN



JAMESTOWN CANDLESTICK POINT SAN FRANCISCO, CA



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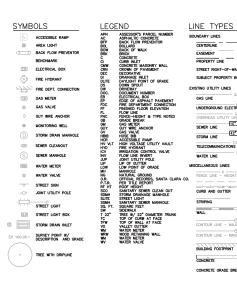


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DRAWN: JKL CHECKED: JJT

COVER SHEET SHEET 1 OF 14

SCALE: NTS DATE: 06.05.2020 PROJECT: 275002 SITE PERMIT APPLICATION



PROPERTY LINE


SEWER LINE STORM LINE 42" RCP

CONCRETE CONCRETE GRADE BREAK

10" VCP>

UTILITY NOTE 1. ALL DISTANCES SHOWN HEREON ARE IN FEET AND DECIMALS THEREOF. PHYSICAL ITEMS SHOWN ON THIS SUPEY RIFE LIMITED TO HOSE SUPERIFICATE OF THE PROPERTY OF THE PROPERTY OF THE SUPERIFICATION OF THE S PROJECT BENCHMARK ELEVATION: 16.188 FEET DATUM: CCSF-VD13 POINT I.D.: BM 10514 DESCRIPTION: 1/2" DOMED STEEL ANCHOR PIN NORTHEAST CORNER OF HARNEY WAY @ EXECUTIVE PARK. IN CONCRETE CURB. 1' EASTERLY OF BEGINNING OF CURB RETURN. 0.3' RADIAL FROM FACE OF CURB. BASIS OF BEARINGS

EXISTING SITE SLOPE THE AVERAGE EXISTING ELEVATION OF THE SITE IS ELEVATION 149. THE AVERAGE SLOPE OF EXISTING SITE IS 25% WITH 57% OF THE SITE HAVING AN EXISTING SLOPE LESS THAN 10%.

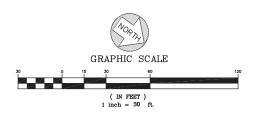





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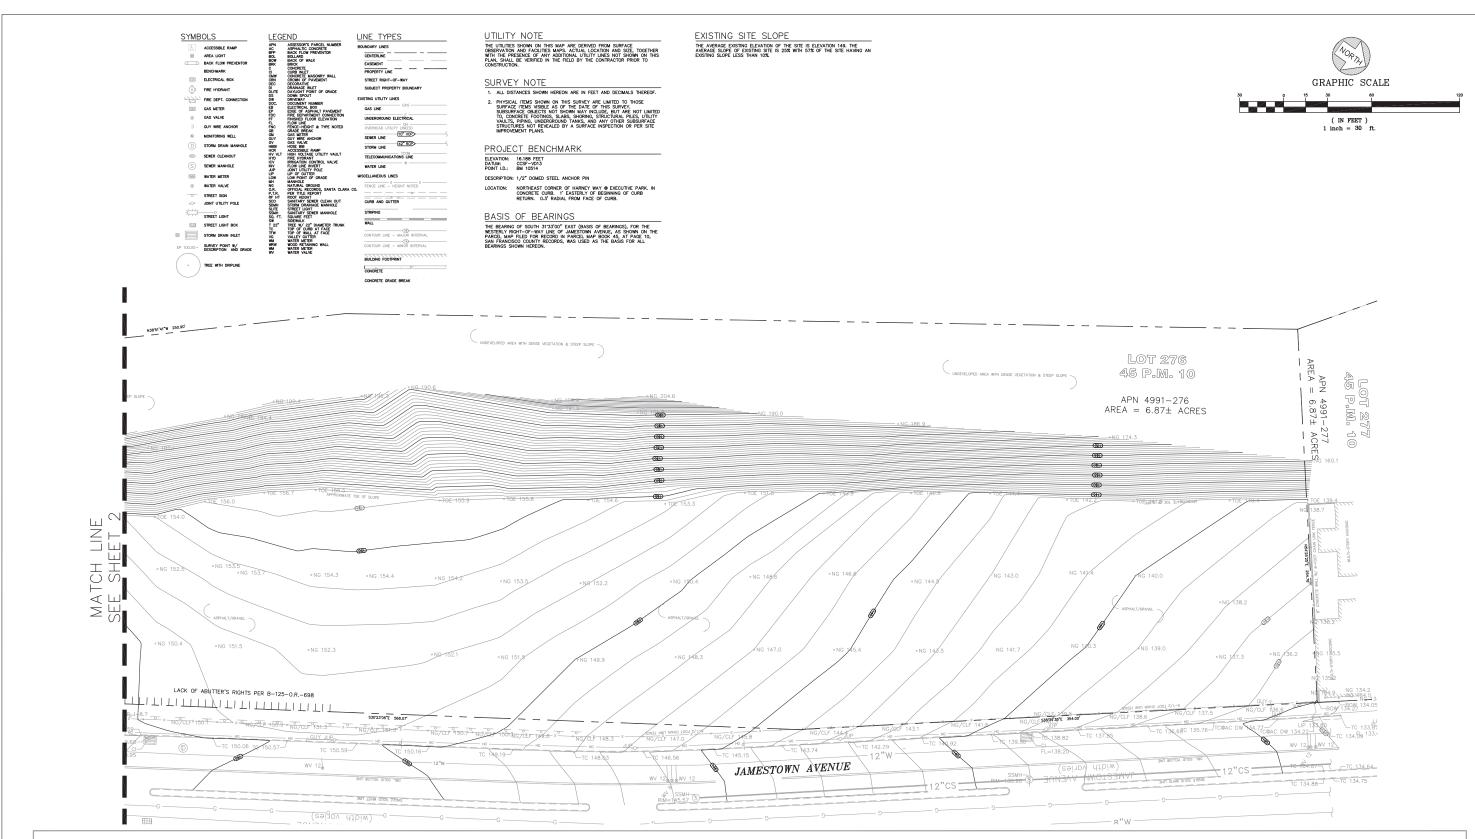


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DESIGNED: LEK DRAWN: JKL CHECKED: JJT

EXISTING SITE CONDITIONS SHEET 2 OF 14

SCALE: 1" = 30' DATE: 06.05.2020 PROJECT: 275002 SITE PERMIT APPLICATION







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DESIGNED: LEK DRAWN: JKL CHECKED: JJT

EXISTING SITE CONDITIONS SHEET 3 OF 14

SCALE: 1" = 30'
DATE: 06.05.2020
PROJECT: 275002
SITE PERMIT APPLICATION

LEGEND

---- PROPOSED LOT BOUNDARY

PROPOSED IMPROVEMENTS


C# CURVE NUMBER

L## LINE NUMBER

.DG # BUILDING NUMBER

LINE TABLE			
LINE NO.	LENGTH	DIRECTION	
L1	250.90	N38*51'41"\	
L2	649.56	N31*37'46"\	
L3	254.76	N54*25'25"	
L4	354.00	S35°34'35"I	
L5	568.07	S30°23'05"I	
L6	65.81	S70*50'10"\	
L7	91.13	N81*07'30"\	
L8	84.66	S59°36'55"\	

CURVE TABLE				
CURVE NO. LENGTH RADIUS DEL				
C1	408.16	1300.00	17°59'21"	
C2	335.76	1150.00	16°43'42"	

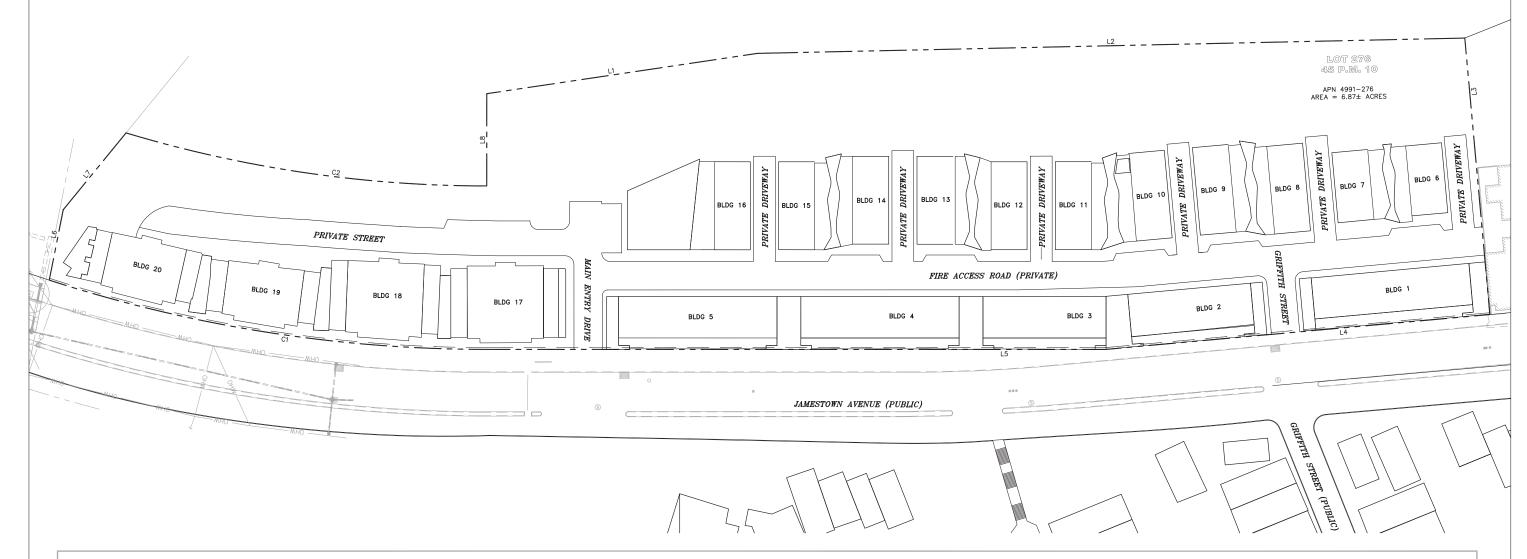



JAMESTOWN
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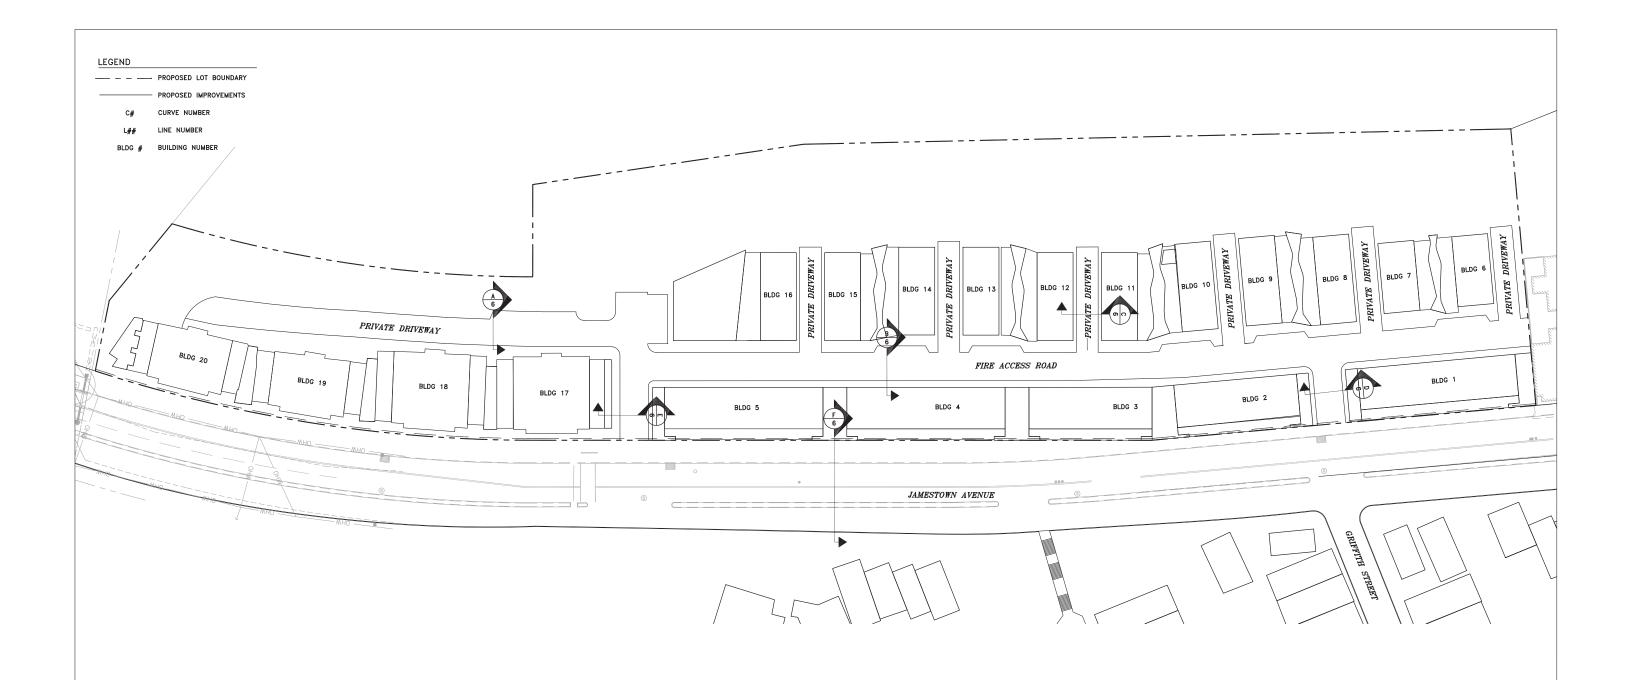
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DESIGNED: LEK DRAWN: JKL CHECKED: JJT

PROPOSED PARCELIZATION

SHEET 4 OF 14

SCALE: 1" = 40'
DATE: 06.05.2020
PROJECT: 275002
SITE PERMIT APPLICATION







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DESIGNED: LEK DRAWN: JKL CHECKED: JJT

STREET IMPROVEMENTS


SHEET 5 OF 14


SCALE: 1" = 40'


DATE: 06.05.2020

PROJECT: 275002

SITE PERMIT APPLICATION

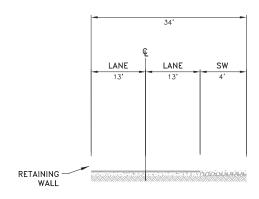

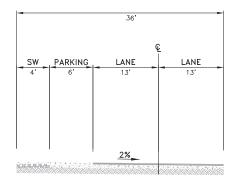


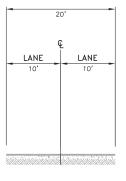





B FIRE ACCESS ROAD

C PRIVATE DRIVEWAY

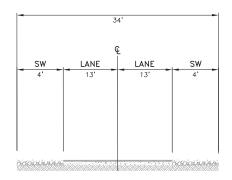

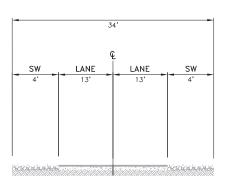

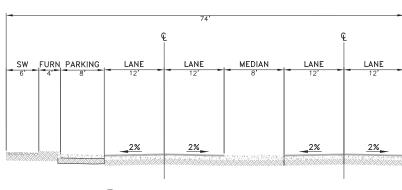

D NORTH ENTRY











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DESIGNED: LEK DRAWN: JKL CHECKED: JJT

STREET CROSS SECTIONS SHEET 6 OF 14

SCALE: NTS
DATE: 06.05.2020
PROJECT: 275002
SITE PERMIT APPLICATION

LEGEND --- PROPERTY LINE CENTER LINE SANITARY SEWER FIRE WATER WATER

BUILDING PAD ELEVATION PROPOSED BIORETENTION

TRANSFORMER

BACKFLOW PREVENTER STORM DRAIN MANHOLE

WATER METER WATER VALVE **ABBREVIATIONS**

FINISHED FLOOR ELEVATION

FIRE WATER

INVERT

NEW

MANHOLE

TYPICAL

WATER

SANITARY SEWER

BMP

(E)

FFE

INV

мн

(N)

(TYP)

SS

BB BIORETENTION BASIN EXISTING SURFACE FEATURES WERE OBTAIN FROM TOPOGRAPHIC SURVEY DATED SEPTEMBER 7, 2018. BACK FLOW PREVENTER

 INVERT ELEVATIONS REFLECT AS-BUILT RECEIVED BY SAN FRANCISCO PUBLIC UTILITIES COMMISSION, EXTENSION OF JAMESTOWN AVENUE GILROY ST. TO HUNTERS PT. SERV. ROAD, DATED JUNE 24, 1958. BEST MANAGEMENT PRACTICES BLDG BUILDING EXISTING

NOTES

3. 8" AND 12" POTABLE WATER LINE REFLECT AS-BUILTS
RECEIVED BY SAN FRANCISCO WATER DEPARTMENT DATED JUNE
11, 2018


4. GAS LINE REFLECT AS-BUILTS RECEIVED BY PG&E DATED JUNE 15, 2018

TELECOMMUNICATION LINE REFLECT AS-BUILTS SHEET 153-154 RECEIVED BY AT&T DATED, NOVEMBER 8. 2000.

6. ELECTRIC TRANSFORMERS ARE ABOVE GRADE.

PER FIELD FLOW TEST PERFORMED BY SFPUC, THE AVAILABLE STATIC PRESSURE IS 39 PSI, THE AVAILABLE RESIDUAL PRESSURE IS 30 PSI, AND THE FLOW IS 200 GPM FROM THE EXISTING 8-INCH MAIN ON JAMESTOWN.



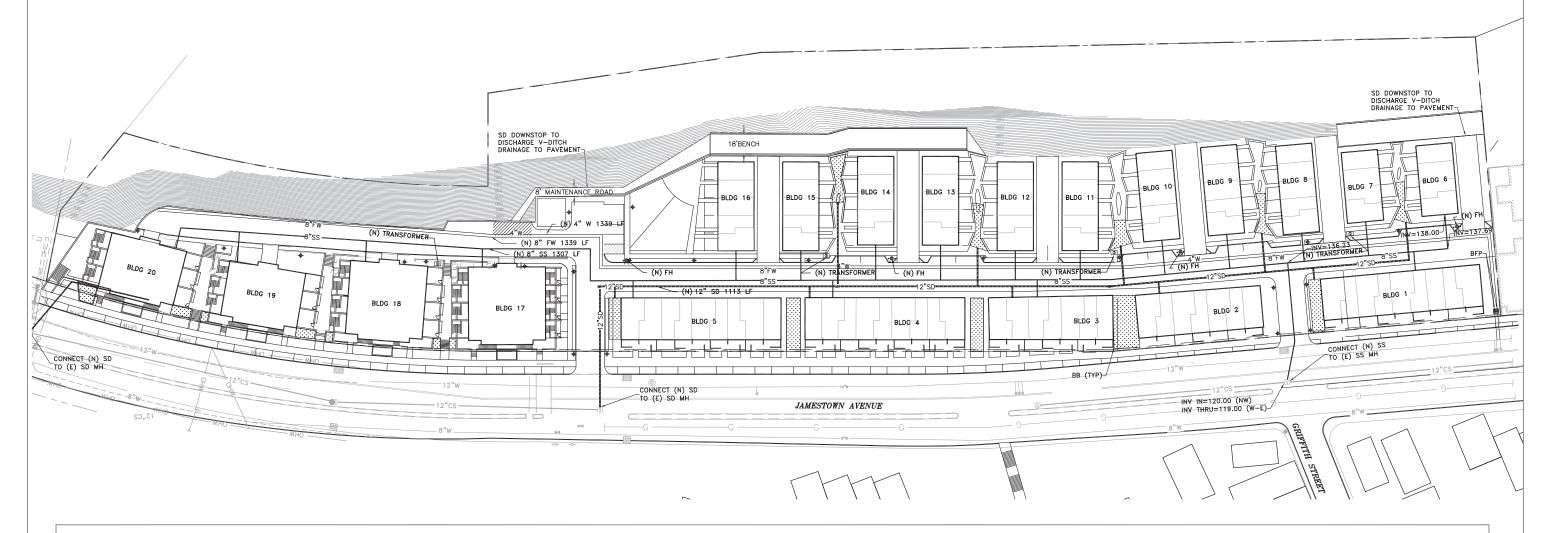



JAMESTOWN CANDLESTICK POINT SAN FRANCISCO, CA



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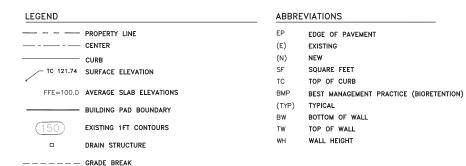


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DESIGNED: LEK DRAWN: JKL CHECKED: JJT

UTILITY PLAN SHEET 7 OF 14

SCALE: 1" = 40' DATE: 06.05.2020 PROJECT: 275002 SITE PERMIT APPLICATION




CUT AND FILL CALCULATIONS

PROPOSED TOTAL CUT = 7,451 CUBIC YARDS
PROPOSED TOTAL FILL = 3,417 CUBIC YARDS

NET TOTAL CUT = 4,034 CUBIC YARDS

WALL ELEVATION DATA TABLE				
POINT NO.	TW	BW	WH	
P1	131.00	128.00	3.00	
P2	145.00	145.00	0.00	
P3	150.00	147.00	2.00	
P4	149.50	147.00	2.00	
P5	173.50	148.39	25.11	
P6	167.00	148.23	18.77	
P7	162.50	153.64	8.86	
P8	168.50	155.09	13.41	
P9	163.00	154.93	14.39	
P10	P10 191.50		13.60	
P11	P11 177.00		23.50	
P12	178.50	170.90	7.60	
P13	P13 170.00		16.50	
P14	P14 182.50		10.10	
P15	171.50	152.50	19.00	

WAL	L ELEVATION	N DATA TAB	LE
POINT NO.	TW	BW	WH
P16	186.50	173.90	12.60
P17	173.50	152.00	21.50
P18	169.00	149.30	19.60
P19	167.00	148.80	18.20
P20	165.00	148.75	16.25
P21	163.00	148.70	14.30
P22	169.00	146.30	22.70
P23	168.00	146.20	21.80
P24	168.00	146.10	21.90
P25	P25 165.00		21.90
P26	P26 165.50		22.09
P27	173.50	159.90	13.60
P28	159.00	143.60	15.40
P29	174.50	161.90	12.60
P30	161.00	141.50	19.50

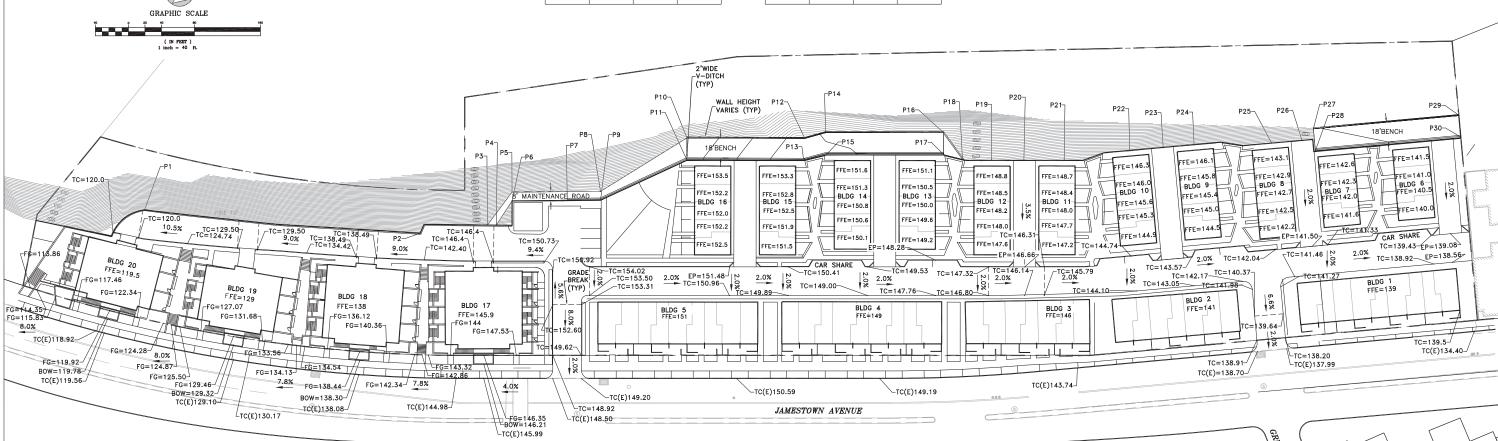



JAMESTOWN
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DESIGNED: LEK DRAWN: JKL CHECKED: JJT GRADING PLAN SHEET 8 OF 14

SCALE: 1" = 40'

DATE: 06.26.2020

PROJECT: 275002

SITE PERMIT APPLICATION

LEGEND

CENTER LINE
BUILDING PAD BOUND

BUILDING PAD BOUNDARY

DRAINAGE MANAGEMENT AREA

SD SCHEMATIC PIPE WITH FLOW DIRECTION

----- ROOF SLOPE BRAKE LINE

PROPOSED BIORETENTION BASIN

SURFACE FLOW

150 ROOF DISCHARGE TO BIORETENTION BASIN

ABBREVIATIONS

BIORETENTION BASIN

BMP BEST MANAGEMENT PRACTICE (BIORETENTION)
DMA DRAINAGE MANAGEMENT AREA

(SF) SQUARE FEET


(TYP) TYPICAL


NOTES

 THIS STORM WATER MANAGEMENT PLAN IS PRELIMINARY AND IS SUBJECT TO CHANGE.

2. TABLE IS NOT UPDATED TO CURRENT PLAN SHOWN.

STORMWATER CALCULATIONS				
DMA BOUNDARY	AREA (SF)	IMPERVIOUS AREA (SF)	PERVIOUS AREA (SF)	BMP REQUIRED (SF)
AREA 1	41,057	39,358	1,699	1,200
AREA 2	41,169	39,803	1,366	1,235
AREA 3	10,982	10,594	388	329
AREA 4	9,422	9,111	311	283
AREA 5	7,592	6,678	914	227
AREA 6	9,767	9,458	309	293
AREA 7	29,600	28,608	992	888
AREA 8	9,383	9,099	284	281
AREA 9	7,864	7,616	248	236
AREA 10	9,520	8,994	526	286

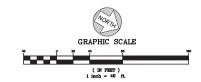

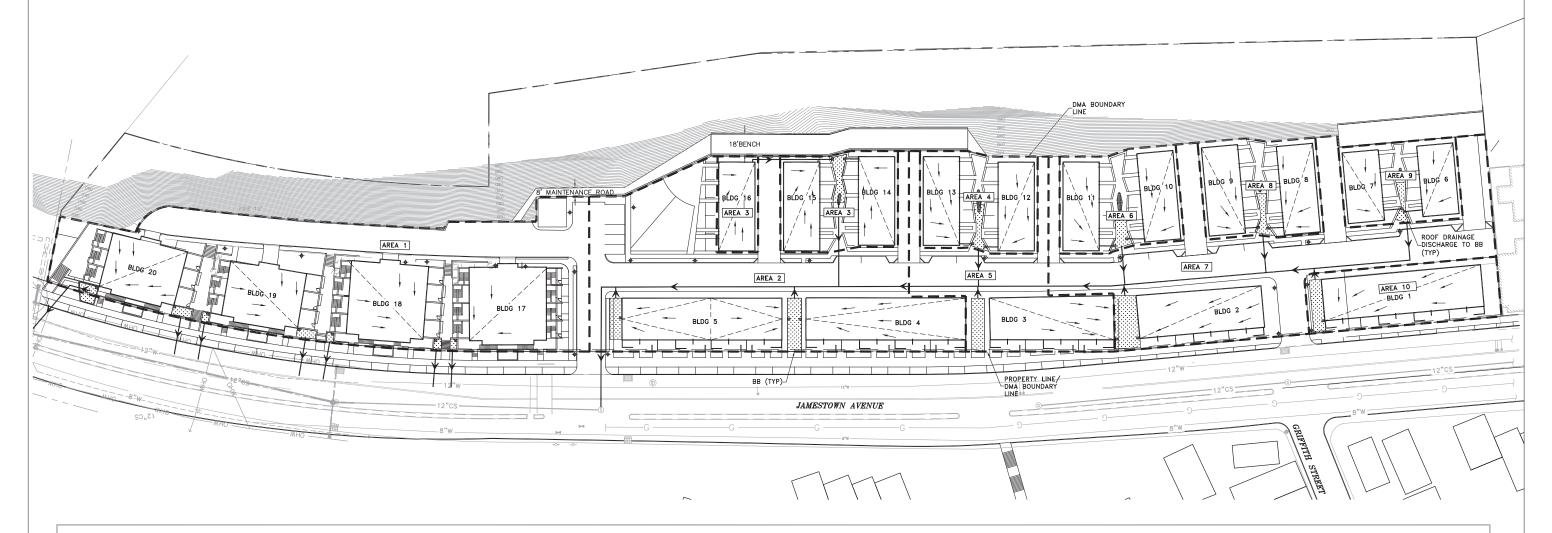



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DESIGNED: LEK DRAWN: JKL CHECKED: JJT


STORM WATER MANAGEMENT PLAN SHEET 9 OF 14

SCALE: 1" = 40'

DATE: 06.05.2020

PROJECT: 275002

SITE PERMIT APPLICATION

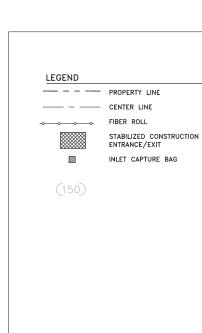

ABBREVIATIONS

BUILDING

EXISTING

INVERT

TYPICAL

NEW

BLDG


(N)

(TYP)

BEST MANAGEMENT PRACTICES

BACK FLOW PREVENTER


FINISHED FLOOR ELEVATION

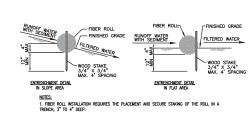

2. Adjacent rolls shall tightly abut and stakes placed at the ends in order to prevent "gaps from opening between the rolls.

4. EXACT LOCATION OF FIBER ROLL INSTALLATION FOR EACH SITE SHALL BE DETERMINED IN THE FIELD BY THE OWNER'S REPRESENTATIVE. 1 FIBER ROLL DETAIL
- SCALE: NO SCALE

3. RUNOFF MUST NOT BE ALLOWED TO RUN UNDER OR AROUND FIBER ROLL.

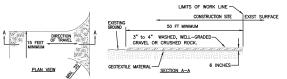



STABILIZED CONSTRUCTION

ENTRANCE DETAIL

SOLIE: NO SOLIE

3 INLET CAPTURE BAG DETAIL
SCALE: NO SCALE

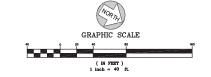

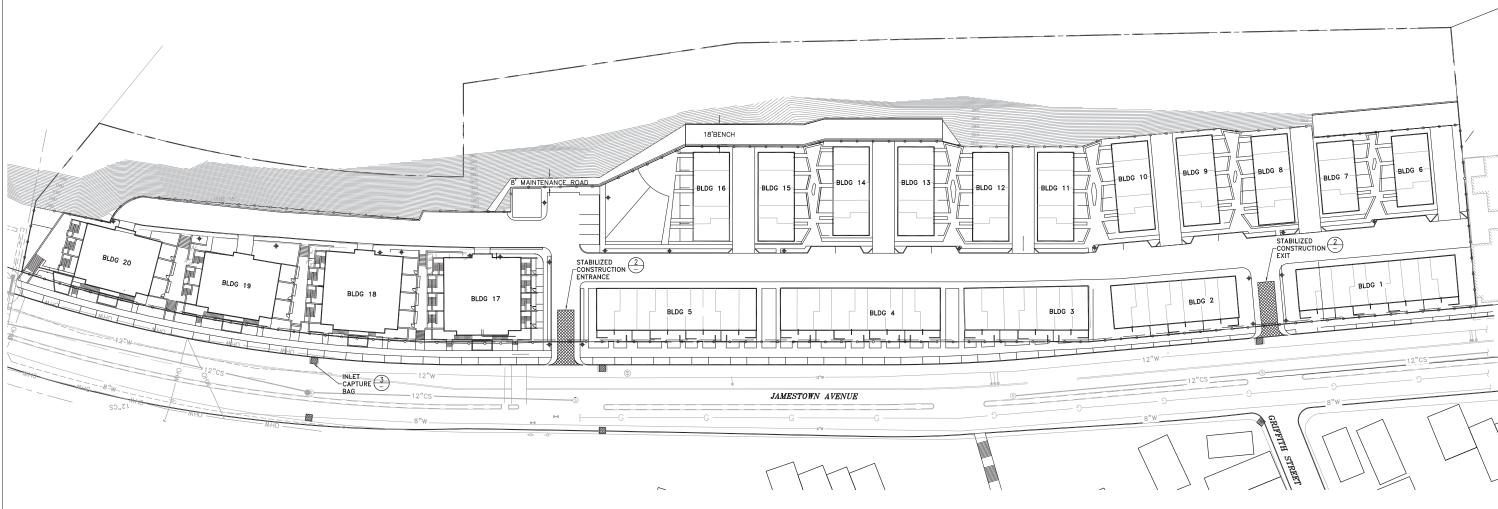



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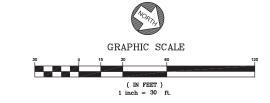
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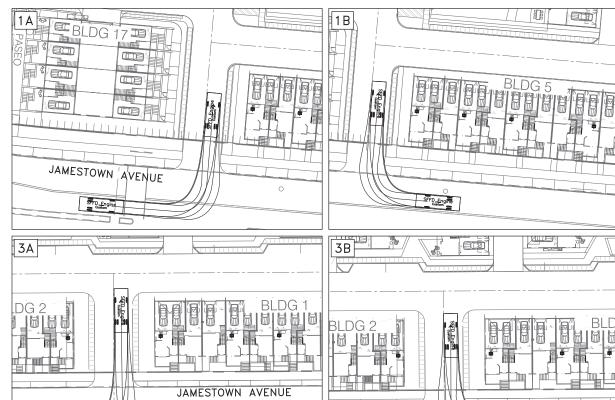



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DESIGNED: LEK DRAWN: JKL CHECKED: JJT **EROSION CONTROL PLAN** SHEET 10 OF 14


> SCALE: 1" = 40' DATE: 06.05.2020 PROJECT: 275002 SITE PERMIT APPLICATION






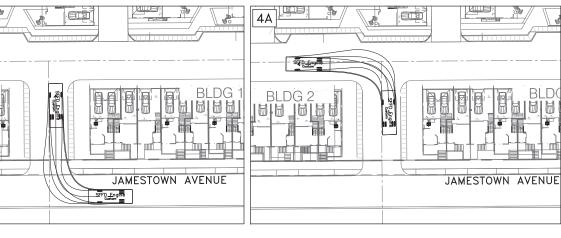

17 3

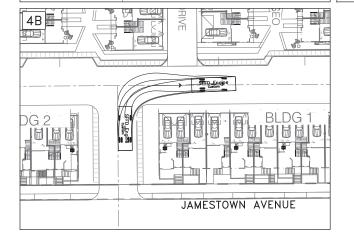


SFFD_Engine Custom

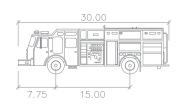

SFFD Engine

Width : 9.50 Track : 8.50 Lock to Lock Time : 6.0 Steering Angle : 36.0 KEY MAP

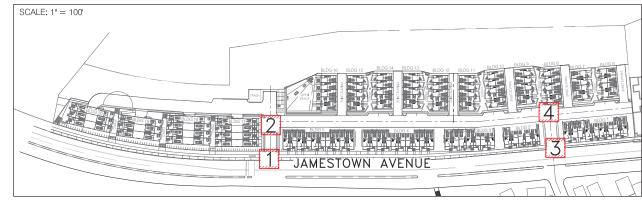



JAMESTOWN
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DESIGNED: LEK DRAWN: JKL CHECKED: JJT


SFFD ENGINE TRUCK ACCESS SHEET 11 OF 14


SCALE: 1" = 30'


DATE: 06.05.2020

PROJECT: 275002

SITE PERMIT APPLICATION

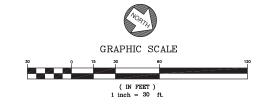

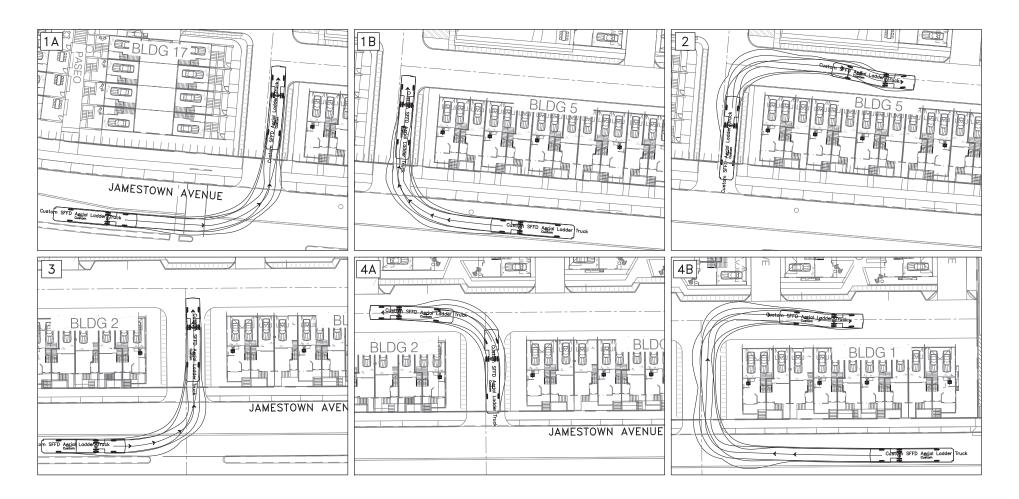

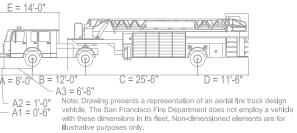

Illustrative purposes only.

Custom 57' SFFD Ladder Truck (DRAFT)


NAME

UNITS

Tractor Body
Trailer Body
Tractor Track Width
Trailer Track Width
Trailer Track Width
Tractor Body
Tractor Lock to Lock Time 58 Steering Angle (SA) 30 deg 31 Articulating Angle (AA) 64 deg 35 30 Steering Linkage Data 74 35 30 64 30

: 9'-6"

KEY MAP

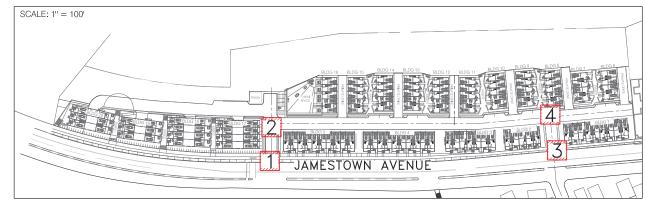



JAMESTOWN CANDLESTICK POINT SAN FRANCISCO, CA



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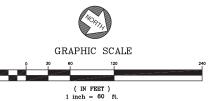
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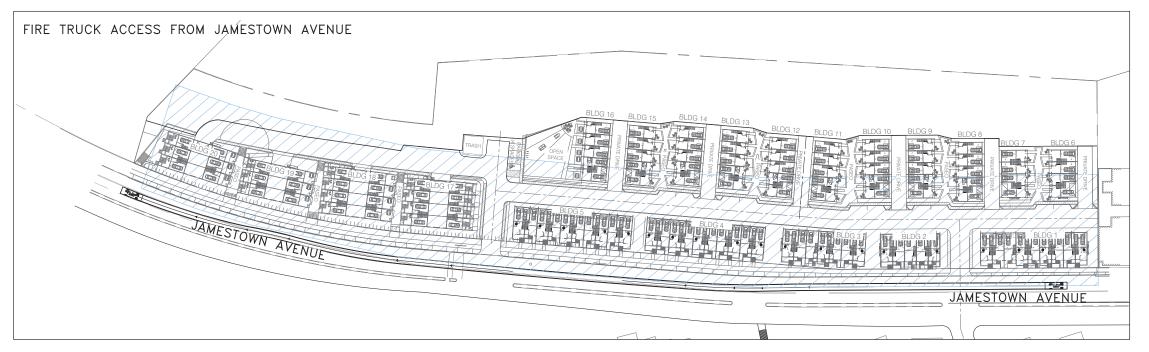
DESIGNED: LEK DRAWN: JKL CHECKED: JJT


SFFD LADDER TRUCK ACCESS SHEET 12 OF 14

SCALE: 1" = 30' DATE: 06.05.2020 PROJECT: 275002 SITE PERMIT APPLICATION — - PROPERTY LINE

150 FOOT RADIUS AROUND FIRE TRUCK





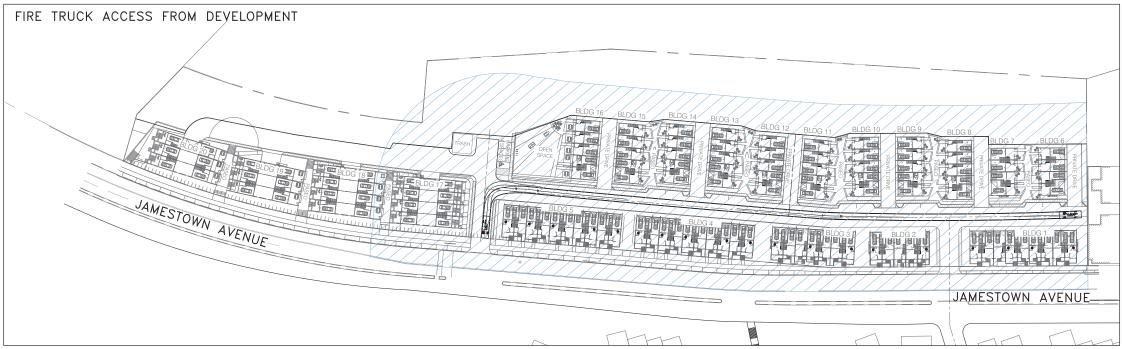



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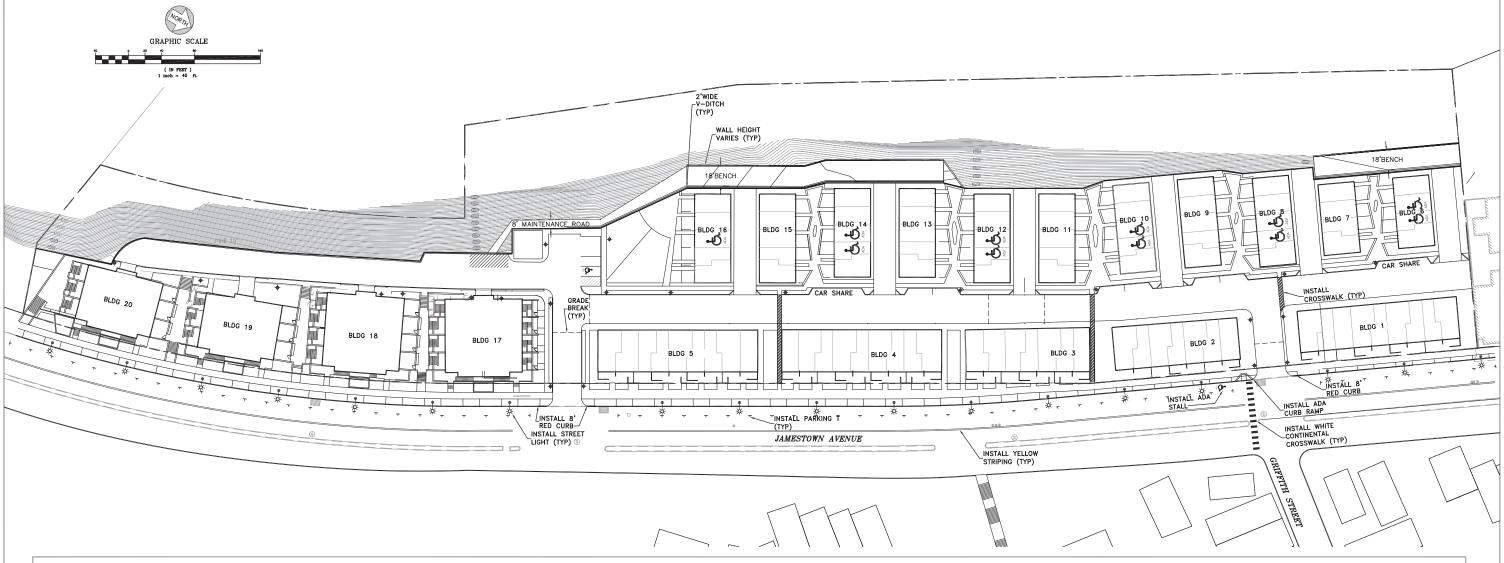
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DESIGNED: LEK DRAWN: JKL CHECKED: JJT

SFFD FIRE TRUCK ACCESS SHEET 13 OF 14

SCALE: 1" = 60'
DATE: 06.05.2020
PROJECT: 275002
SITE PERMIT APPLICATION









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DESIGNED: LEK DRAWN: JKL CHECKED: JJT

PARKING AND STRIPING PLAN SHEET 14 OF 14


SCALE: 1" = 40'
DATE: 06.05.2020
PROJECT: 275002
SITE PERMIT APPLICATION



PART VI UNIT PLANS



-DECK BD. 3 DIN. 11'-6" x 7-8" LIV. 15'-0" x 11'-10" 2650 SH 3050 SH 2650 SF

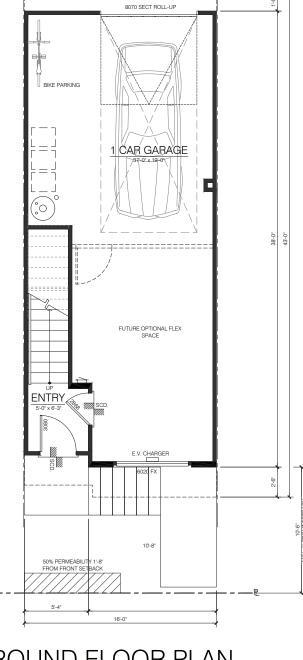

GENERAL NOTE: RECESS WINDOWS FACING JAMESTOWN @ STUCCO

ROOF DECK PLAN

280 SQ. FT PLAN 1 ROOF DECK: TOTAL ROOF AREA: 648 SQ. FT. SOLAR ROOF AREA: 100 SQ.FT.

UPPER FLOOR PLAN

PLAN 1 UPPER LIVING: 607 SQ. FT.

MAIN FLOOR PLAN

PLAN 1 MAIN LIVING: 658 SQ. FT. TOTAL LIVING: 1296 SQ. FT.

DECK:

GROUND FLOOR PLAN

PLAN 1 GROUND LIVING: 31 SQ. FT. GARAGE: 571 SQ. FT.



JAMESTOWN CANDLESTICK POINT SAN FRANCISCO, CA



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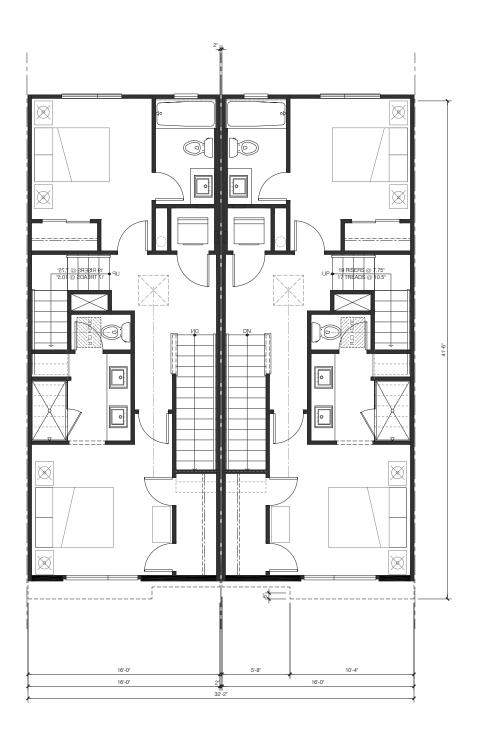
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13 SQ. FT.

PLAN 1 W/ ROOF DECK

PRELIMINARY PROJECT ASSESSMENT APPLICATION ORIGINAL SUBMITTAL DATE: MARCH 05, 2019 MARCH 09, 2020 RESUBMITTAL DATE: RESUBMITTAL DATE: JUNE 05, 2020 RESUBMITTAL DATE: JUNE 25, 2020

A6.0



UPPER FLOOR PLAN

PLAN 2 - 3 INT

PLAN 2 - UPPER LIVING: 619 SQ. FT.

PLAN 3 - UPPER LIVING: 631 SQ. FT.



GENERAL NOTE:
RECESS WINDOWS FACING
JAMESTOWN @ STUCCO

MAIN FLOOR PLAN

PLAN 2 - 3 INT

PLAN 2 - MAIN LIVING: 667 SQ. FT. PLAN 3 - MAIN LIVING: 620 SQ. FT. TOTAL LIVING: 1324 SQ. FT. TOTAL LIVING: 1527 SQ. FT. DECK: 13 SQ. FT. DECK: 46 SQ. FT.



RESUBMITTAL DATE:

1 CAR GARAGE

BIKE PARKING

CHARGER

PLAN 2 - 3 - INT

PLAN 2 - GROUND LIVING: GARAGE: 38 SQ. FT. PLAN 3 - OPT. A - GROUND LIVING: 460 SQ. FT. GARAGE: PATIO:

JUNE 25, 2020

2 CAR GARAGE

BTH.2

FUTURE OPTIONAL FLEX SPACE

CHARGER PARKING

BD. 3

PATIO 101 SQ. FT.

> 428 SQ. FT. 101 SQ.FT.

277 SQ. FT.



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PLAN 2&3 W/ ROOF DECK

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RESUBMITTAL DATE: MARCH 09, 2020
RESUBMITTAL DATE: JUNE 05, 2020

A6.1

SCALE: 1/4"=1'-0"

DATE: 06.25.2020

PROJECT: 348001



ROOF DECK PLAN

PLAN 2 - 3 - END

PLAN 2 - ROOF DECK: 306 SQ. FT. TOTAL ROOF: SOLAR:

677 SQ. FT. 100 SQ.FT. SOLAR:

PLAN 3 - ROOF DECK: 348 SQ. FT. TOTAL ROOF:

753 SQ. FT. 100 SQ.FT.



JAMESTOWN CANDLESTICK POINT SAN FRANCISCO, CA



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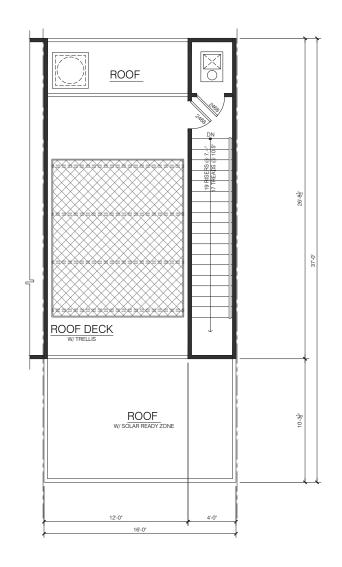
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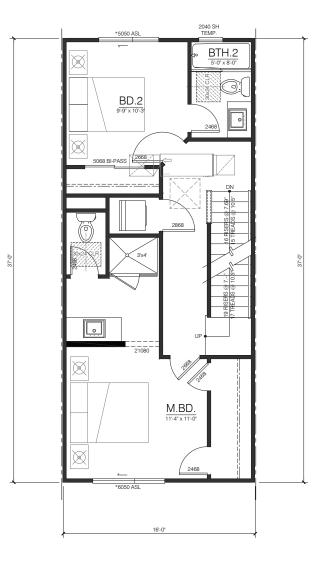
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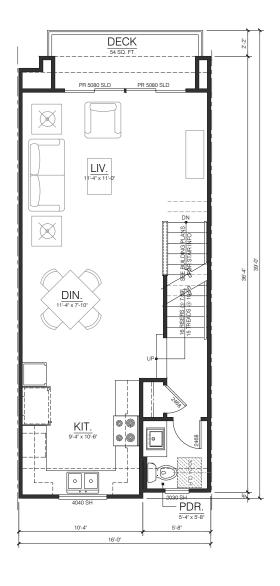
PLAN 2&3 W/ ROOF DECK


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A6.2







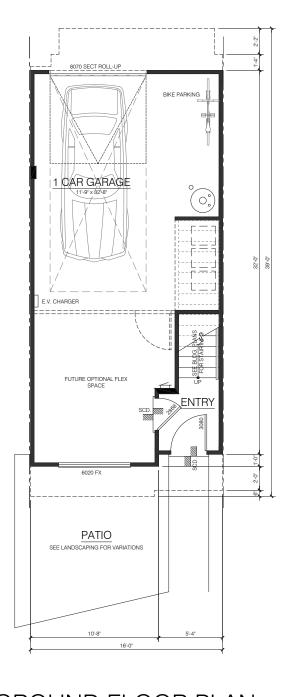

ROOF DECK PLAN

250 SQ. FT. **ROOF DECK:** PLAN 4 TOTAL ROOF: 592 SQ. FT. SOLAR: 100 SQ.FT.

UPPER FLOOR PLAN

537 SQ. FT. UPPER LIVING: PLAN 4

MAIN FLOOR PLAN

MAIN LIVING: PLAN 4 TOTAL LIVING: DECK:

539 SQ. FT. 1279 SQ.FT. 54 SQ. FT.

GROUND FLOOR PLAN

PLAN 4

GROUND LIVING: 203 SQ. FT. GARAGE: PATIO:

320 SQ. FT. 125 SQ.FT.



JAMESTOWN CANDLESTICK POINT SAN FRANCISCO, CA



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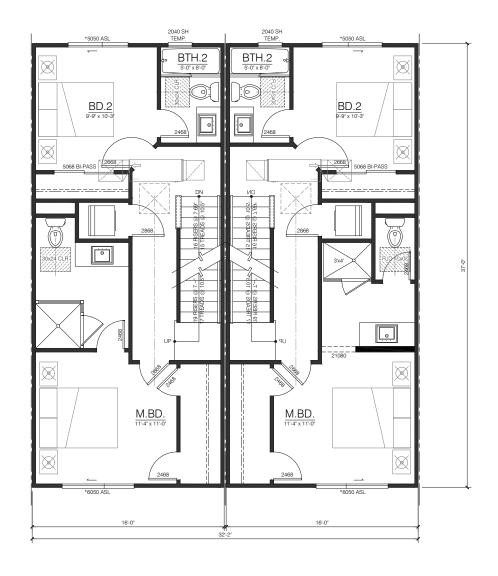
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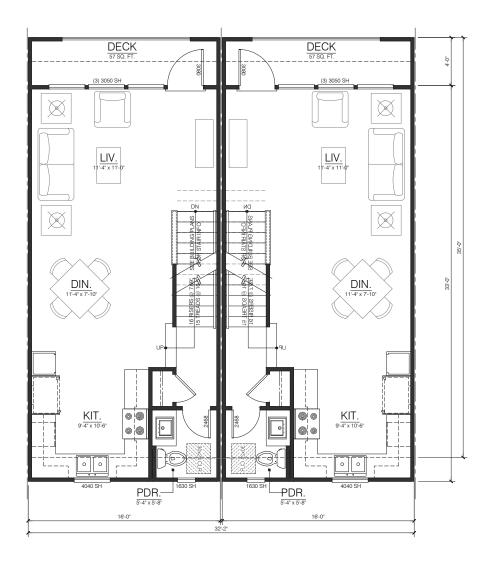
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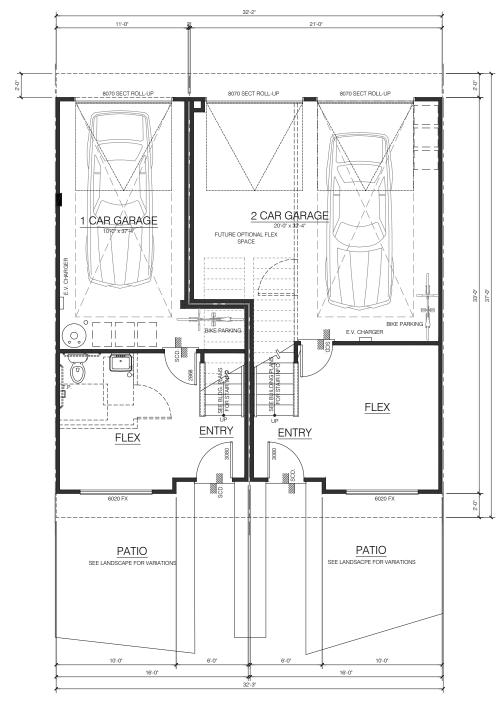
PLAN 4 W/ ROOF DECK

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A6.3







UPPER FLOOR PLAN

PLAN 5-6 - INT

PLAN 5 - UPPER LIVING: 565 SQ. FT.

PLAN 6 - UPPER LIVING: 565 SQ. FT.

MAIN FLOOR PLAN

PLAN 5-6 - INT

 PLAN 5 - MAIN LIVING:
 528 SQ. FT.
 PLAN 6 - MAIN LIVING:
 528 SQ. FT.

 TOTAL LIVING:
 1279 SQ. FT.
 TOTAL LIVING:
 1289 SQ. FT.

 DECK:
 57 SQ. FT.
 DECK:
 57 SQ. FT.

GROUND FLOOR PLAN

RESUBMITTAL DATE:

PLAN 5-6 - INT

PLAN 5 - GROUND LIVING: GARAGE: PATIO: 187 SQ. FT. PLAN 6 250 SQ. FT. GARAG 125 SQ.FT. MIN. PATIO:

PLAN 6 - GROUND LIVING: GARAGE:

197 SQ. FT. 411 SQ. FT. 125 SQ.FT. MIN.



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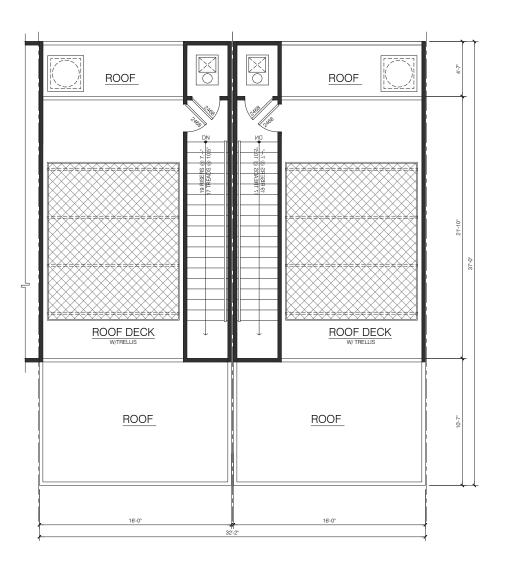
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PLAN 5&6 W/ ROOF DECK

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RESUBMITTAL DATE: JUNE 05, 2020

JUNE 25, 2020

A6.4



ROOF DECK PLAN

PLAN 5-6 - INT

PLAN 5 - ROOF DECK: 252 SQ. FT.
TOTAL ROOF: 592 SQ. FT.
SOLAR: 100 SQ.FT.

PLAN 6 - ROOF DECK: TOTAL ROOF: SOLAR: 252 SQ. FT. 592 SQ. FT. 100 SQ.FT.

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SAN FRANCISCO, CA



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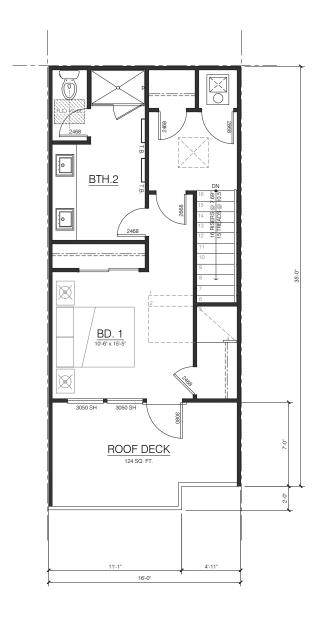
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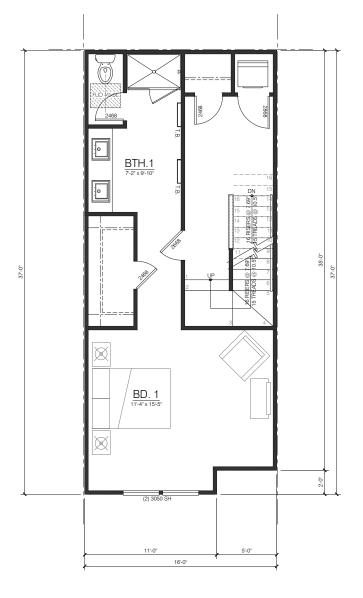
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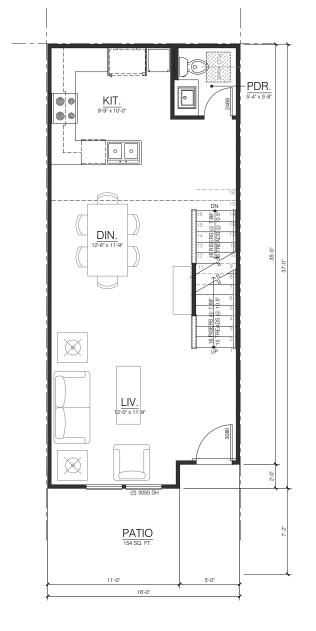
PLAN 5&6 W/ ROOF DECK


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A6.5







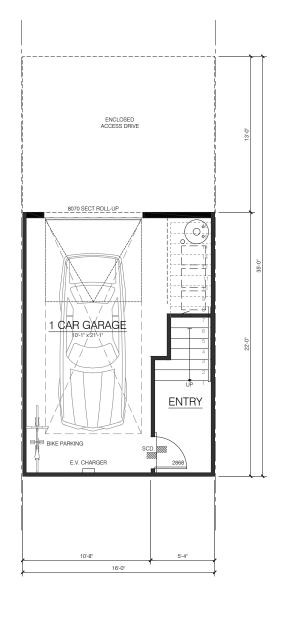

TOP FLOOR PLAN

PLAN 7

TOP FLOOR: **ROOF DECK:** 414 SQ. FT. 124 SQ. FT. **UPPER FLOOR PLAN**

UPPER LIVING: 542 SQ. FT. PLAN 7

MAIN FLOOR PLAN

PLAN 7

MAIN LIVING: TOTAL LIVING: PATIO:

582 SQ. FT. 1605 SQ.FT. 156 SQ.FT.

GROUND FLOOR PLAN

PLAN 7

GROUND LIVING: 67 SQ. FT. GARAGE:

285 SQ. FT.



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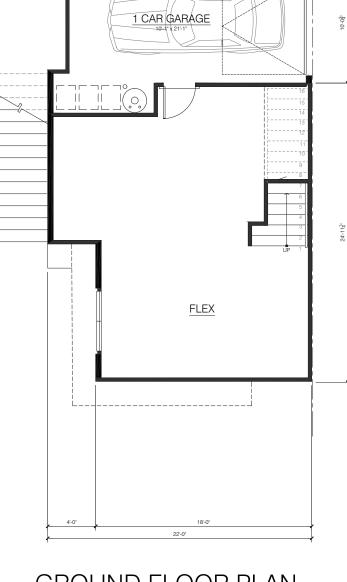
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PLAN 7 A6.6



PDR. PAN. DIN. 12'-0" x 9'-6' KIT. PATIO 9,0'518'-0" 5'-0"



GENERAL NOTE: RECESS WINDOWS FACING JAMESTOWN @ STUCCO

TOP FLOOR PLAN

PLAN 7 - EXT

TOP FLOOR: **ROOF DECK:** 415 SQ. FT. 165 SQ. FT.

UPPER FLOOR PLAN

PLAN 7 - EXT

UPPER LIVING: 774 SQ. FT.

MAIN FLOOR PLAN

PLAN 7 - EXT

MAIN LIVING: TOTAL LIVING: PATIO:

768 SQ. FT. 2428 SQ.FT. 190 SQ. FT.

GROUND FLOOR PLAN

JUNE 25, 2020

PLAN 7A

RESUBMITTAL DATE:

GROUND LIVING: 472 SQ. FT. GARAGE:

241 SQ. FT.



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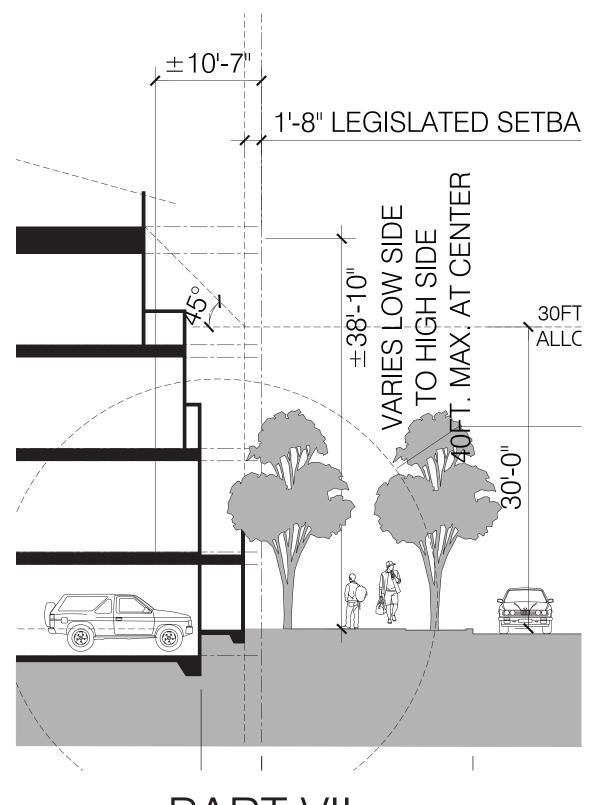
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PLAN 7 EXT

A6.7



PART VII
SITE AND BUILDING SECTIONS
AND CODE CONFORMANCE







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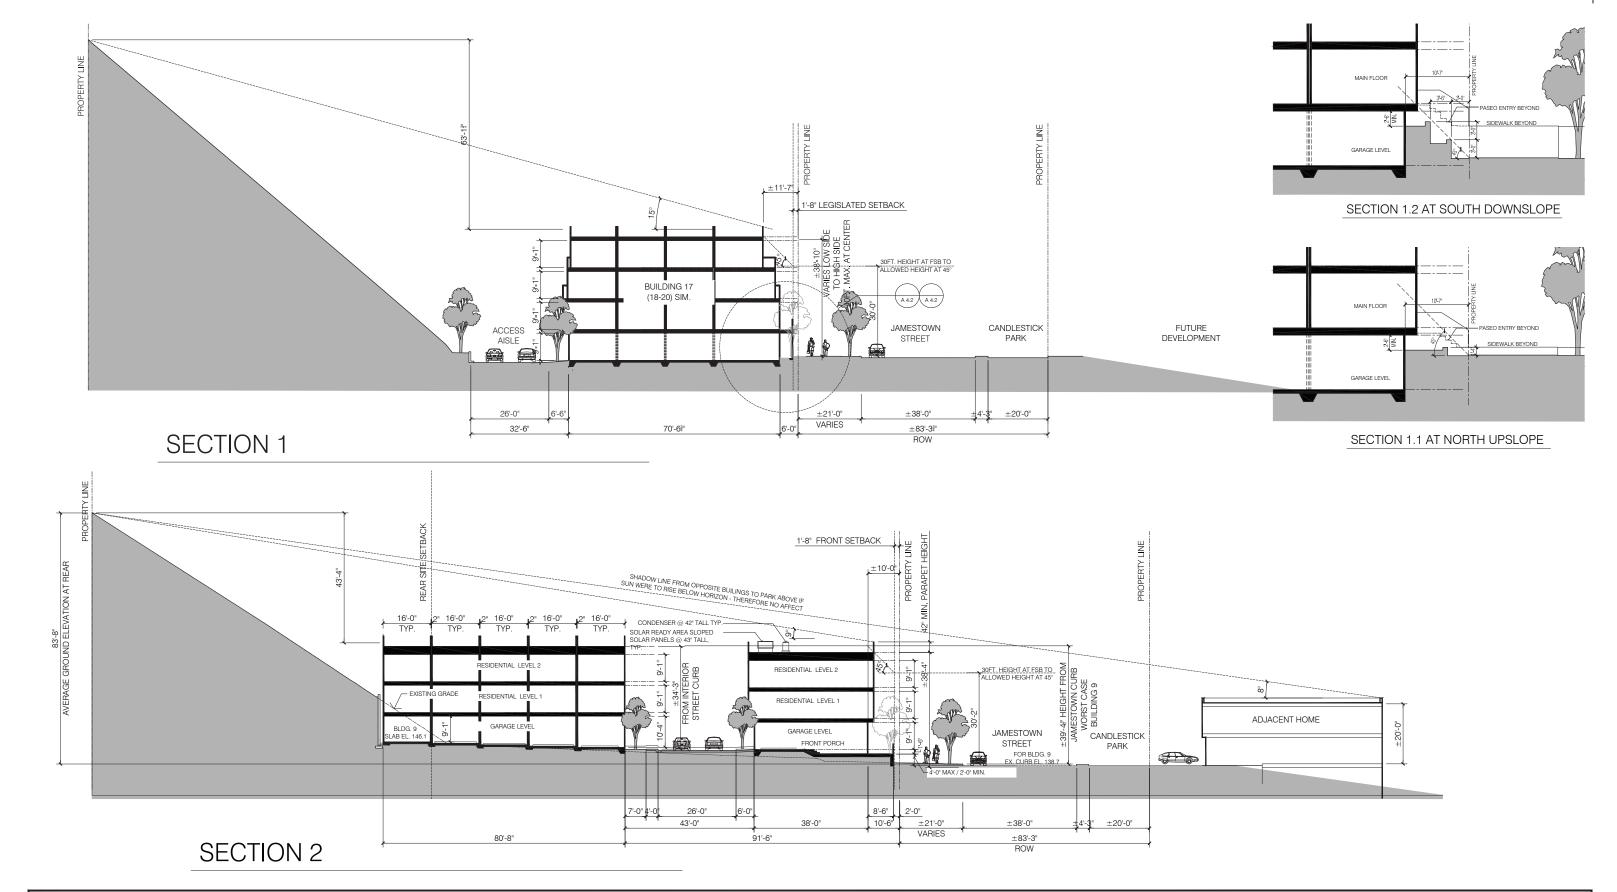
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JAMESTOWN AVE. STREETSCAPE

PRELIMINARY PROJECT ASSESSMENT APPLICATION
ORIGINAL SUBMITTAL DATE: MARCH 05, 2019
RESUBMITTAL DATE: MARCH 09, 2020
RESUBMITTAL DATE: JUNE 05, 2020
RESUBMITTAL DATE: JUNE 25, 2020

A/.(

SCALE: NTS
DATE: 06.25.2020
PROJECT: 348001







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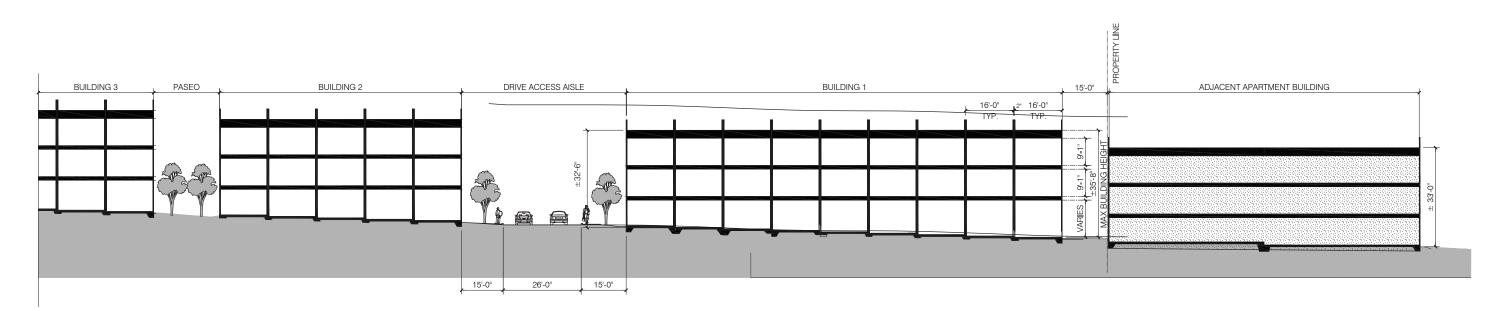
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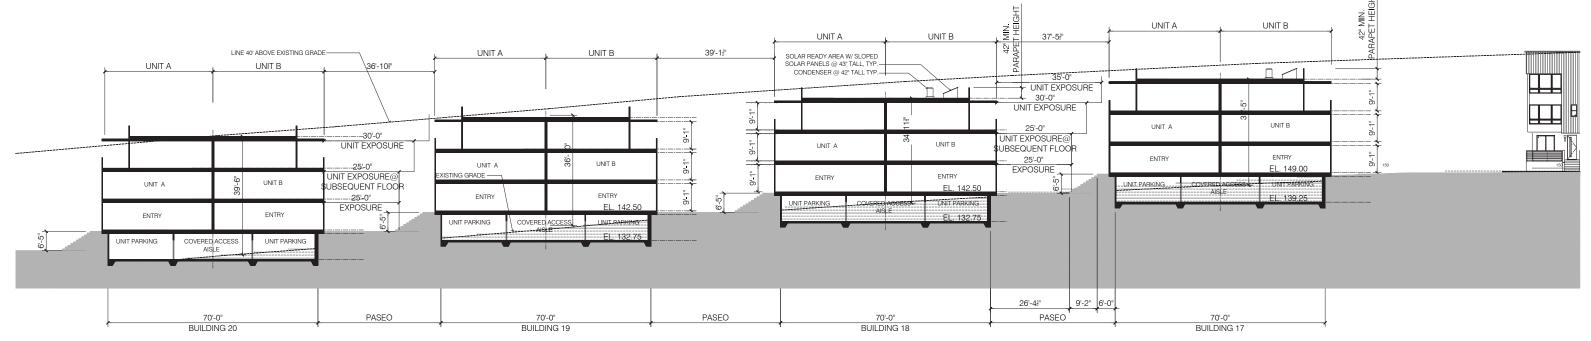
SITE CROSS SECTIONS

PRELIMINARY PROJECT ASSESSMENT APPLICATION
ORIGINAL SUBMITTAL DATE: MARCH 05, 2019
RESUBMITTAL DATE: MARCH 09, 2020
RESUBMITTAL DATE: JUNE 05, 2020
RESUBMITTAL DATE: JUNE 25, 2020

SCALE:1/16" = 1'-0"



SECTION 3 - ADJACENT SITE AND BUILDINGS 1-2



SECTION 4 - BUILDINGS 17-20



JAMESTOWN
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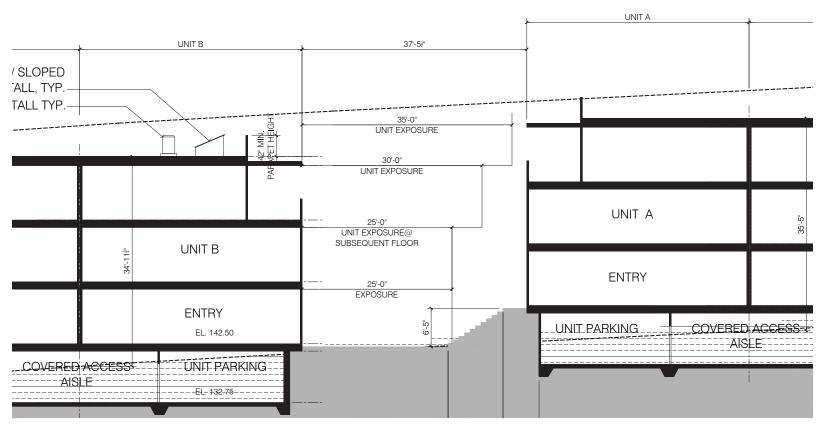
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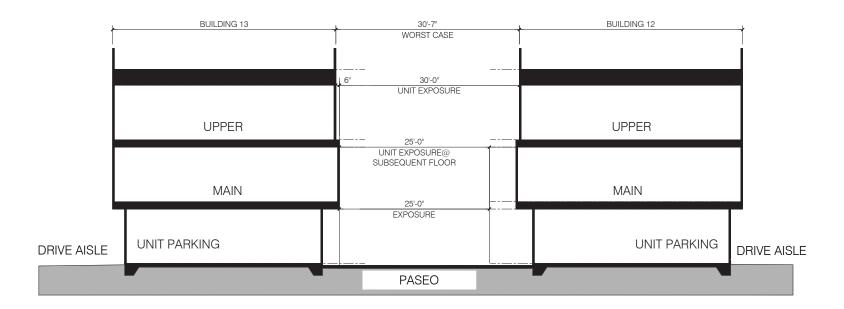
SITE LONGITUDINAL SECTIONS

PRELIMINARY PROJECT ASSESSMENT APPLICATION
ORIGINAL SUBMITTAL DATE: MARCH 05, 2019
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RESUBMITTAL DATE: JUNE 05, 2020
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A7.2



DWELLING UNIT EXPOSURE AT BUILDINGS 17-20



DWELLING UNIT EXPOSURE AT PASEO OF BUILDINGS 6-16



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IDENTIAL LEVEL 2

SIDENTIAL LEVEL 1

GARAGE LEVEL

FRONT PORCH

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DETAILED SECTIONS

FOR BLDG. 9

EX. CURB EL. 138.7

30FT. HEIGHT AT FSB TO ALLOWED HEIGHT AT 45°

A 4.2

30FT. HEIGHT AT FSB TO ALLOWED HEIGHT AT 45°

AMESTOWN

A 4.2

JAMESTOWN STREET

PRELIMINARY PROJECT ASSESSMENT APPLICATION ORIGINAL SUBMITTAL DATE: MARCH 05, 2019 RESUBMITTAL DATE: MARCH 09, 2020 RESUBMITTAL DATE: JUNE 05, 2020 RESUBMITTAL DATE: JUNE 25, 2020

8'-6" 2'-0" MAX / 2'-0" MIN.

HEIGHT LIMITS FROM FSB AT BUILDINGS 1-5

HEIGHT LIMITS FROM FSB AT BUILDINGS 17-20

1'-8" LEGISLATED SETBACK

SCALE:1/16" = 1'-0"


DATE: 06.25.2020 PROJECT:



JAMESTOWN CANDLESTICK POINT SAN FRANCISCO, CA



PART VIII MATERIAL AND COLOR SELECTIONS

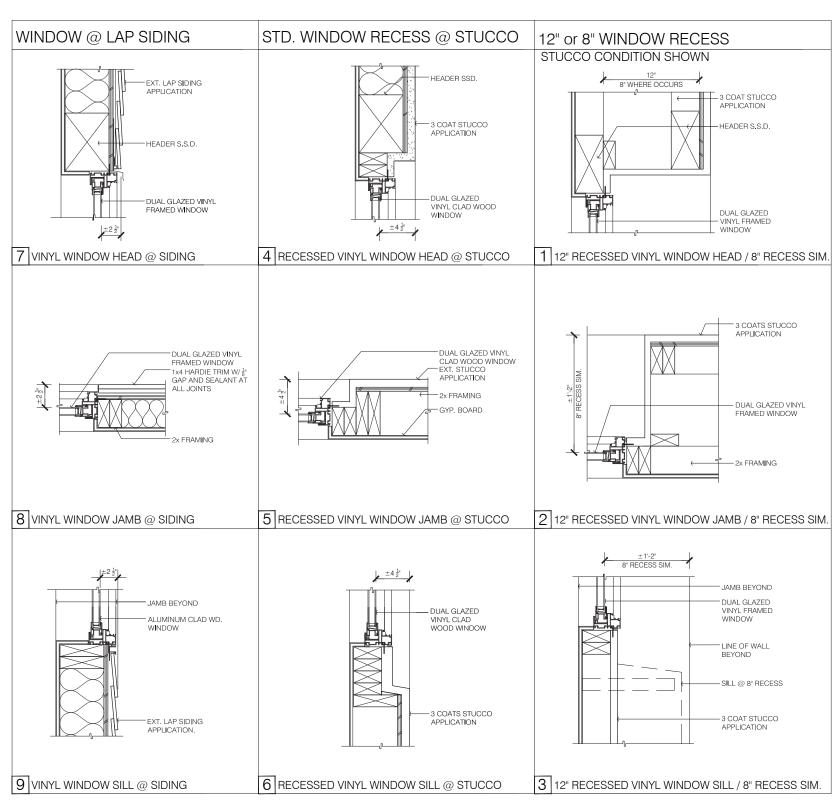





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JAMESTOWN WINDOW DETAILS

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ORIGINAL SUBMITTAL DATE: MARCH 05, 2019
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RESUBMITTAL DATE: JUNE 05, 2020

JUNE 25, 2020

RESUBMITTAL DATE:

A8.U SCALE: NTS



TYPE A - BLDGS. 1-5
















SW 6001 GRAYISH

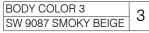

HORIZONTAL SIDING COLOR 4 SW 6001 GRAYISH

HORIZONTAL SIDING COLOR SW 9088 UTAUPEIA

VERTICAL SIDING 6 SW 6001 GRAYISH

VERTICAL SIDING SW 9088 UTAUPEIA

METAL TRIM COLOR SW 7066 GRAY MATTERS















AWNING AND SIDING STUCCO REVEALS COMPOSITION

ENTRY DOOR

GARAGE DOOR 12 ADDRESS SIGN W/ LIGHT 13

WOOD DECK SW 9167 POLISHED CONCRETE 14

WOOD TRELLIS

JAMESTOWN CANDLESTICK POINT SAN FRANCISCO, CA



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TYPE A - BLDGS. 1-5 - MATERIAL BOARD - SCHEME A

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15

A8.1

SCALE: 3/16"=1'-0" DATE: 06.25.2020 PROJECT: 348001



TYPE A - BLDGS. 1-5



BODY COLOR 2 SW 6001 GRAYISH 2



BODY COLOR 3 SW 9087 SMOKY BEIGE 3



HORIZONTAL SIDING COLOR SW 6001 GRAYISH 4



HORIZONTAL SIDING COLOR SW 9088 UTAUPEIA 5



VERTICAL SIDING
SW 6001 GRAYISH
6



VERTICAL SIDING
SW 9088 UTAUPEIA
7



METAL TRIM COLOR SW 7066 GRAY MATTERS 8



BODY COLOR 1

SW 7008 ALABASTER

AWNING AND SIDING COMPOSITION



STUCCO REVEALS 10



ENTRY DOOR 11



GARAGE DOOR 12



ADDRESS SIGN W/ LIGHT 13



WOOD DECK SW 9167 POLISHED CONCRETE



WOOD TRELLIS 15



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TYPE A - BLDGS. 1-5 - MATERIAL BOARD - SCHEME B

PRELIMINARY PROJECT ASSESSMENT APPLICATION
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RESUBMITTAL DATE: JUNE 25, 2020

A8.2

SCALE: 3/16"=1'-0"



FRONT ELEVATION - COLOR SCHEME

TYPE B - BLDGS. 6-16



BODY COLOR 1 SW 7008 ALABASTER



STUCCO REVEALS

AWNING AND SIDING COMPOSITION



BODY COLOR 2 SW 6001 GRAYISH



BODY COLOR 3 3 SW 9087 SMOKY BEIGE

ENTRY DOOR



HORIZONTAL SIDING COLOR 4 SW 6001 GRAYISH



HORIZONTAL SIDING COLOR SW 9088 UTAUPEIA



VERTICAL SIDING 6 SW 6001 GRAYISH



VERTICAL SIDING SW 9088 UTAUPEIA



METAL TRIM COLOR SW 7066 GRAY MATTERS



GARAGE DOOR 12



ADDRESS SIGN W/ LIGHT 13



WOOD DECK SW 9167 POLISHED CONCRETE 14



WOOD TRELLIS 15

RESUBMITTAL DATE:



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Architecture | Planning | Interiors TYPE B - BLDGS. 6-16 - MATERIAL BOARD - COLOR SCHEME

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A8.3 SCALE: 3/16"=1'-0"






SIDE ELEVATION - COLOR SCHEME A

TYPE C - BLDGS. 17 -20

FRONT ELEVATION - COLOR SCHEME A

TYPE C - BLDGS. 17 -20



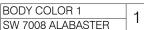



SW 6001 GRAYISH



BODY COLOR 3 3 SW 9087 SMOKY BEIGE



HORIZONTAL SIDING COLOR 4 SW 6001 GRAYISH



HORIZONTAL SIDING COLOR SW 9088 UTAUPEIA



VERTICAL SIDING SW 6001 GRAYISH



VERTICAL SIDING SW 9088 UTAUPEIA



METAL TRIM COLOR SW 7066 GRAY MATTERS



AWNING AND SIDING COMPOSITION



STUCCO REVEALS



ENTRY DOOR



GARAGE DOOR 12



ADDRESS SIGN W/ LIGHT 13



WOOD DECK SW 9167 POLISHED CONCRETE 14



WOOD TRELLIS 15



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TYPE C - BLDGS. 17 - 20 - MATERIAL BOARD - SCHEME A

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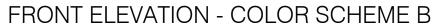
A8.4 SCALE: 3/16"=1'-0"





SIDE ELEVATION - COLOR SCHEME B

TYPE C - BLDGS. 17 -20



TYPE C - BLDGS. 17 -20



BODY COLOR 1 SW 7008 ALABASTER



AWNING AND SIDING



SW 6001 GRAYISH



BODY COLOR 3 3 SW 9087 SMOKY BEIGE



HORIZONTAL SIDING COLOR 4 SW 6001 GRAYISH



HORIZONTAL SIDING COLOR SW 9088 UTAUPEIA



VERTICAL SIDING SW 6001 GRAYISH



VERTICAL SIDING SW 9088 UTAUPEIA




METAL TRIM COLOR SW 7066 GRAY MATTERS



COMPOSITION



STUCCO REVEALS

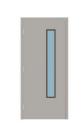

ENTRY DOOR



GARAGE DOOR 12



ADDRESS SIGN W/ LIGHT 13



WOOD DECK SW 9167 POLISHED CONCRETE 14



WOOD TRELLIS 15



JAMESTOWN CANDLESTICK POINT SAN FRANCISCO, CA



Architecture Planning Interiors

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TYPE C - BLDGS. 17 - 20 - MATERIAL BOARD - SCHEME B

PRELIMINARY PROJECT ASSESSMENT APPLICATION ORIGINAL SUBMITTAL DATE: MARCH 05, 2019 MARCH 09, 2020 RESUBMITTAL DATE: RESUBMITTAL DATE: JUNE 05, 2020 RESUBMITTAL DATE: JUNE 25, 2020

A8.5 SCALE: 3/16"=1'-0"

	MONITORING AND REPORTING PROGRAM			
Adopted Mitigation Measures MITIGATION MEASURES AGREED TO BY PROJECT SPONSOR	Implementation Responsibility	Mitigation Schedule	Monitoring/ Reporting Responsibility	Monitoring Actions/ Schedule and Verification of Compliance
CULTURAL RESOURCES				
Project Mitigation Measure 1: Accidental Discovery The following mitigation measure is required to avoid any potential adverse effect from the proposed project on accidentally discovered buried or submerged historical resources as defined in CEQA Guidelines section 15064.5(a) and (c) and on human remains and associated or unassociated funerary objects. The project sponsor shall distribute the Planning Department archeological resource "ALERT" sheet to the project prime contractor; to any project subcontractor (including demolition, excavation, grading, foundation, pile driving, etc. firms); or utilities firm involved in soils disturbing activities within the project site. Prior to any soils disturbing activities being undertaken each contractor is responsible for ensuring that the "ALERT" sheet is circulated to all field personnel including, machine operators, field crew, pile drivers, supervisory personnel, etc.	Project sponsor at the direction of the ERO	Prior to and during soils- disturbing activities	Project sponsor shall distribute Alert sheet and shall submit a signed affidavit confirming the distribution to the ERO	Considered complete when ERO receives signed affidavit
The project sponsor shall provide the Environmental Review Officer (ERO) with a signed affidavit from the responsible parties (prime contractor, subcontractor(s), and utilities firm) to the ERO confirming that all field personnel have received copies of the Alert Sheet.				
Should any indication of an archeological resource be encountered during any soils disturbing activity of the project, the project Head Foreman and/or project sponsor shall immediately notify the ERO and shall immediately suspend any soils disturbing activities in the vicinity of the discovery until the ERO has determined what additional measures should be undertaken.				

MONITORING	AND REPORTING PROC	GRAM

				Monitoring Actions/
				Schedule and
	Implementation	Mitigation	Monitoring/Reporting	Verification of
Adopted Mitigation Measures	Responsibility	Schedule	Responsibility	Compliance
If the ERO determines that an archeological resource may be present	Project sponsor/	Accidental	In the event of accidental	Considered complete
within the project site, the project sponsor shall retain the services of	Head Foreman	discovery	discovery, the project	when archeological
an archeological consultant from the pool of qualified archeological	and		sponsor shall suspend	consultant completes
consultants maintained by the Planning Department archeologist. The	archeological		soils-disturbing activities,	additional measures as
archeological consultant shall advise the ERO as to whether the	consultant at the		notify the ERO, and retain	directed by the ERO as
discovery is an archeological resource, retains sufficient integrity, and	direction of the		a qualified archeological	warranted
is of potential scientific/historical/cultural significance. If an	ERO		consultant at the direction	
archeological resource is present, the archeological consultant shall			of the ERO. The	
identify and evaluate the archeological resource. The archeological			archeological consultant	
consultant shall make a recommendation as to what action, if any, is			shall identify and evaluate	
warranted. Based on this information, the ERO may require, if			the archeological	
warranted, specific additional measures to be implemented by the			resources and recommend	
project sponsor.			actions for review and	
			approval by the ERO. The	
Measures might include: preservation in situ of the archeological			archeological consultant	
resource; an archeological monitoring program; an archeological			shall undertake additional	
testing program; and an interpretative program. If an archeological			measures at the direction	
monitoring program, archeological testing program, or an			of the ERO.	
interpretative program is required, it shall be consistent with the				
Environmental Planning (EP) division guidelines for such programs				
and reviewed and approved by the ERO. The ERO may also require				

The treatment of human remains and of associated or unassociated funerary objects discovered during any soils disturbing activity shall comply with applicable State and federal laws. This shall include immediate notification of the Medical Examiner of the City and County of San Francisco and, in the event of the Medical Examiner's determination that the human remains are Native American remains,

that the project sponsor immediately implement a site security program if the archeological resource may be at risk from vandalism,

looting, or other damaging actions.

Monitoring Actions/

Responsibility

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notification of the California State Native American Heritage Commission, which will appoint a Most Likely Descendant (MLD). The MLD will complete his or her inspection of the remains and make recommendations or preferences for treatment within 48 hours of being granted access to the site (Public Resources Code section 5097.98). The ERO also shall be notified immediately upon the discovery of human remains.

Adopted Mitigation Measures

The project sponsor and ERO shall make all reasonable efforts to develop a Burial Agreement ("Agreement") with the MLD, as expeditiously as possible, for the treatment and disposition, with appropriate dignity, of human remains and associated or unassociated funerary objects (as detailed in CEQA Guidelines section 15064.5(d)). The Agreement shall take into consideration the appropriate excavation, removal, recordation, scientific analysis, custodianship, curation, and final disposition of the human remains and associated or unassociated funerary objects. If the MLD agrees to scientific analyses of the remains and/or associated or unassociated funerary objects, the archeological consultant shall retain possession of the remains and associated or unassociated funerary objects until completion of any such analyses, after which the remains and associated or unassociated funerary objects shall be reinterred or curated as specified in the Agreement.

Nothing in existing State regulations or in this mitigation measure compels the project sponsor and the ERO to accept treatment recommendations of the MLD. However, if the ERO, project sponsor and MLD are unable to reach an Agreement on scientific treatment of the remains and associated or unassociated funerary objects, the ERO, with cooperation of the project sponsor, shall ensure that the remains and/or mortuary materials are stored securely and respectfully until

Compliance

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	Implementation	Mitigation	Monitoring/ Reporting	Verification of	
Adopted Mitigation Measures	Responsibility	Schedule	Responsibility	Compliance	
they can be reinterred on the property, with appropriate dignity, in a				_	
location not subject to further or future subsurface disturbance.					

Treatment of historic-period human remains and of associated or unassociated funerary objects discovered during any soil-disturbing activity, additionally, shall follow protocols laid out in the project's archeological treatment documents, and in any related agreement established between the project sponsor, Medical Examiner and the ERO.

The archeological consultant shall submit a Draft Final Archeological Resources Report (FARR) to the ERO that evaluates the historical significance of any discovered archeological resource and describes the archeological and historical research methods employed in the archeological testing/monitoring/data recovery program(s) undertaken. The Draft FARR shall include a curation and deaccession plan for all recovered cultural materials. The Draft FARR shall also include an Interpretation Plan for public interpretation of all significant archeological features.

Copies of the Draft FARR shall be sent to the ERO for review and approval. Once approved by the ERO, the consultant shall also prepare a public distribution version of the FARR. Copies of the FARR direction of the shall be distributed as follows: California Archeological Site Survey Northwest Information Center (NWIC) shall receive one copy and the ERO shall receive a copy of the transmittal of the FARR to the NWIC. The Environmental Planning division of the Planning Department shall receive one bound and one unlocked, searchable PDF copy on CD of the FARR along with copies of any formal site recordation forms (CA DPR 523 series) and/or documentation for nomination to the National Register of Historic Places/California Register of

Archeological consultant at the **ERO**

Following completion of additional measures by archeological consultant as determined by the **ERO**

Submittal of draft FARR to ERO for review and approval. Distribution of the FARR by the archeological consultant

Considered complete upon distribution of approved FARR

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Adopted Mitigation Measures

Historical Resources. In instances of public interest in or the high interpretive value of the resource, the ERO may require a different or additional final report content, format, and distribution than that presented above.

Compliance