

CHINESE HOSPITAL

SAN FRNACISCO, CALIFORNIA

OSHPD # IS-072017 FACILITY NUMBER 14621

INCREMENT NO. 2

OSHPD & CCSF RE-SUBMITTAL - CIVIL


CIVIL WITH UTILITY CONNECTIONS


19 FEBRUARY 2013

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845 JACKSON STREET SAN FRANCISCO, CA

OSHPD # IS-072017 Facility Number 14621

NEW ACUTE CARE HOSPITAL & SKILLED NURSING UNIT

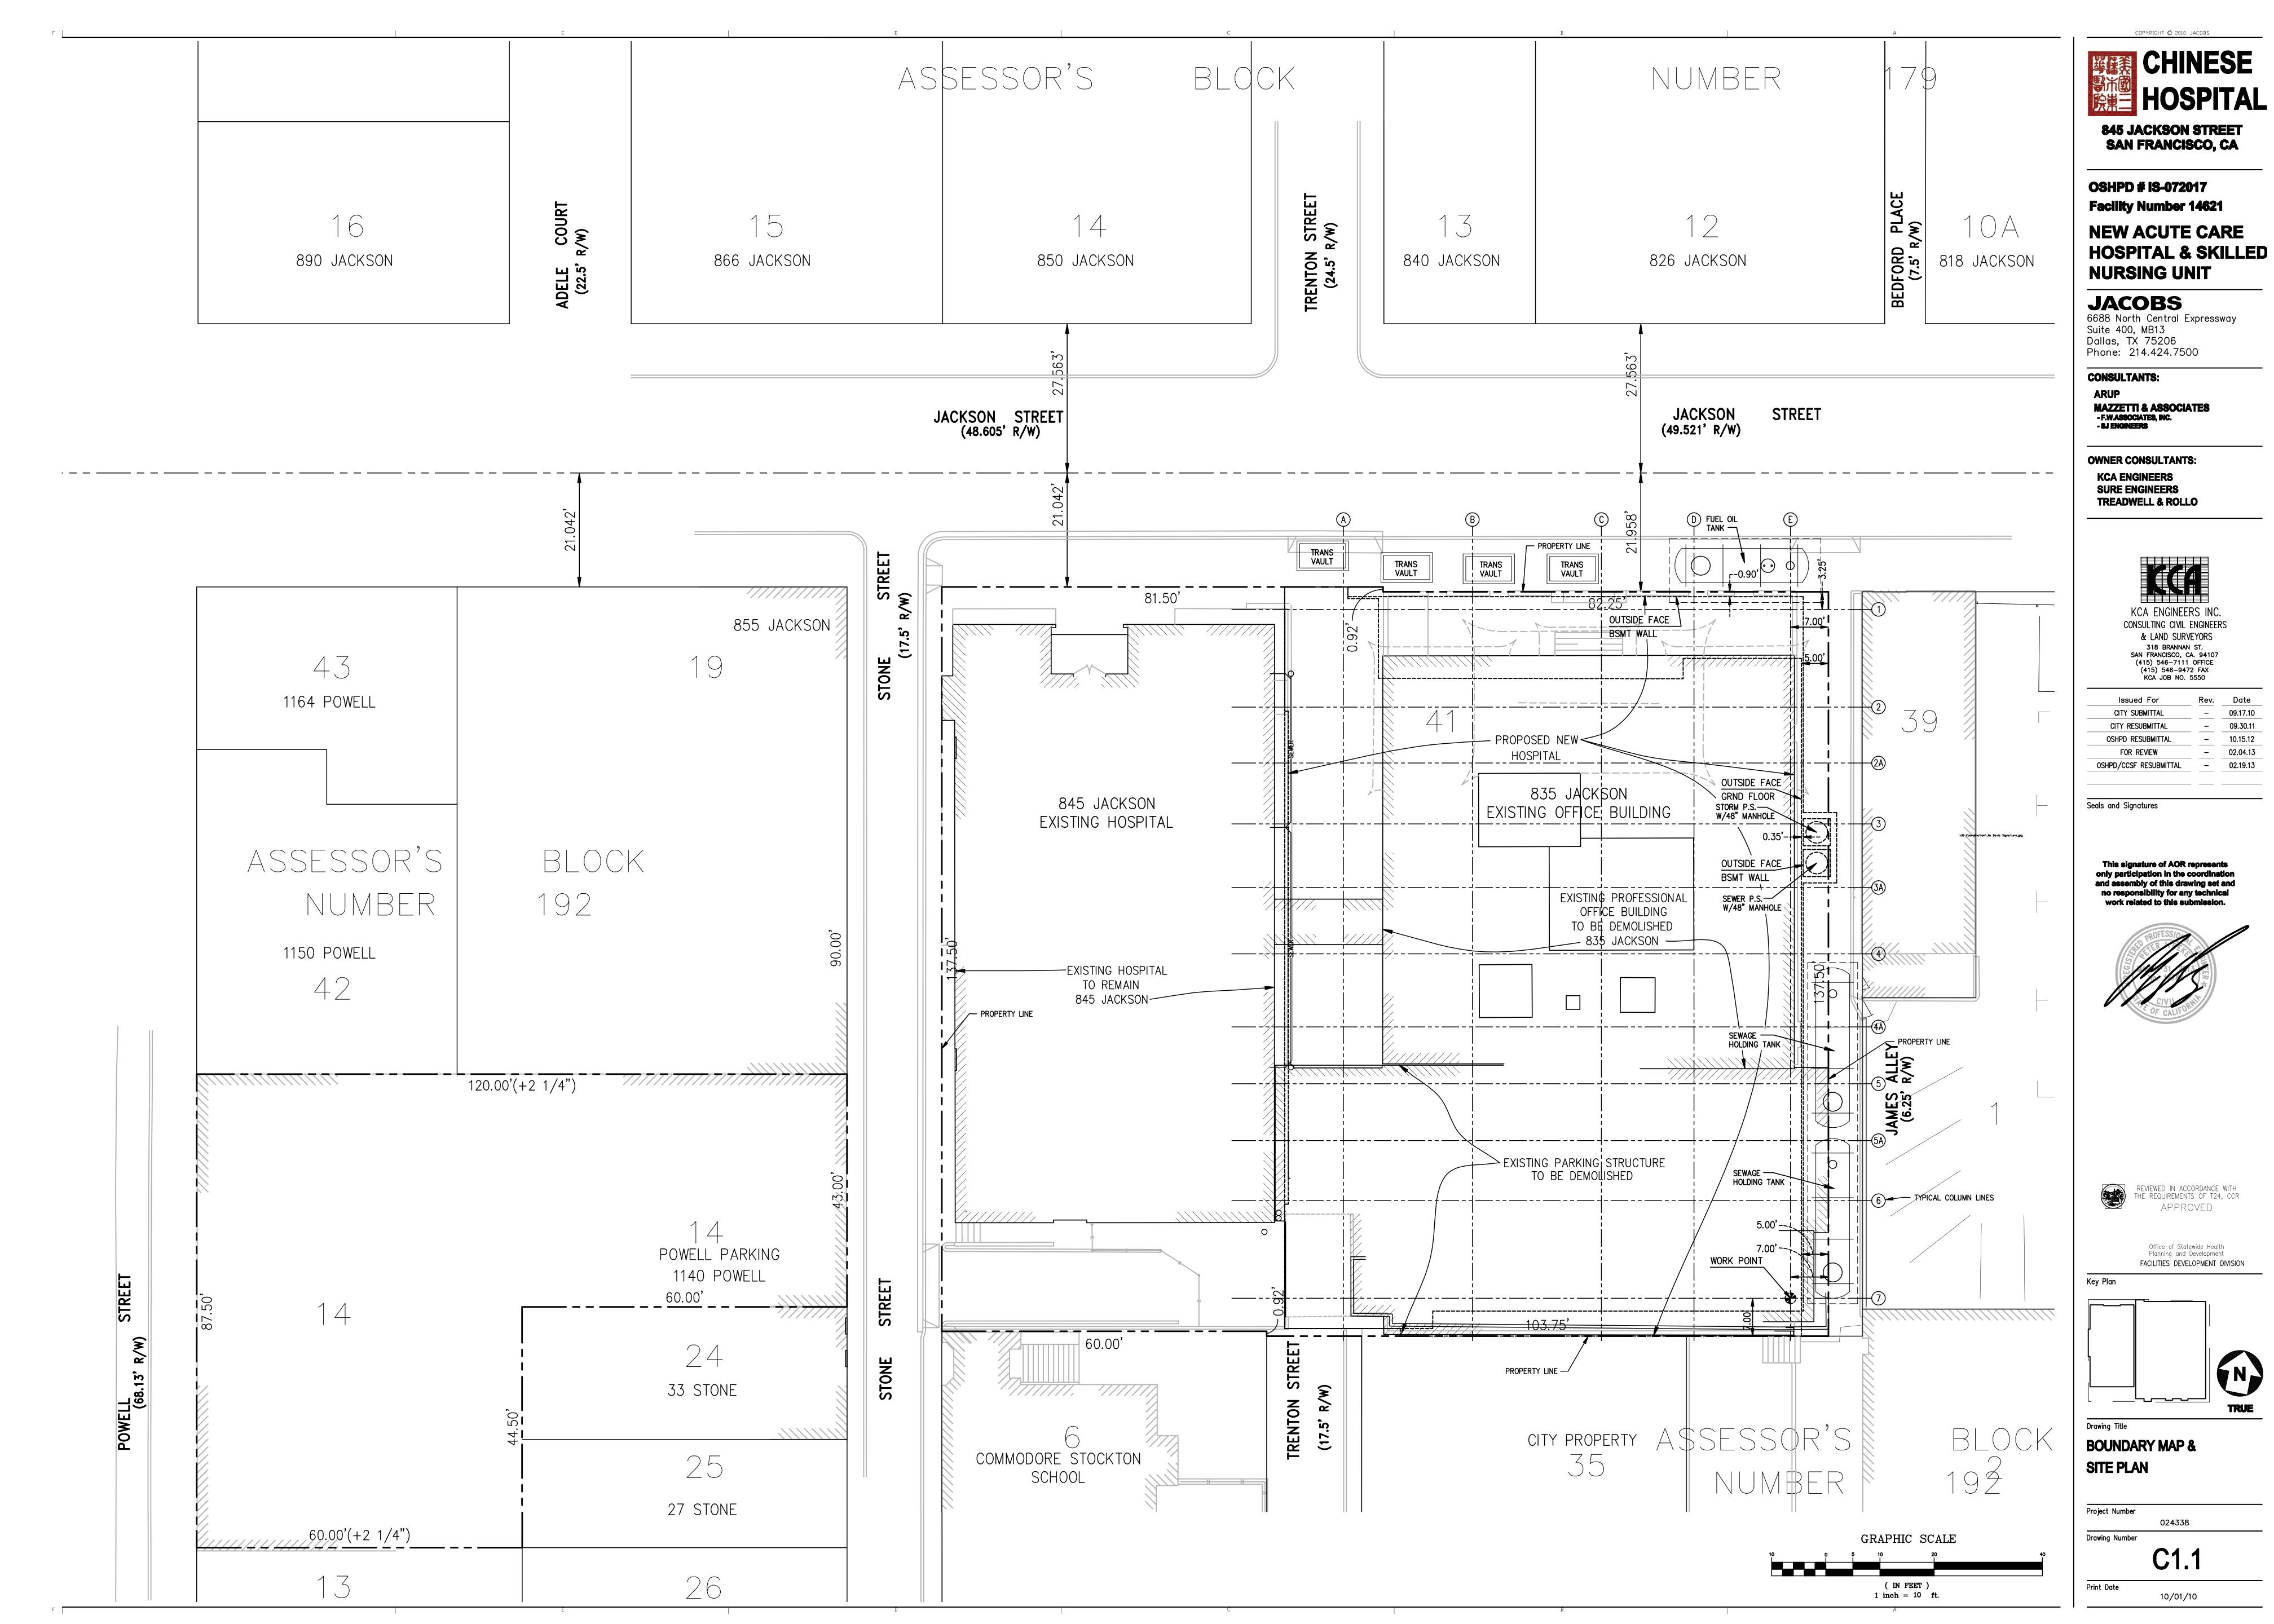JACOBS
6688 North Central Expressway
Suite 400, MB13
Dallas, TX 75206 Phone: 214.424.7500

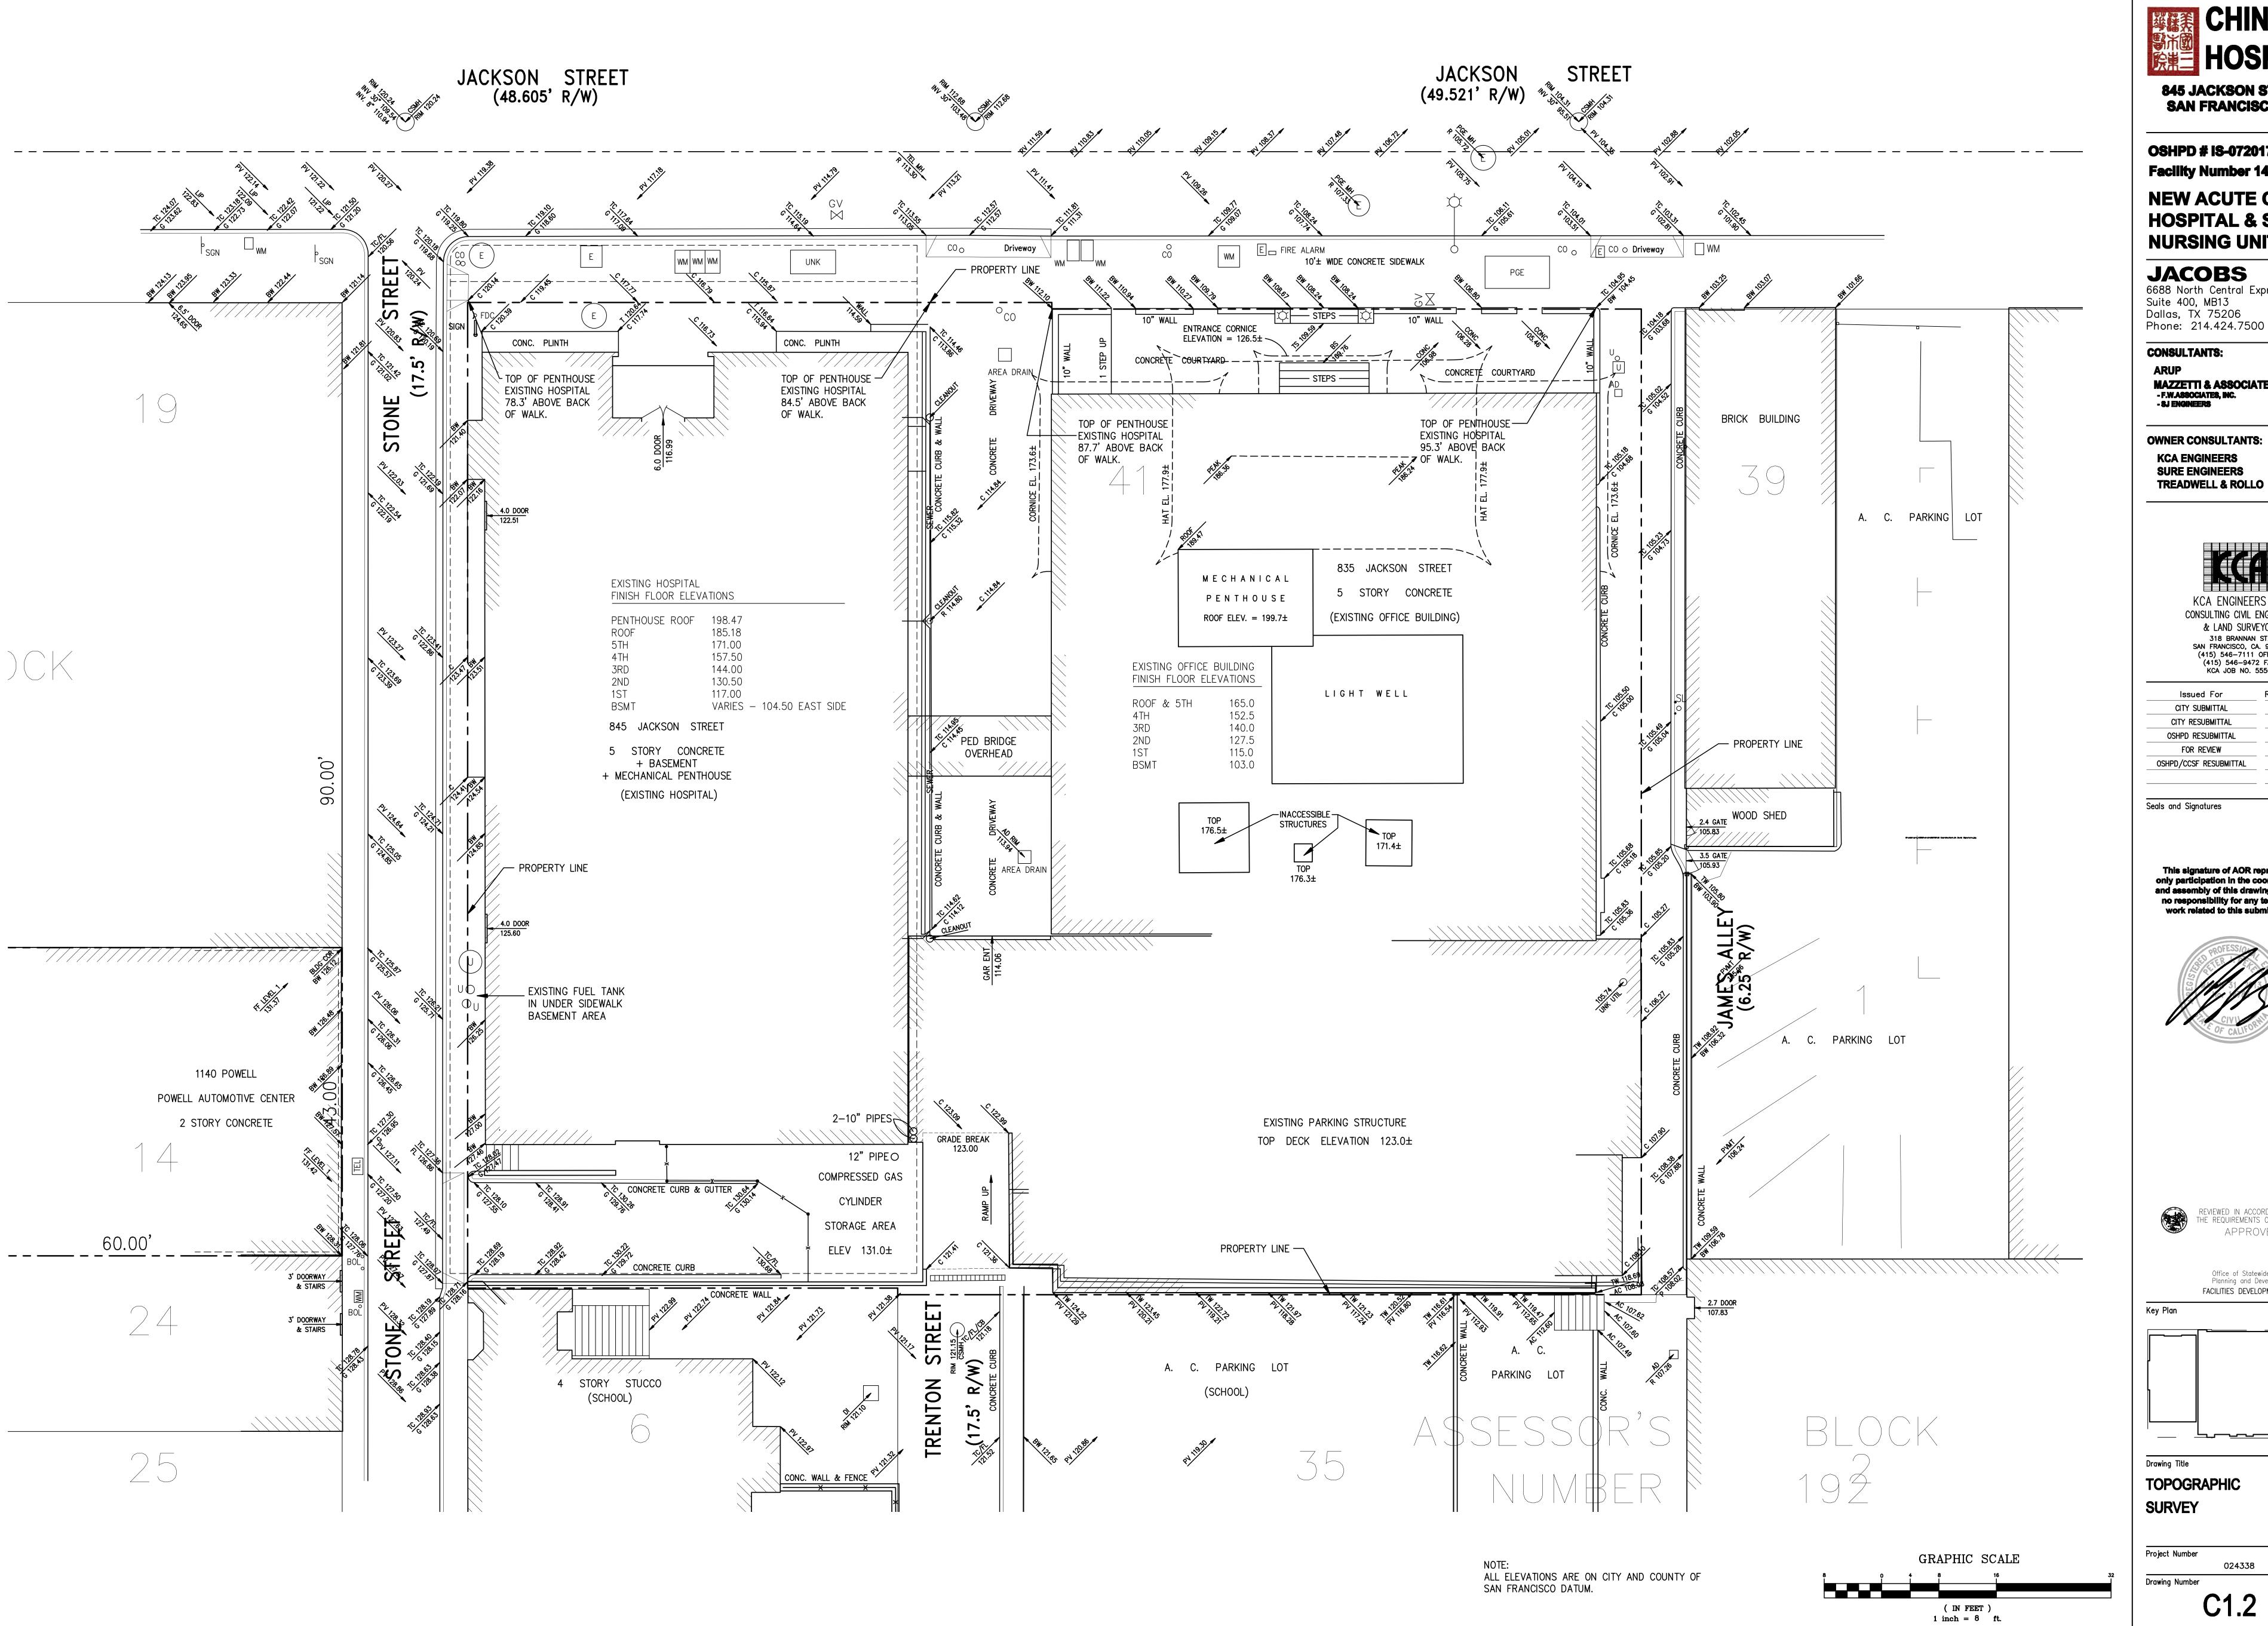CONSULTANTS: MAZZETTI & ASSOCIATES - F.W.ASSOCIATES, INC. - 8J ENGINEERS

OWNER CONSULTANTS: KCA ENGINEERS SURE ENGINEERS

> KCA ENGINEERS INC. CONSULTING CIVIL ENGINEERS & LAND SURVEYORS 318 BRANNAN ST. SAN FRANCISCO, CA. 94107 (415) 546-7111 OFFICE (415) 546-9472 FAX

Issued For	Rev.	Date
CITY SUBMITTAL	_	09.17.10
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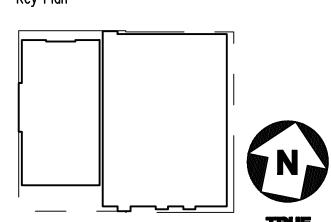
KCA JOB NO. 5550

Seals and Signatures





Office of Statewide Health Planning and Development FACILITIES DEVELOPMENT DIVISION




Drawing Title TOPOGRAPHIC


SURVEY

Project Number Drawing Number

Print Date

JACKSON STREET (48.605' R/W)

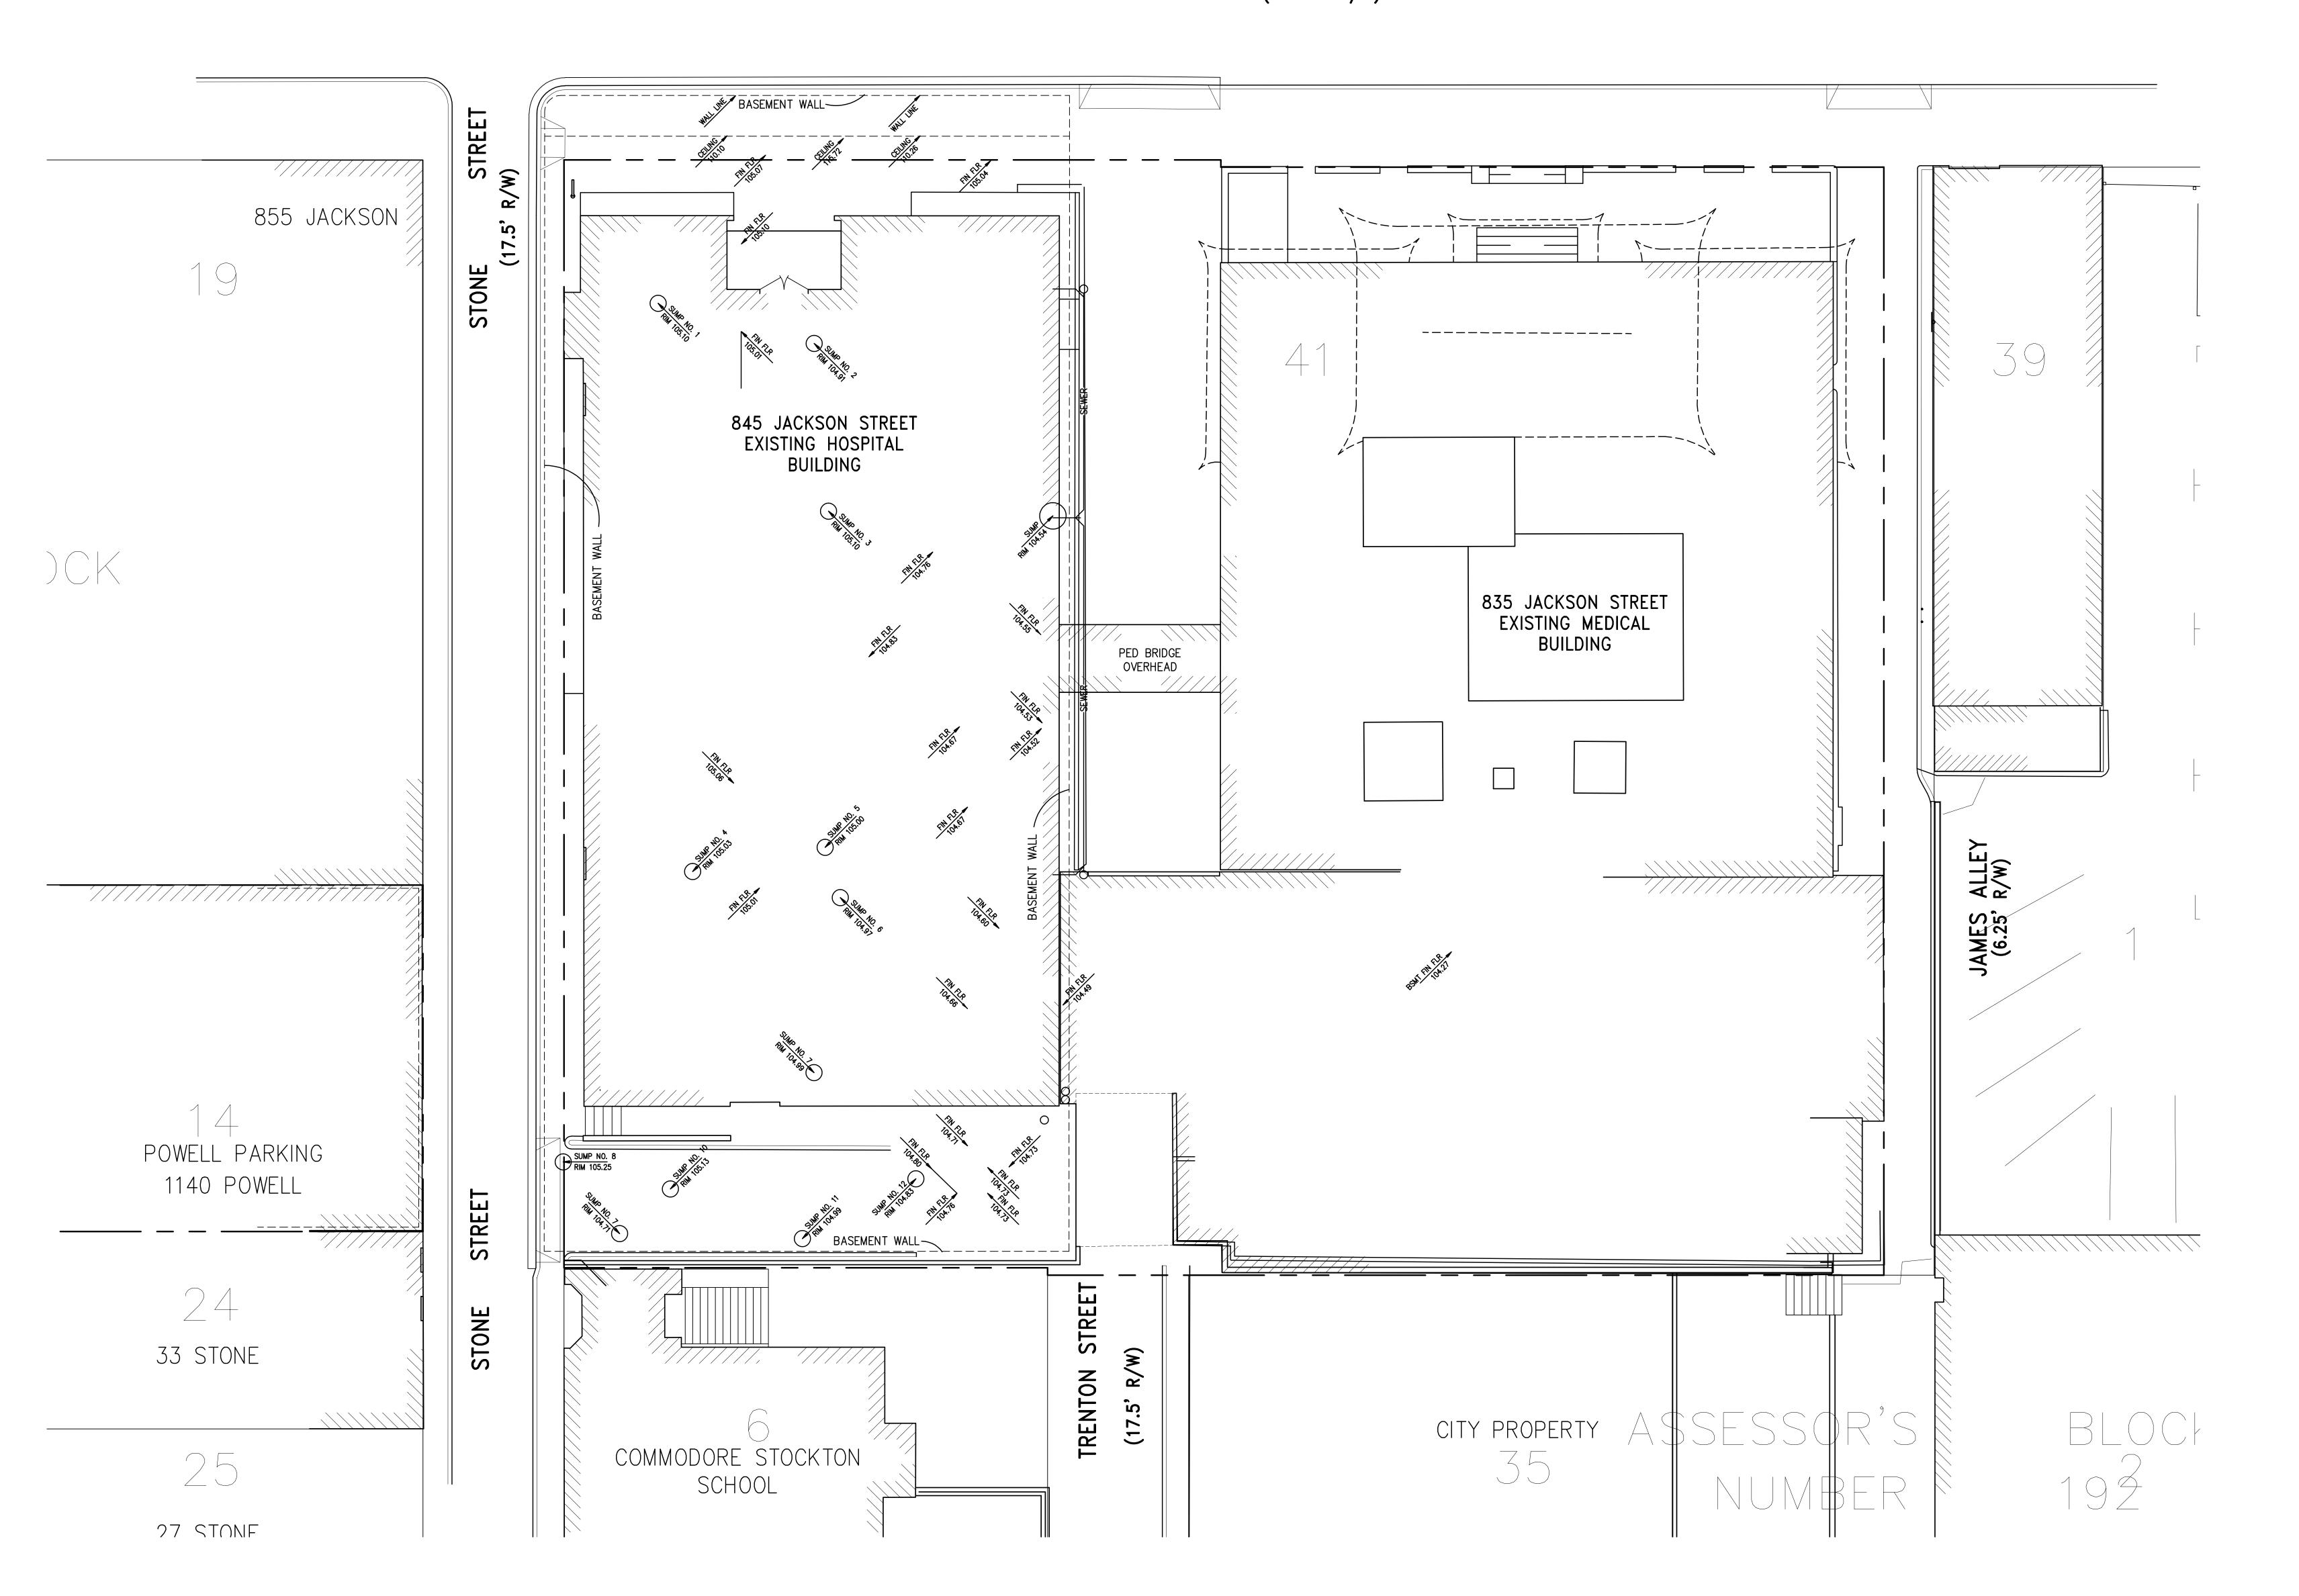

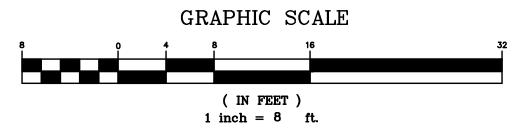



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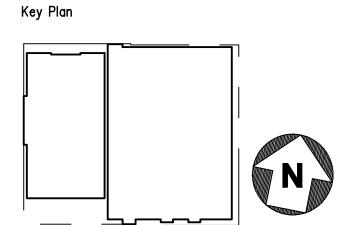
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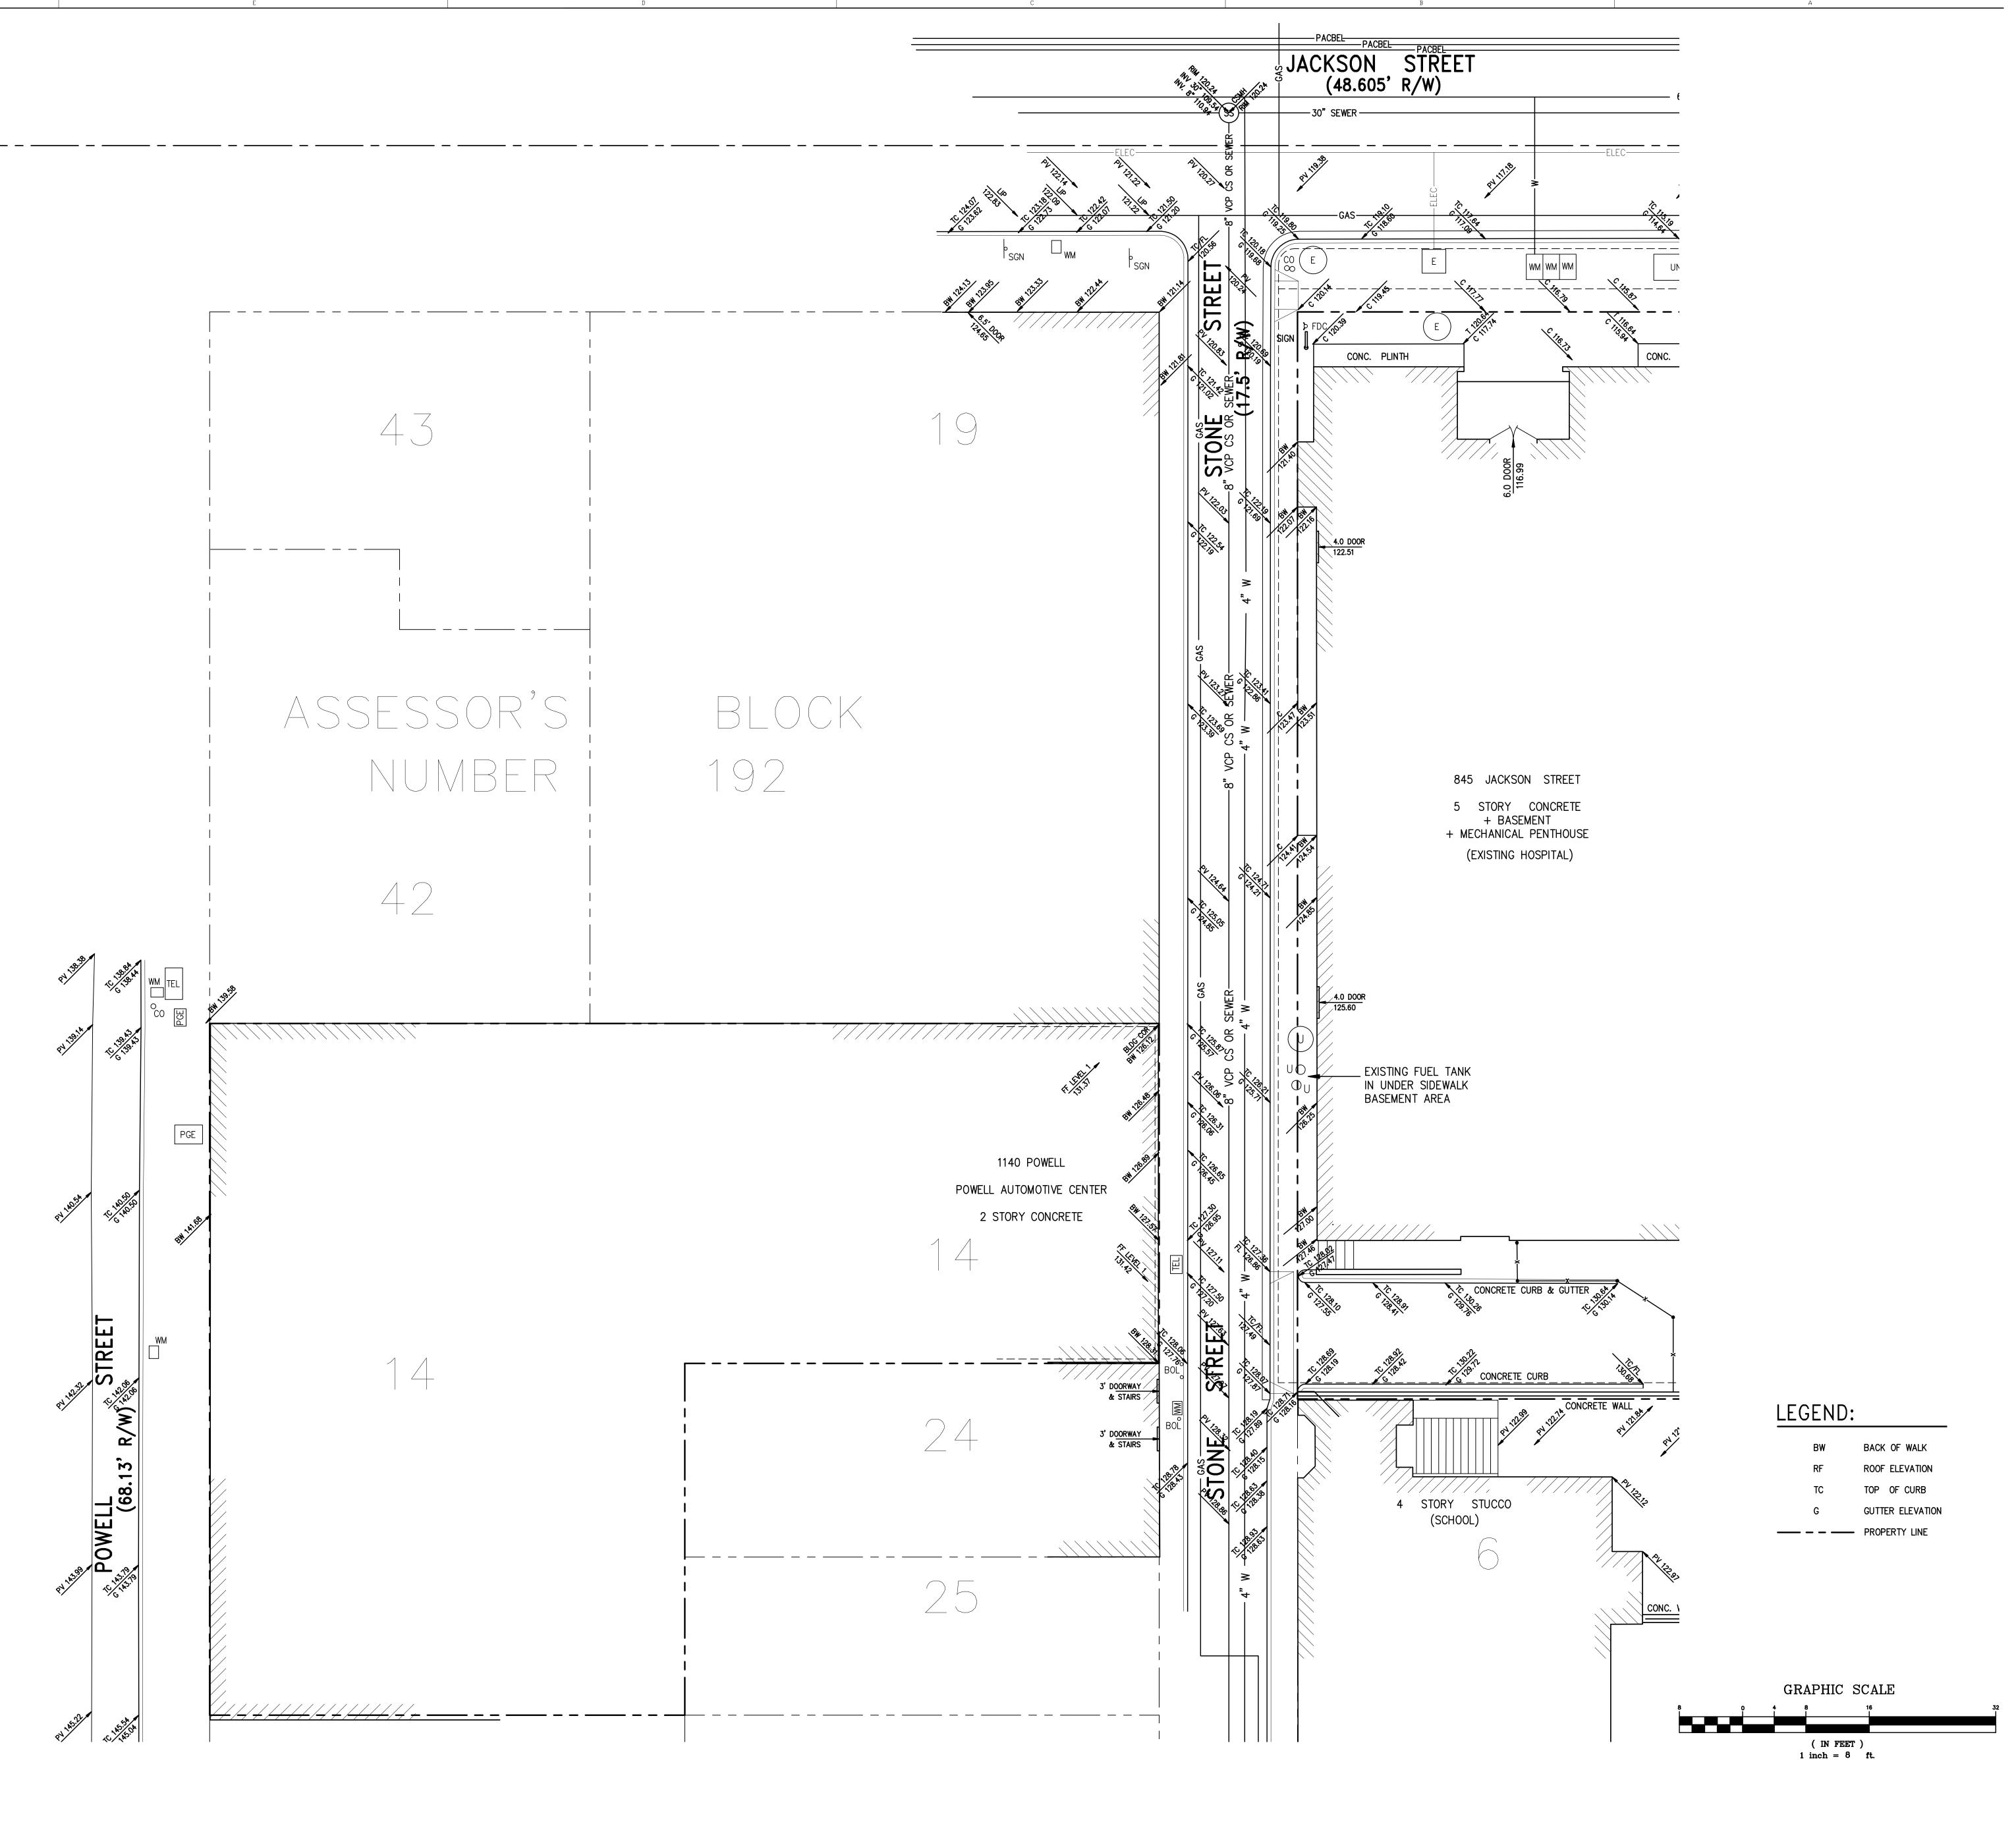
Drawing Title **EXISTING HOSPITAL BASEMENT**

ELEVATIONS

Project Number

Drawing Number

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TREADWELL & ROLLO



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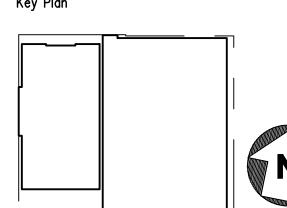
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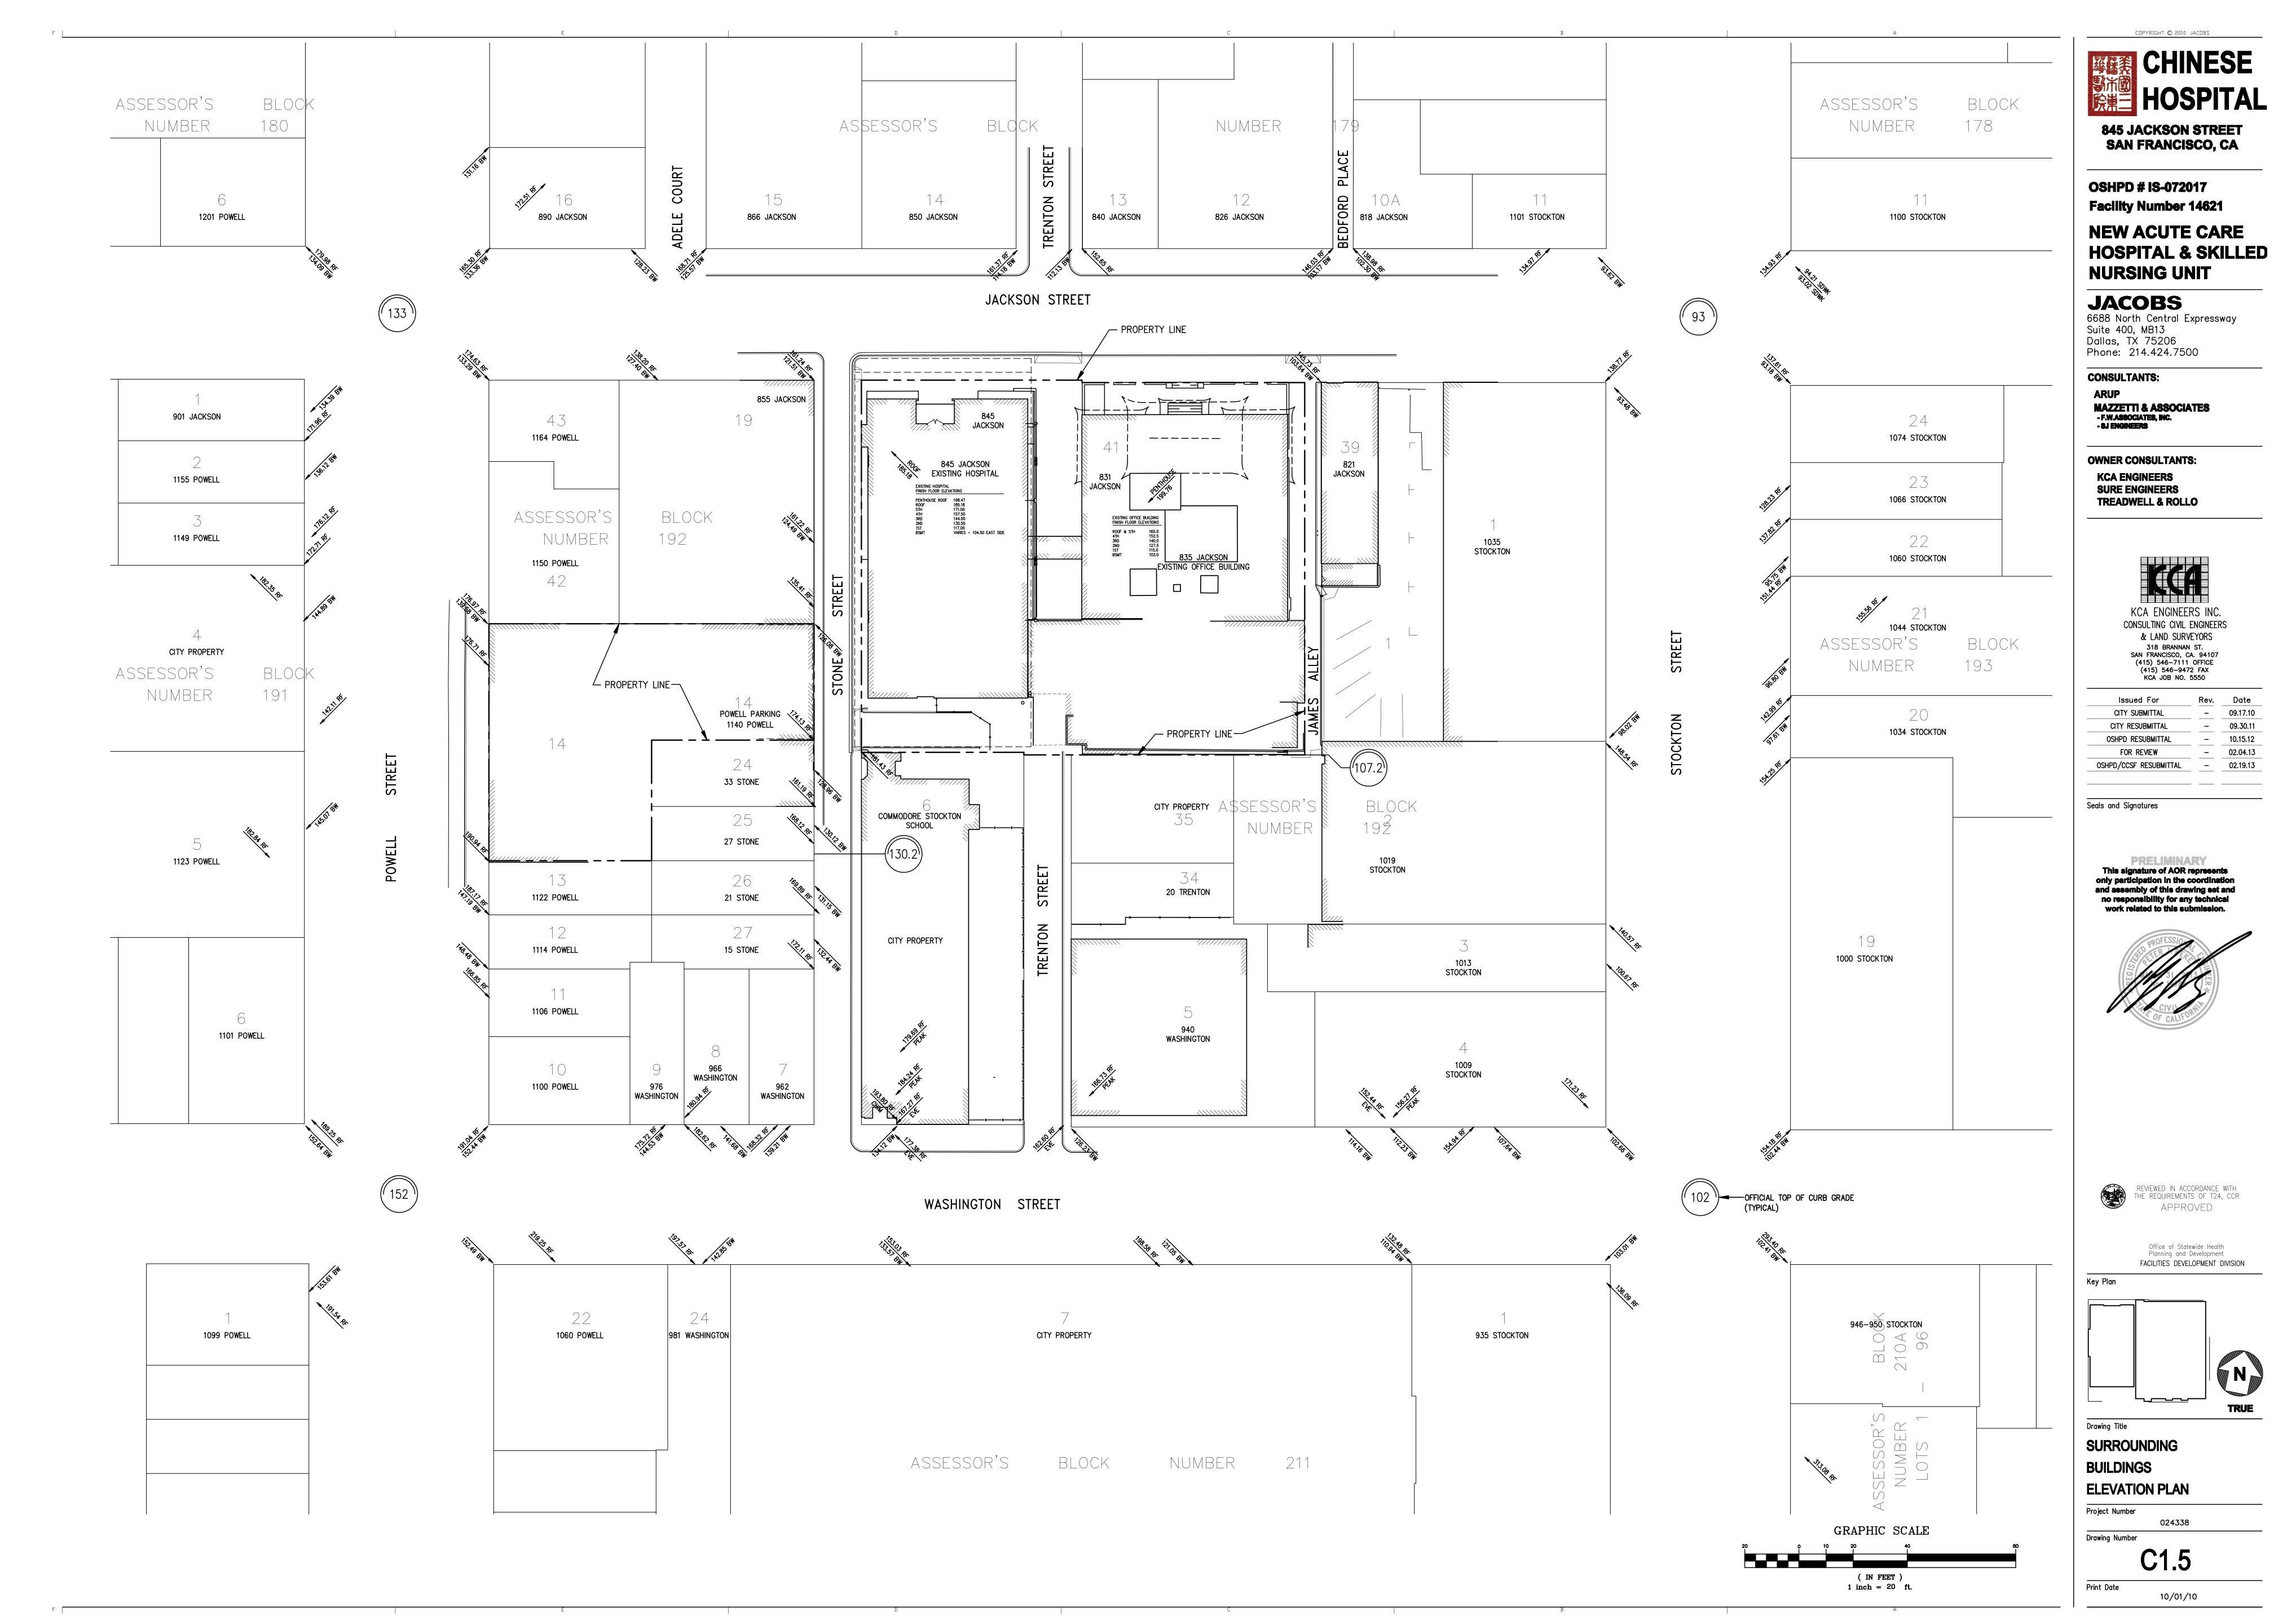
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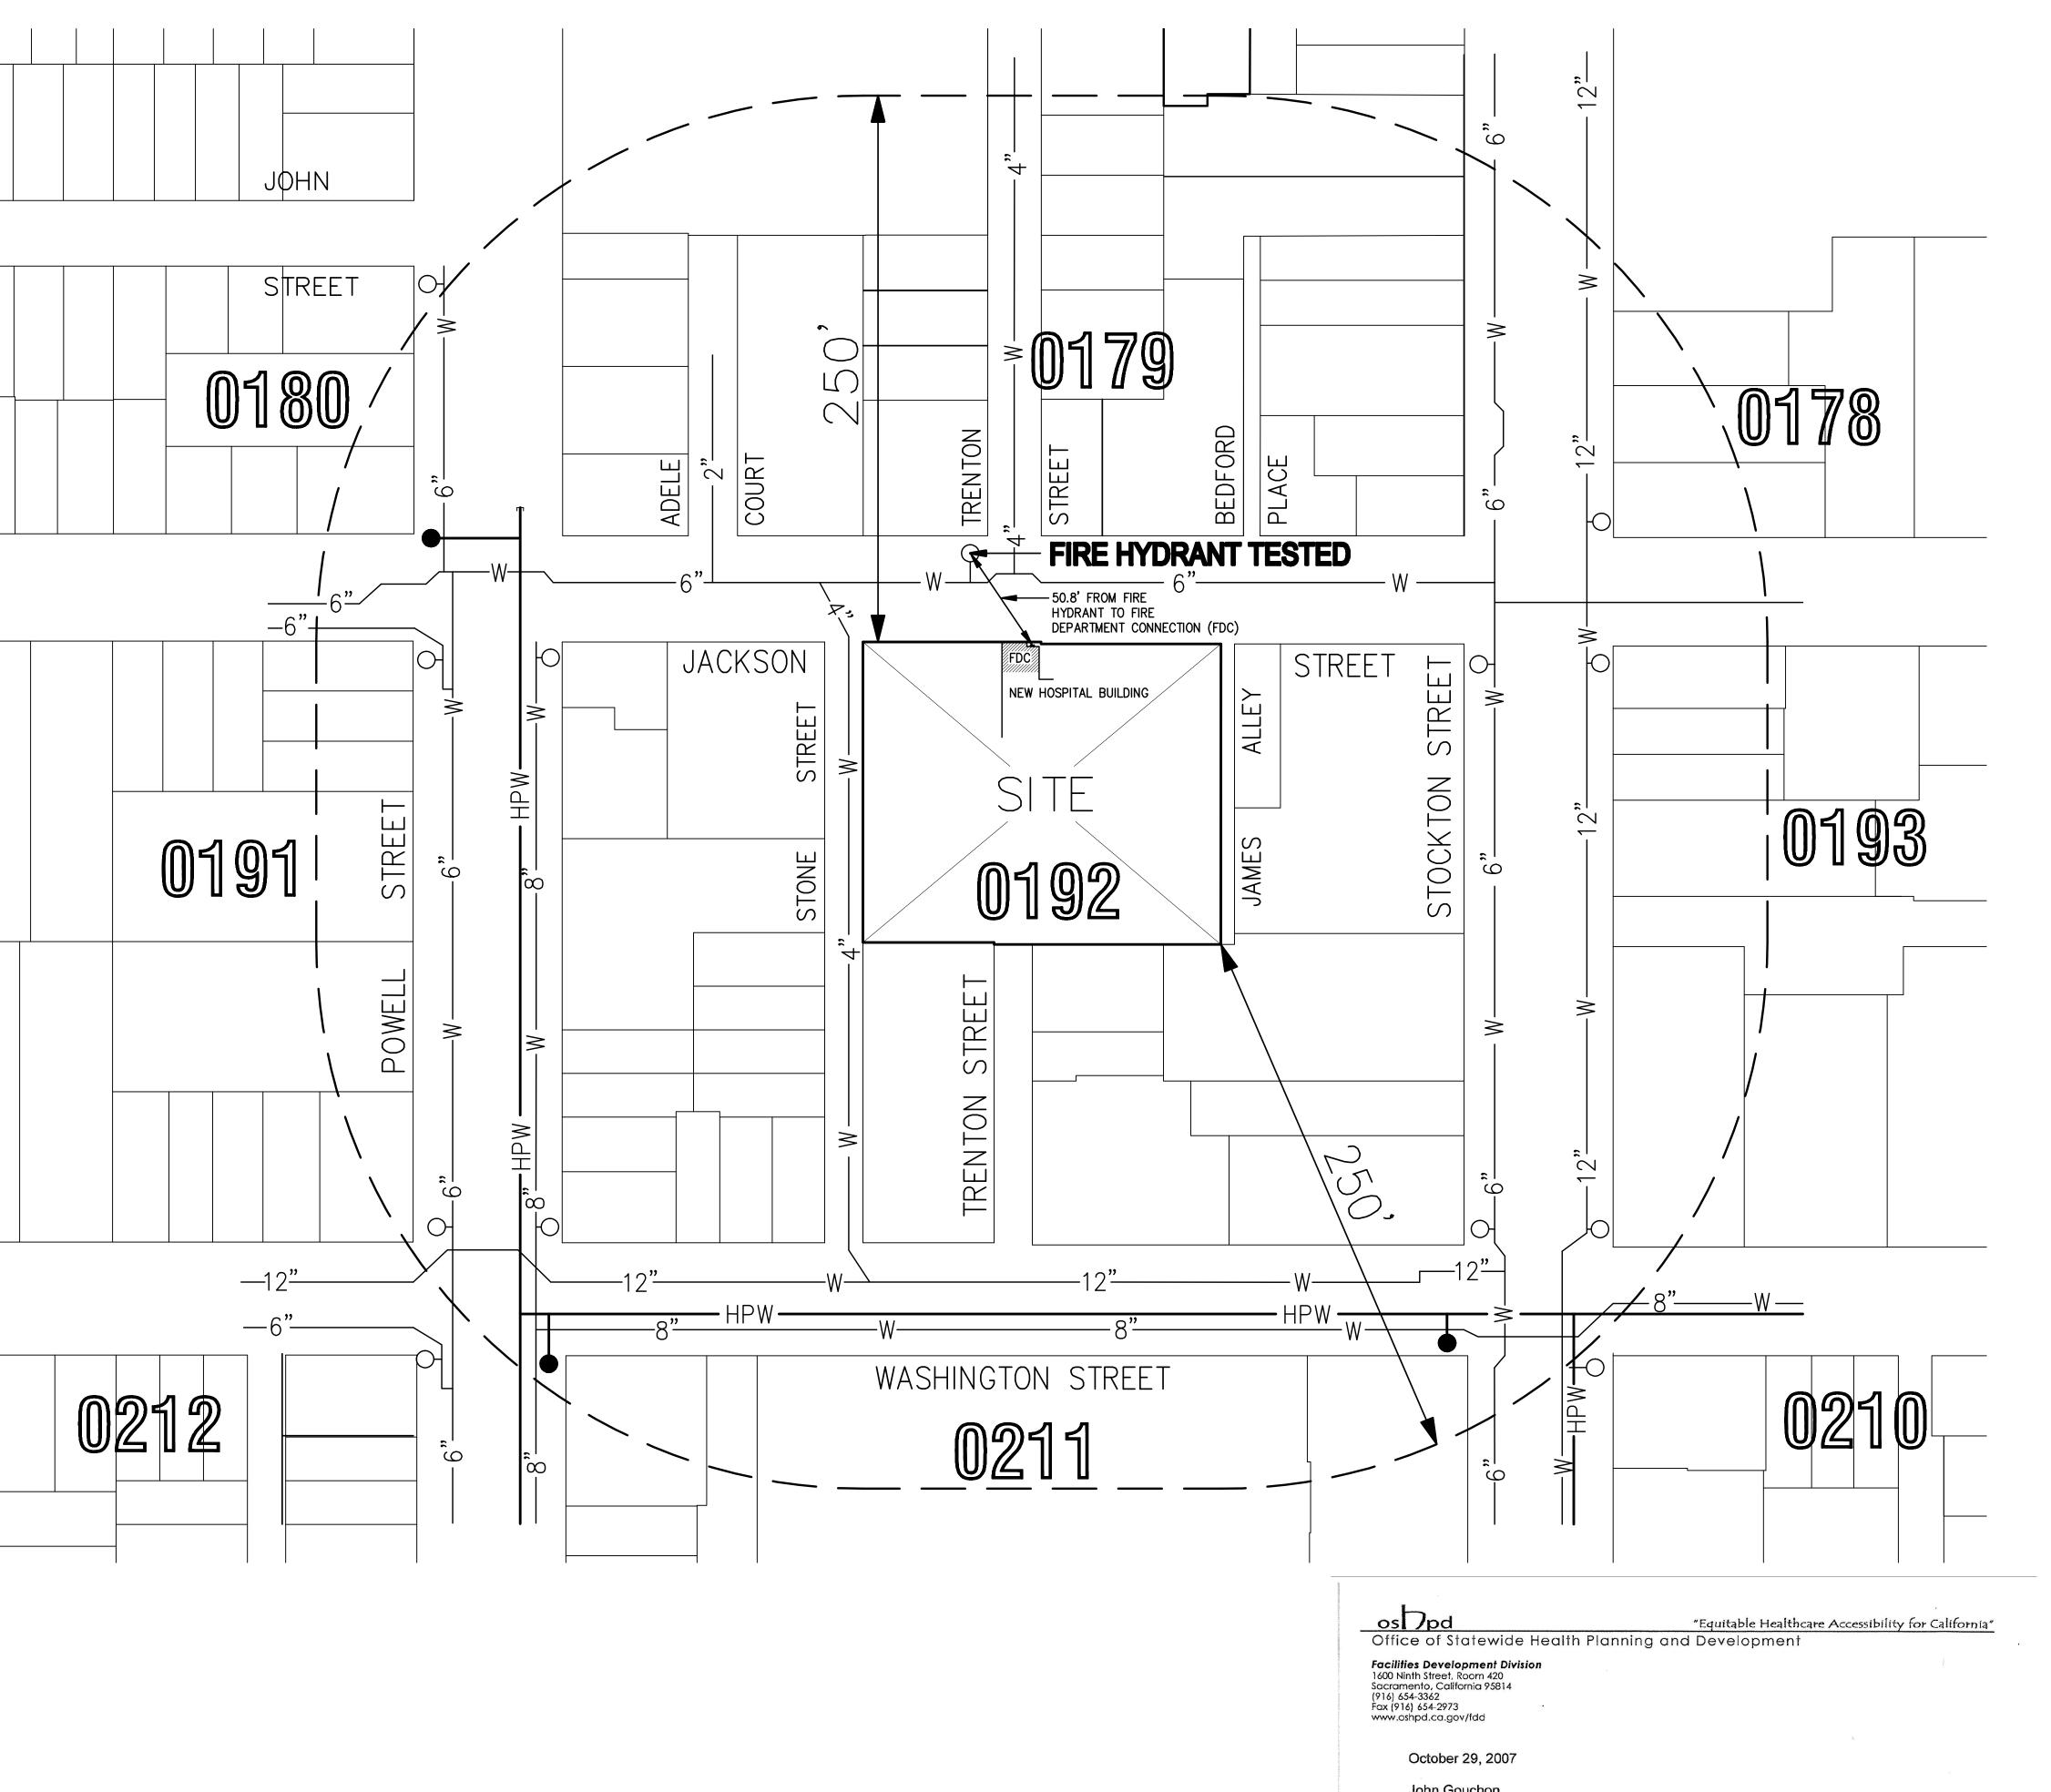
TOPOGRAPHIC **SURVEY**


POWELL GARAGE

Project Number Drawing Number

Print Date





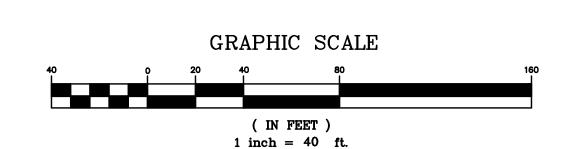


LEGEND


ASSESSOR'S BLOCK NUMBER

LOW PRESSURE HYDRANT

HIGH PRESSURE HYDRANT

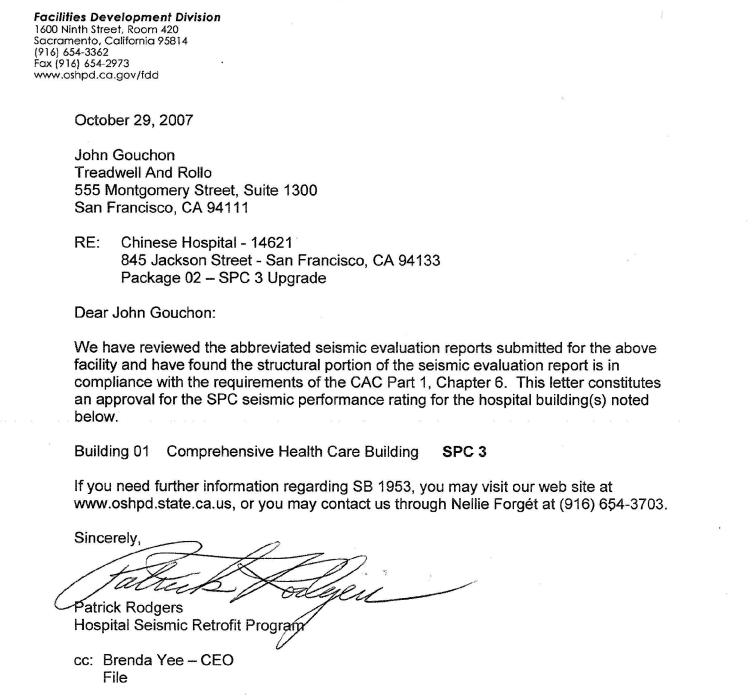

State of California – Health and Human Services Agency

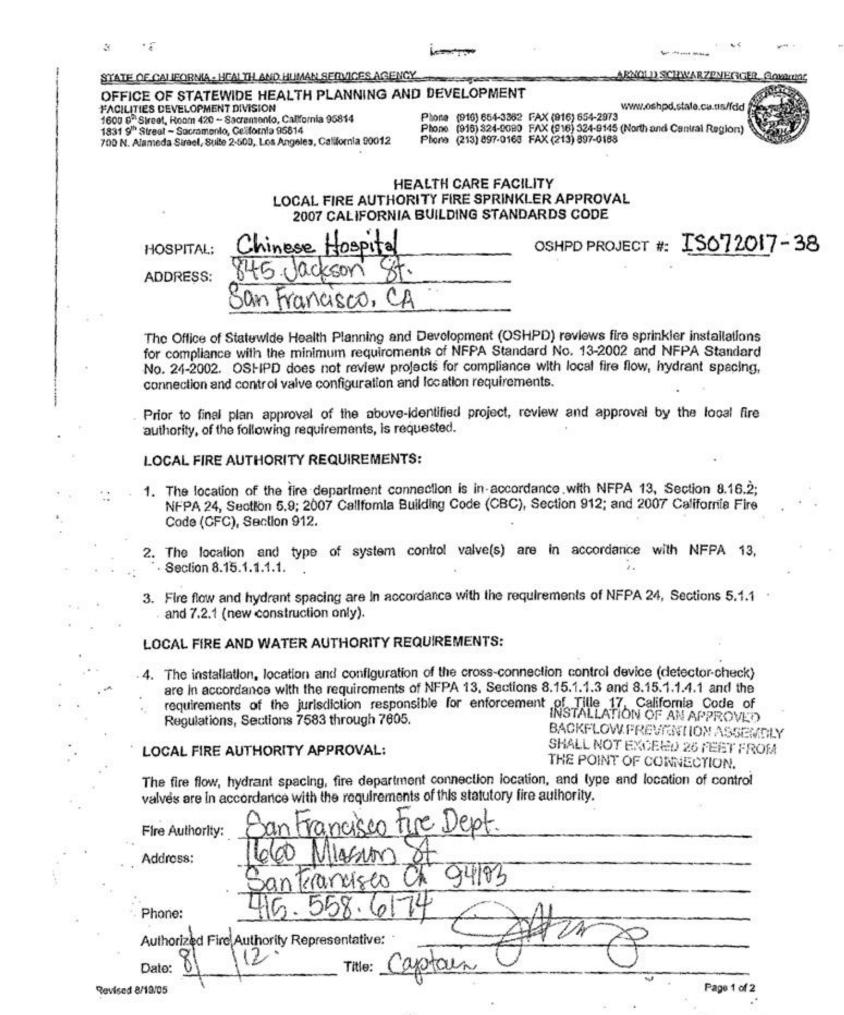

LOCAL FIRE AUTHORITY APPROVAL



SAN FRANCISCO FIRE DEPARTMENT BUREAU OF FIRE PREVENTION/PLAN CHECK DIVISION 1660 Mission Street

San Francisco, CA 94103 Contact: Inspector Lerma (415) 558-6077 Fax (415) 558-6560

REQUEST FOR WATER FLOW INFORMATION

3,25,08 REQUESTED BY: KCA Engineers ADDRESS: 318 Brannan St., SE CONTACT PERSON: Kem Litle EMAIL: Kenlitle @ Kegengineers - Com FAX NO. (415) 5461 9472 PHONE NO. (415) 546/7111 OWNER'S NAME PHONE # Wayne Hu 415-986-1372 ADDRESS FOR WATER FLOW INFORMATION: PROVIDE SKETCH HERE 835 Jackson St. CROSS STREETS (BOTH ARE REQUIRED):

Powell St. 1 Stockton St. SPECIFY STREET FOR POINT OF CONNECTION: Jackson St.

.P:\MS Word Forms\WFREQ.doc

OCCUPANCY (CIRCLE ONE): R3 R1 LIVE/WORK COMMERCIAL OTHER HOSPITAL HAZARD CLASSIFICATION: LIGHT ORD 1 ORD 2 EXT 1 EXT 2 OTHER NUMBER OF STORIES: 6 HEIGHT OF BLDG.: 72 FT. SUBMIT FORM WITH A \$45.00 CHECK MADE TO 'S.F.F.D.' REQUESTS REQUIRING A FIELD FLOW TEST WILL BE NOTIFIED BY FAX

AND WILL REQUIRE AN ADDITIONAL \$180.00 FEE. WATER FLOW INFORMATION WILL BE RETURNED VIA FAX OR MAIL.

 INCOMPLETE FORMS WILL NOT BE PROCESSED. ALLOW 7-14 WORKING DAYS FOR PROCESSING.

FLOW DATA PROVIDED BY: B. Ballar V DATE FORWARDED: 4/1/08 STATIC 58 PSI
RESIDUAL 52 PSI FLOW DATA: FIELD FLOW TEST RECORDS ANALYSIS FLOW <u>1000</u> GPM on fackson GATE PAGE:

PRESSURE TEST RESULTS



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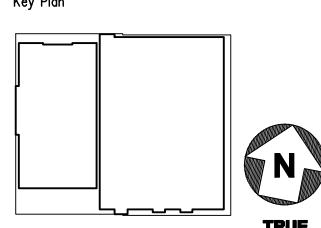
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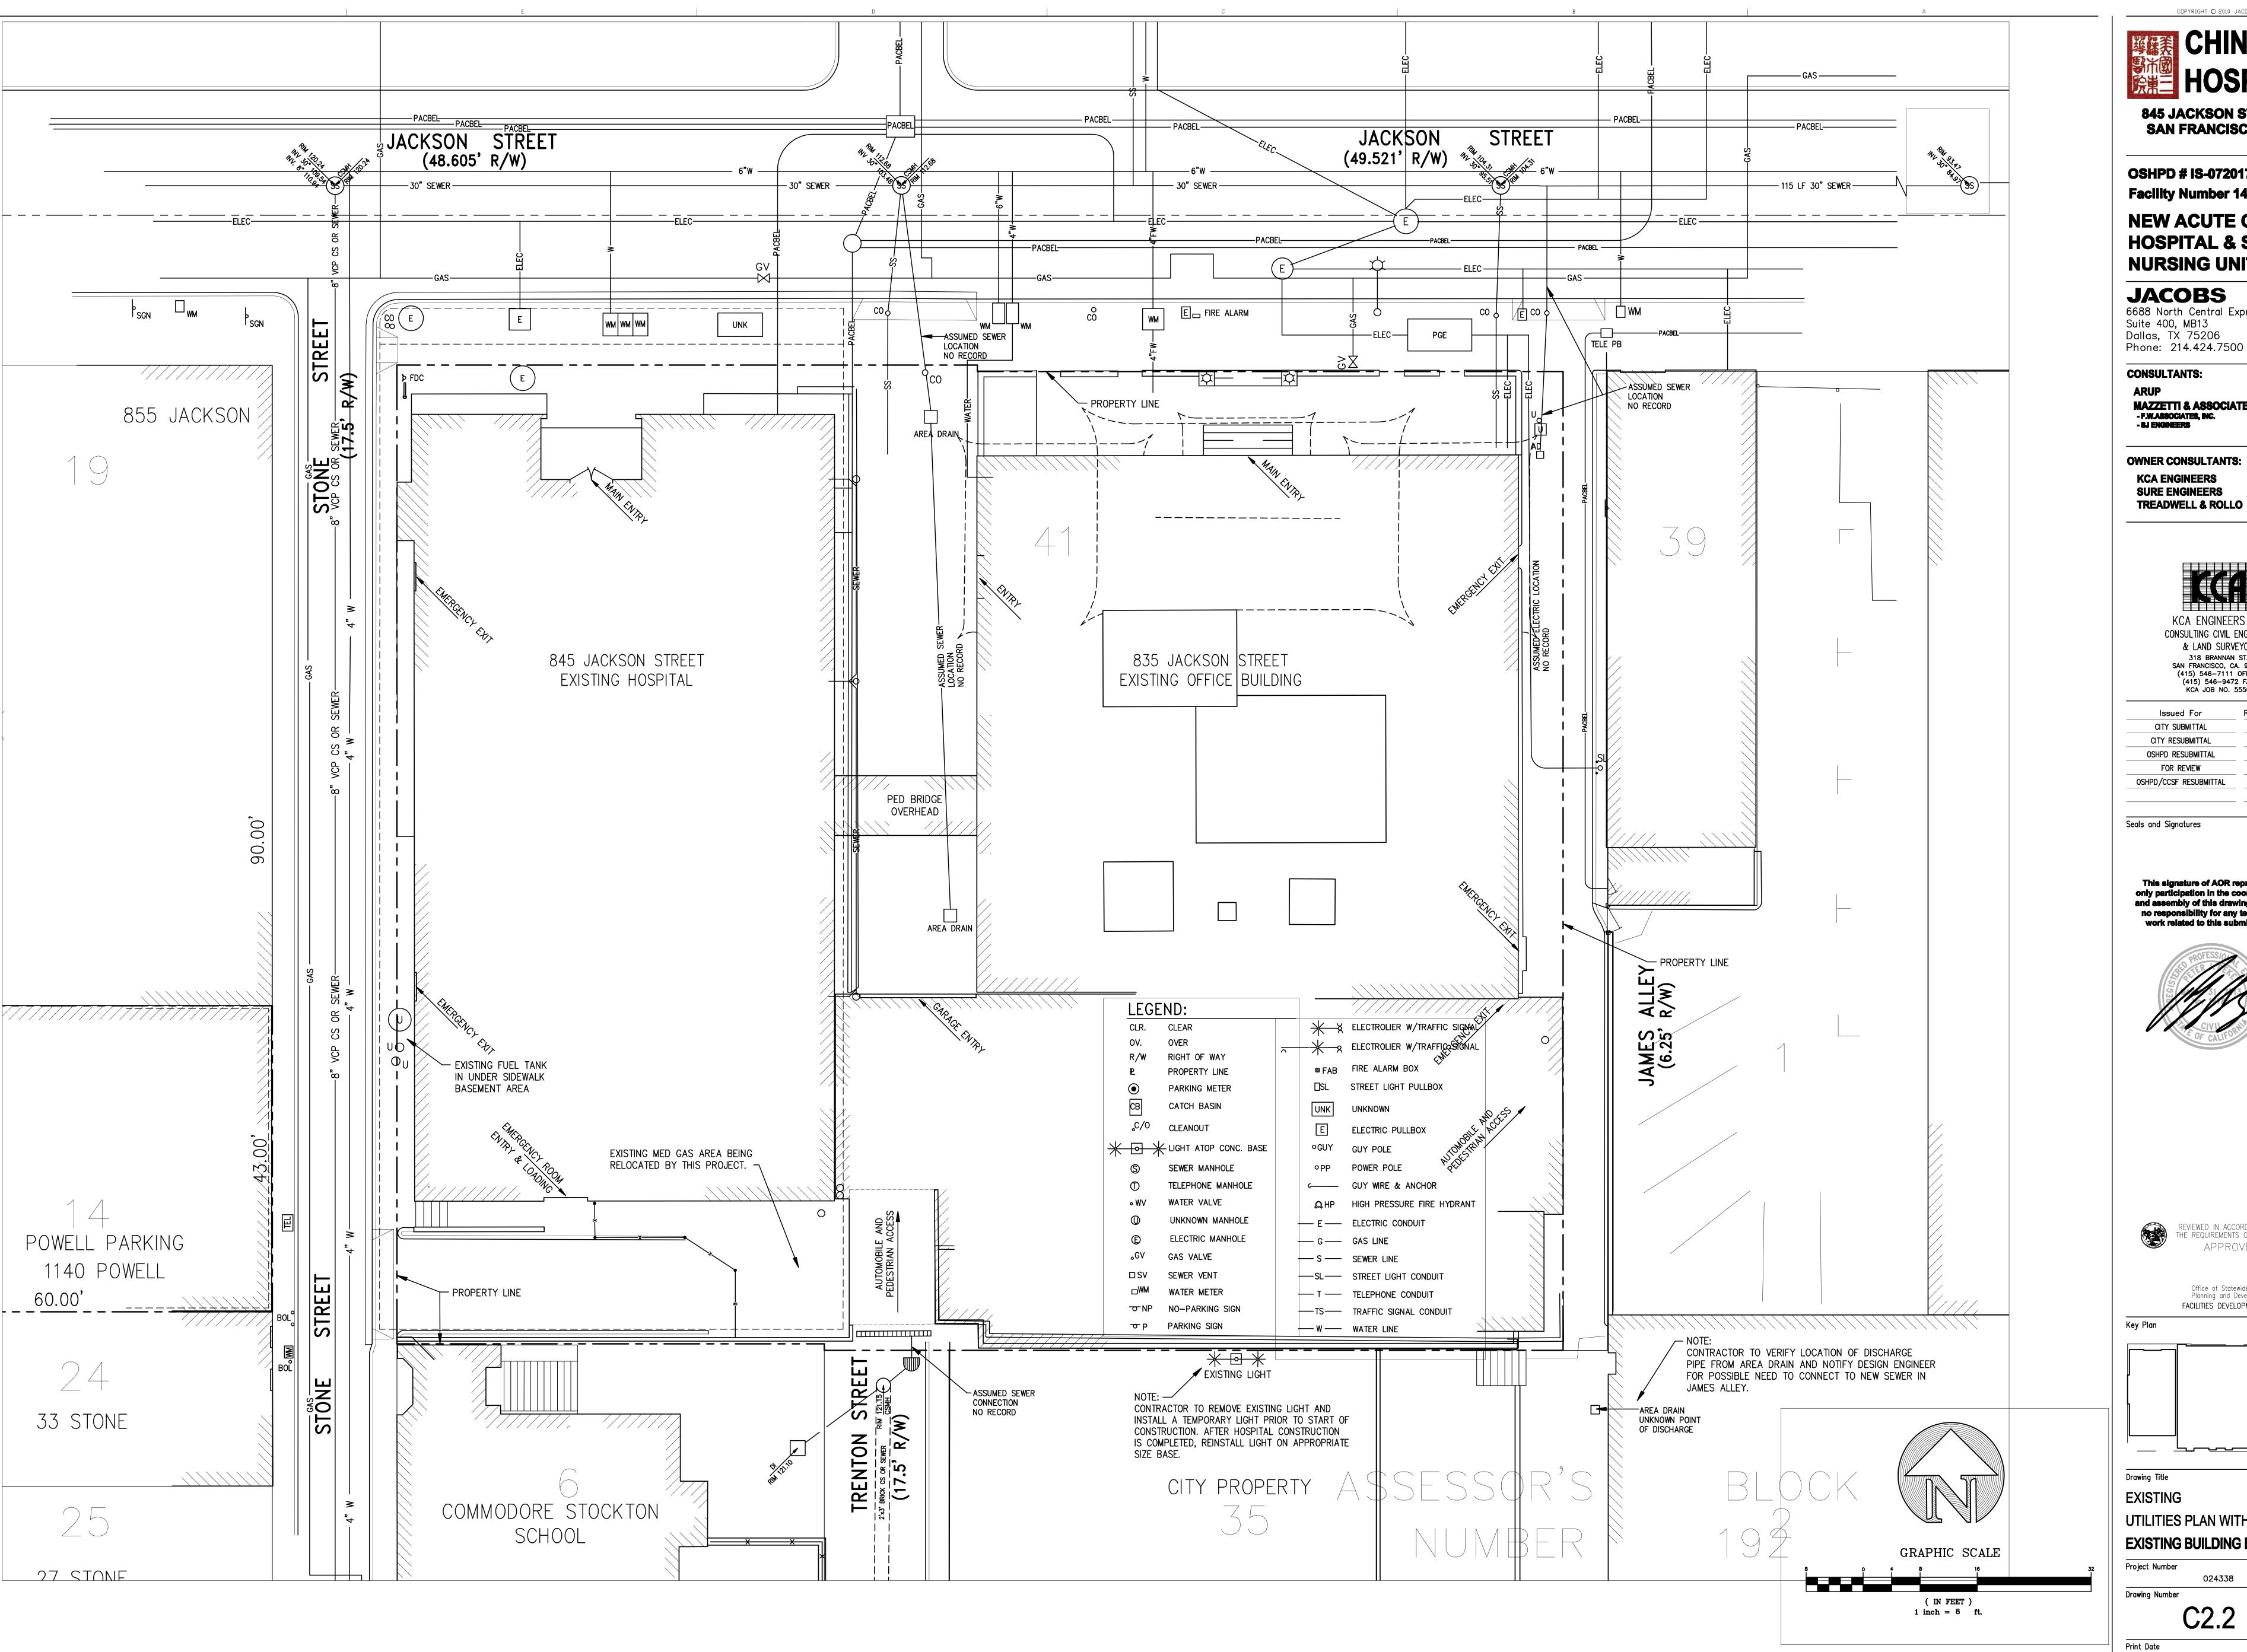
FACILITIES DEVELOPMENT DIVISION



Drawing Title **EXISTING WATER LINES AND FIRE**

HYDRANTS

Project Number



CHINESE

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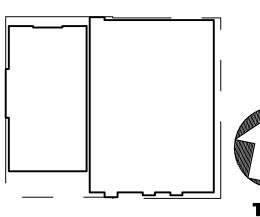
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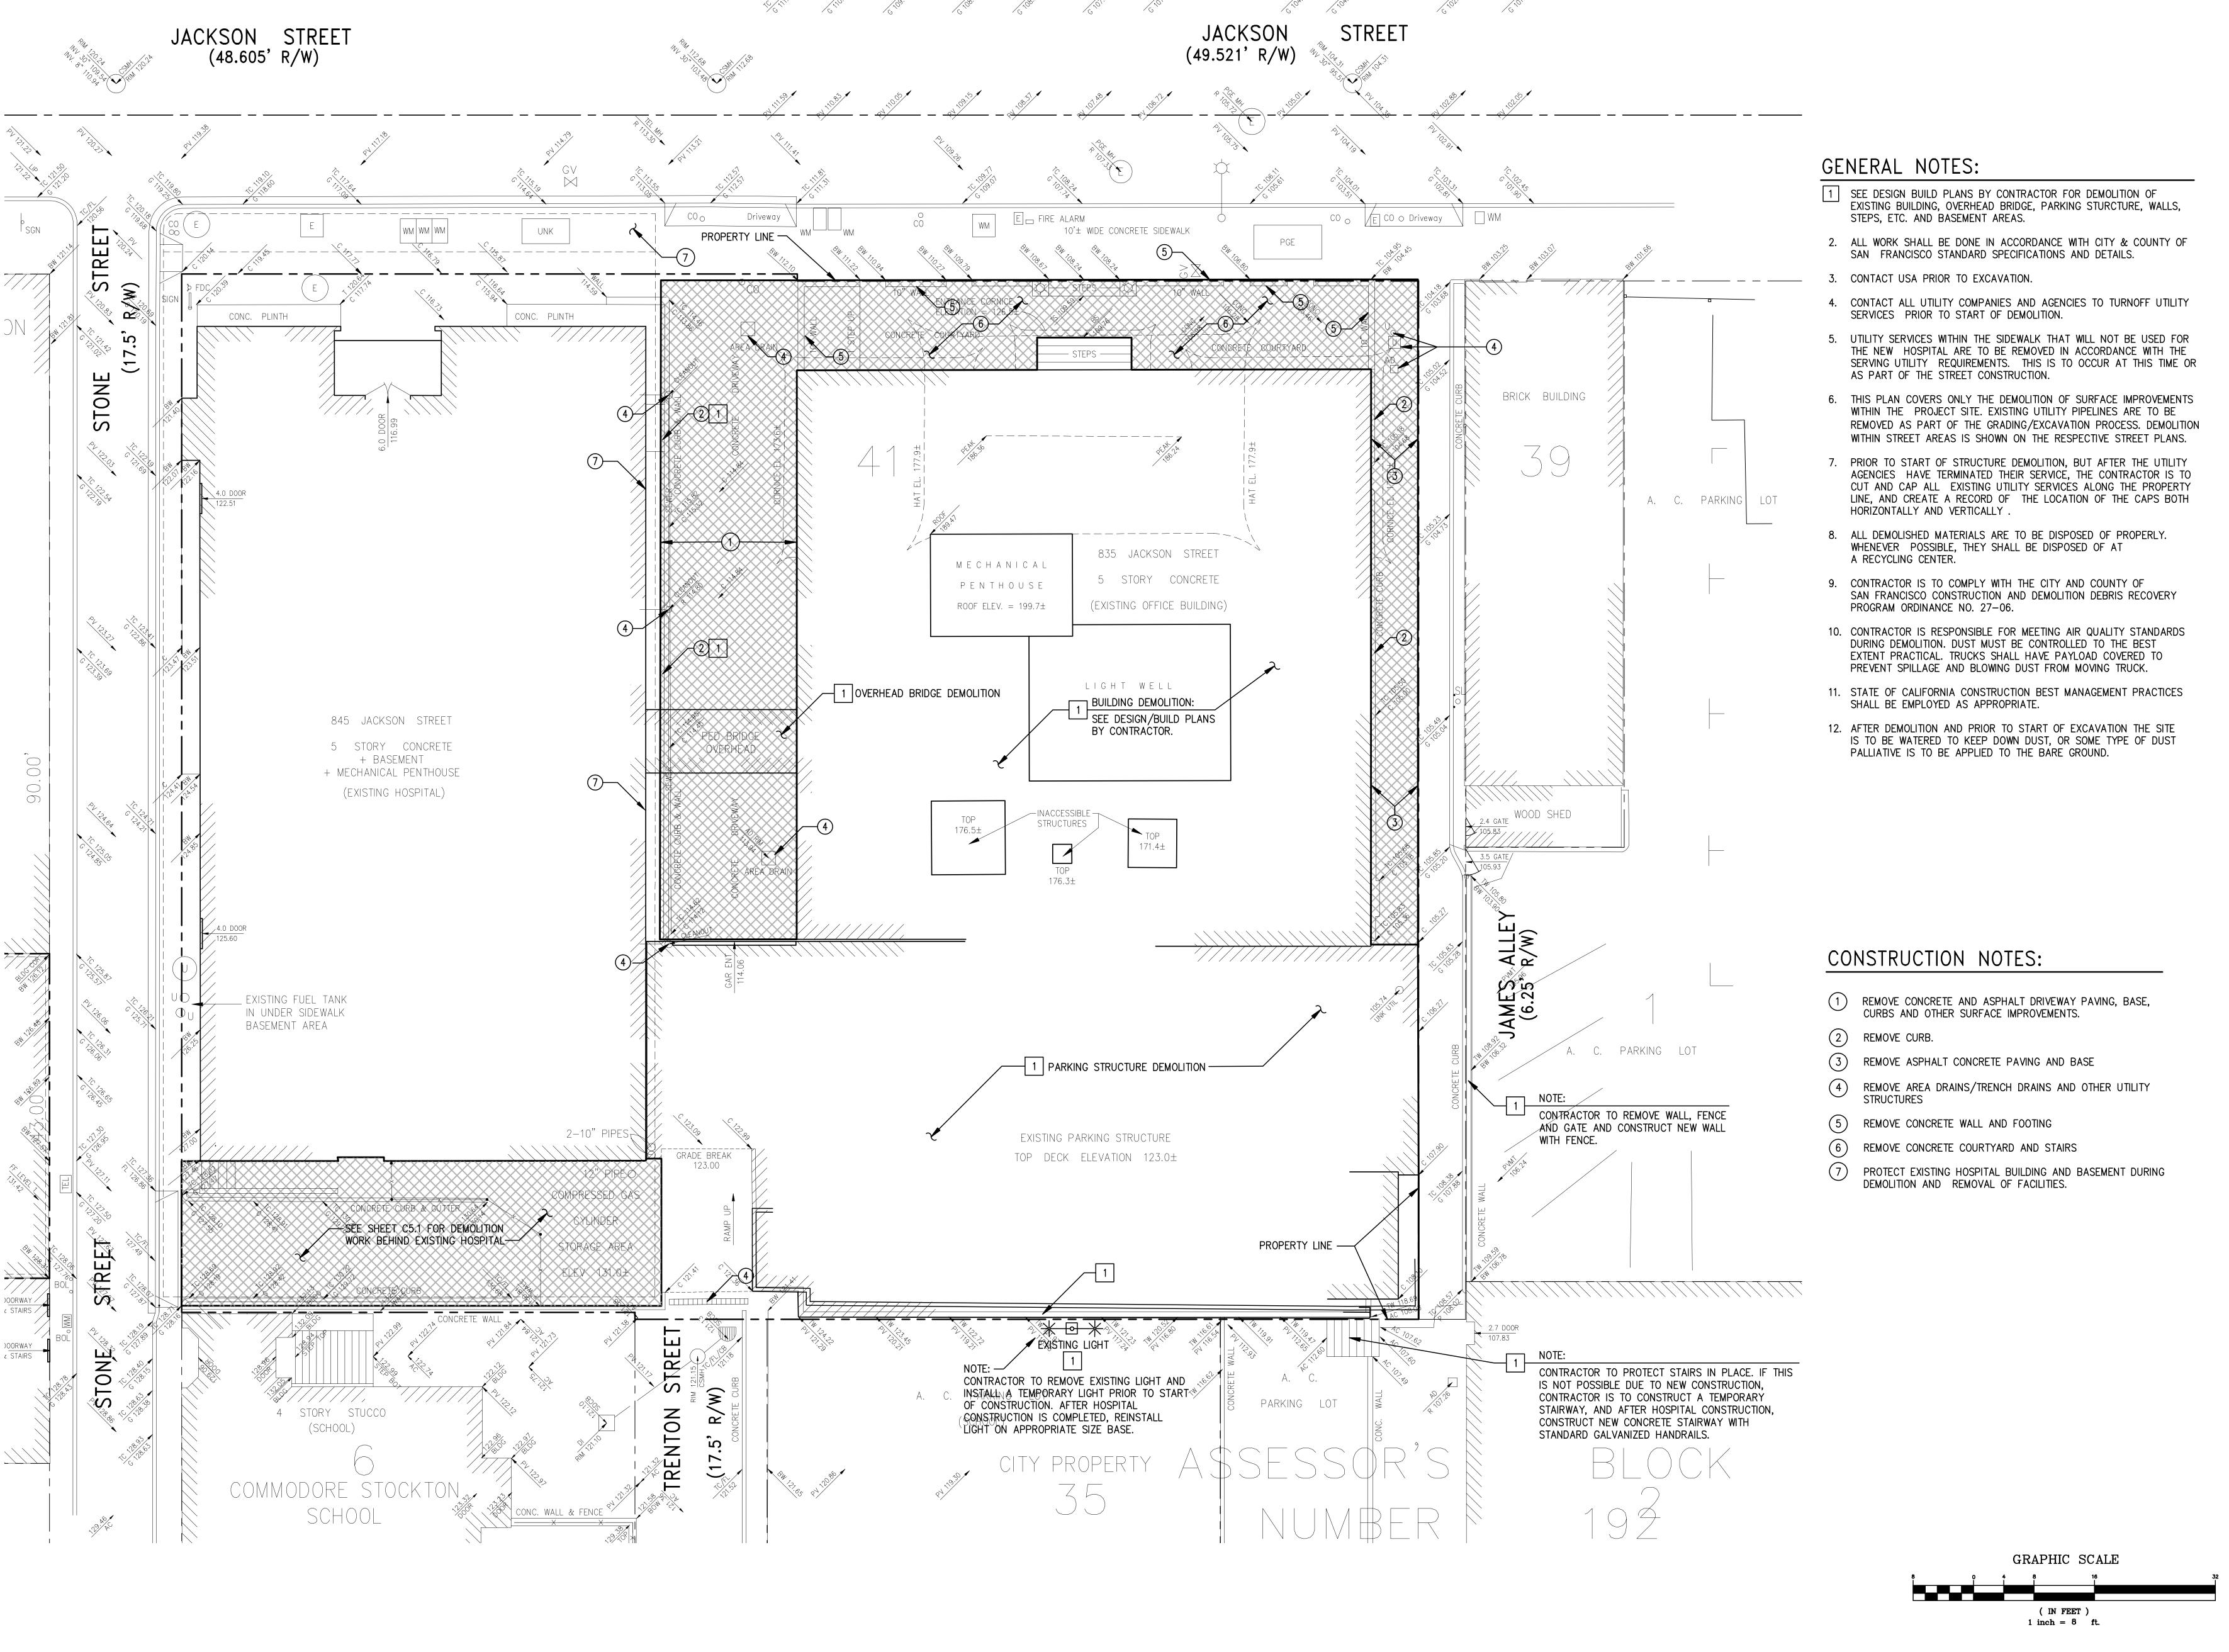
FACILITIES DEVELOPMENT DIVISION



Drawing Title **EXISTING UTILITIES PLAN WITH**

EXISTING BUILDING ENTRANCES

Project Number 024338 Drawing Number



WESSE CHINESE HOSPITAL

845 JACKSON STREET SAN FRANCISCO, CA

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HOSPITAL & SKILLED

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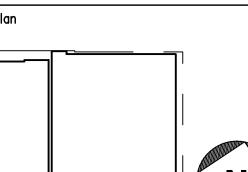
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Office of Statewide Health Planning and Development FACILITIES DEVELOPMENT DIVISION



Drawing Title

ON-SITE SURFACE


ON-SITE SURFACE
DEMOLITION
PLAN

Project Number


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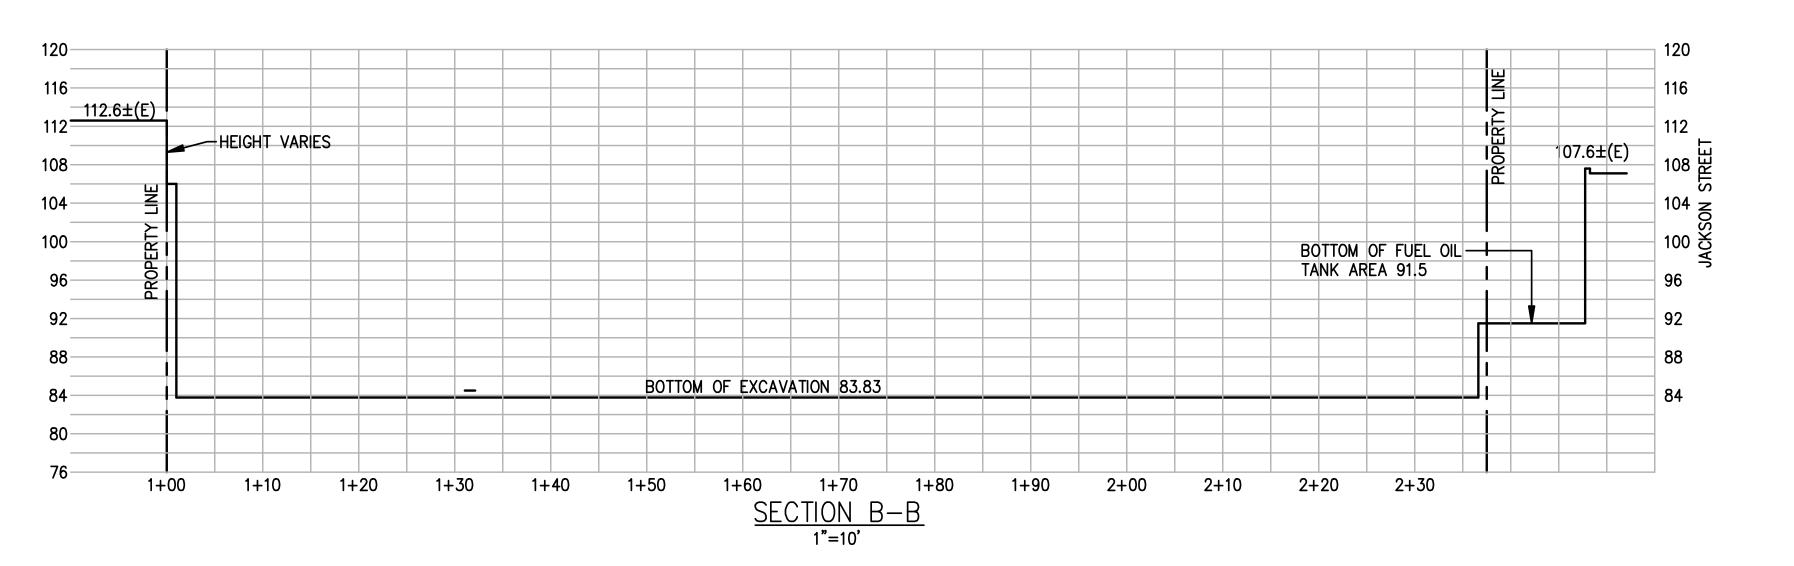
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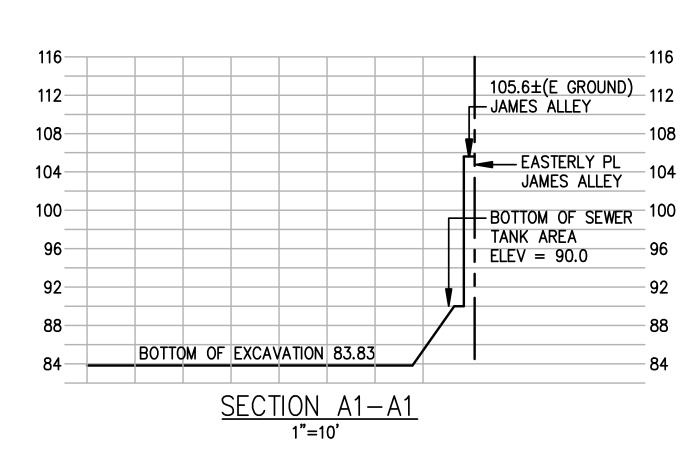
C3.1



FACE OF EXISTING HOSPITAL BASEMENT WALL

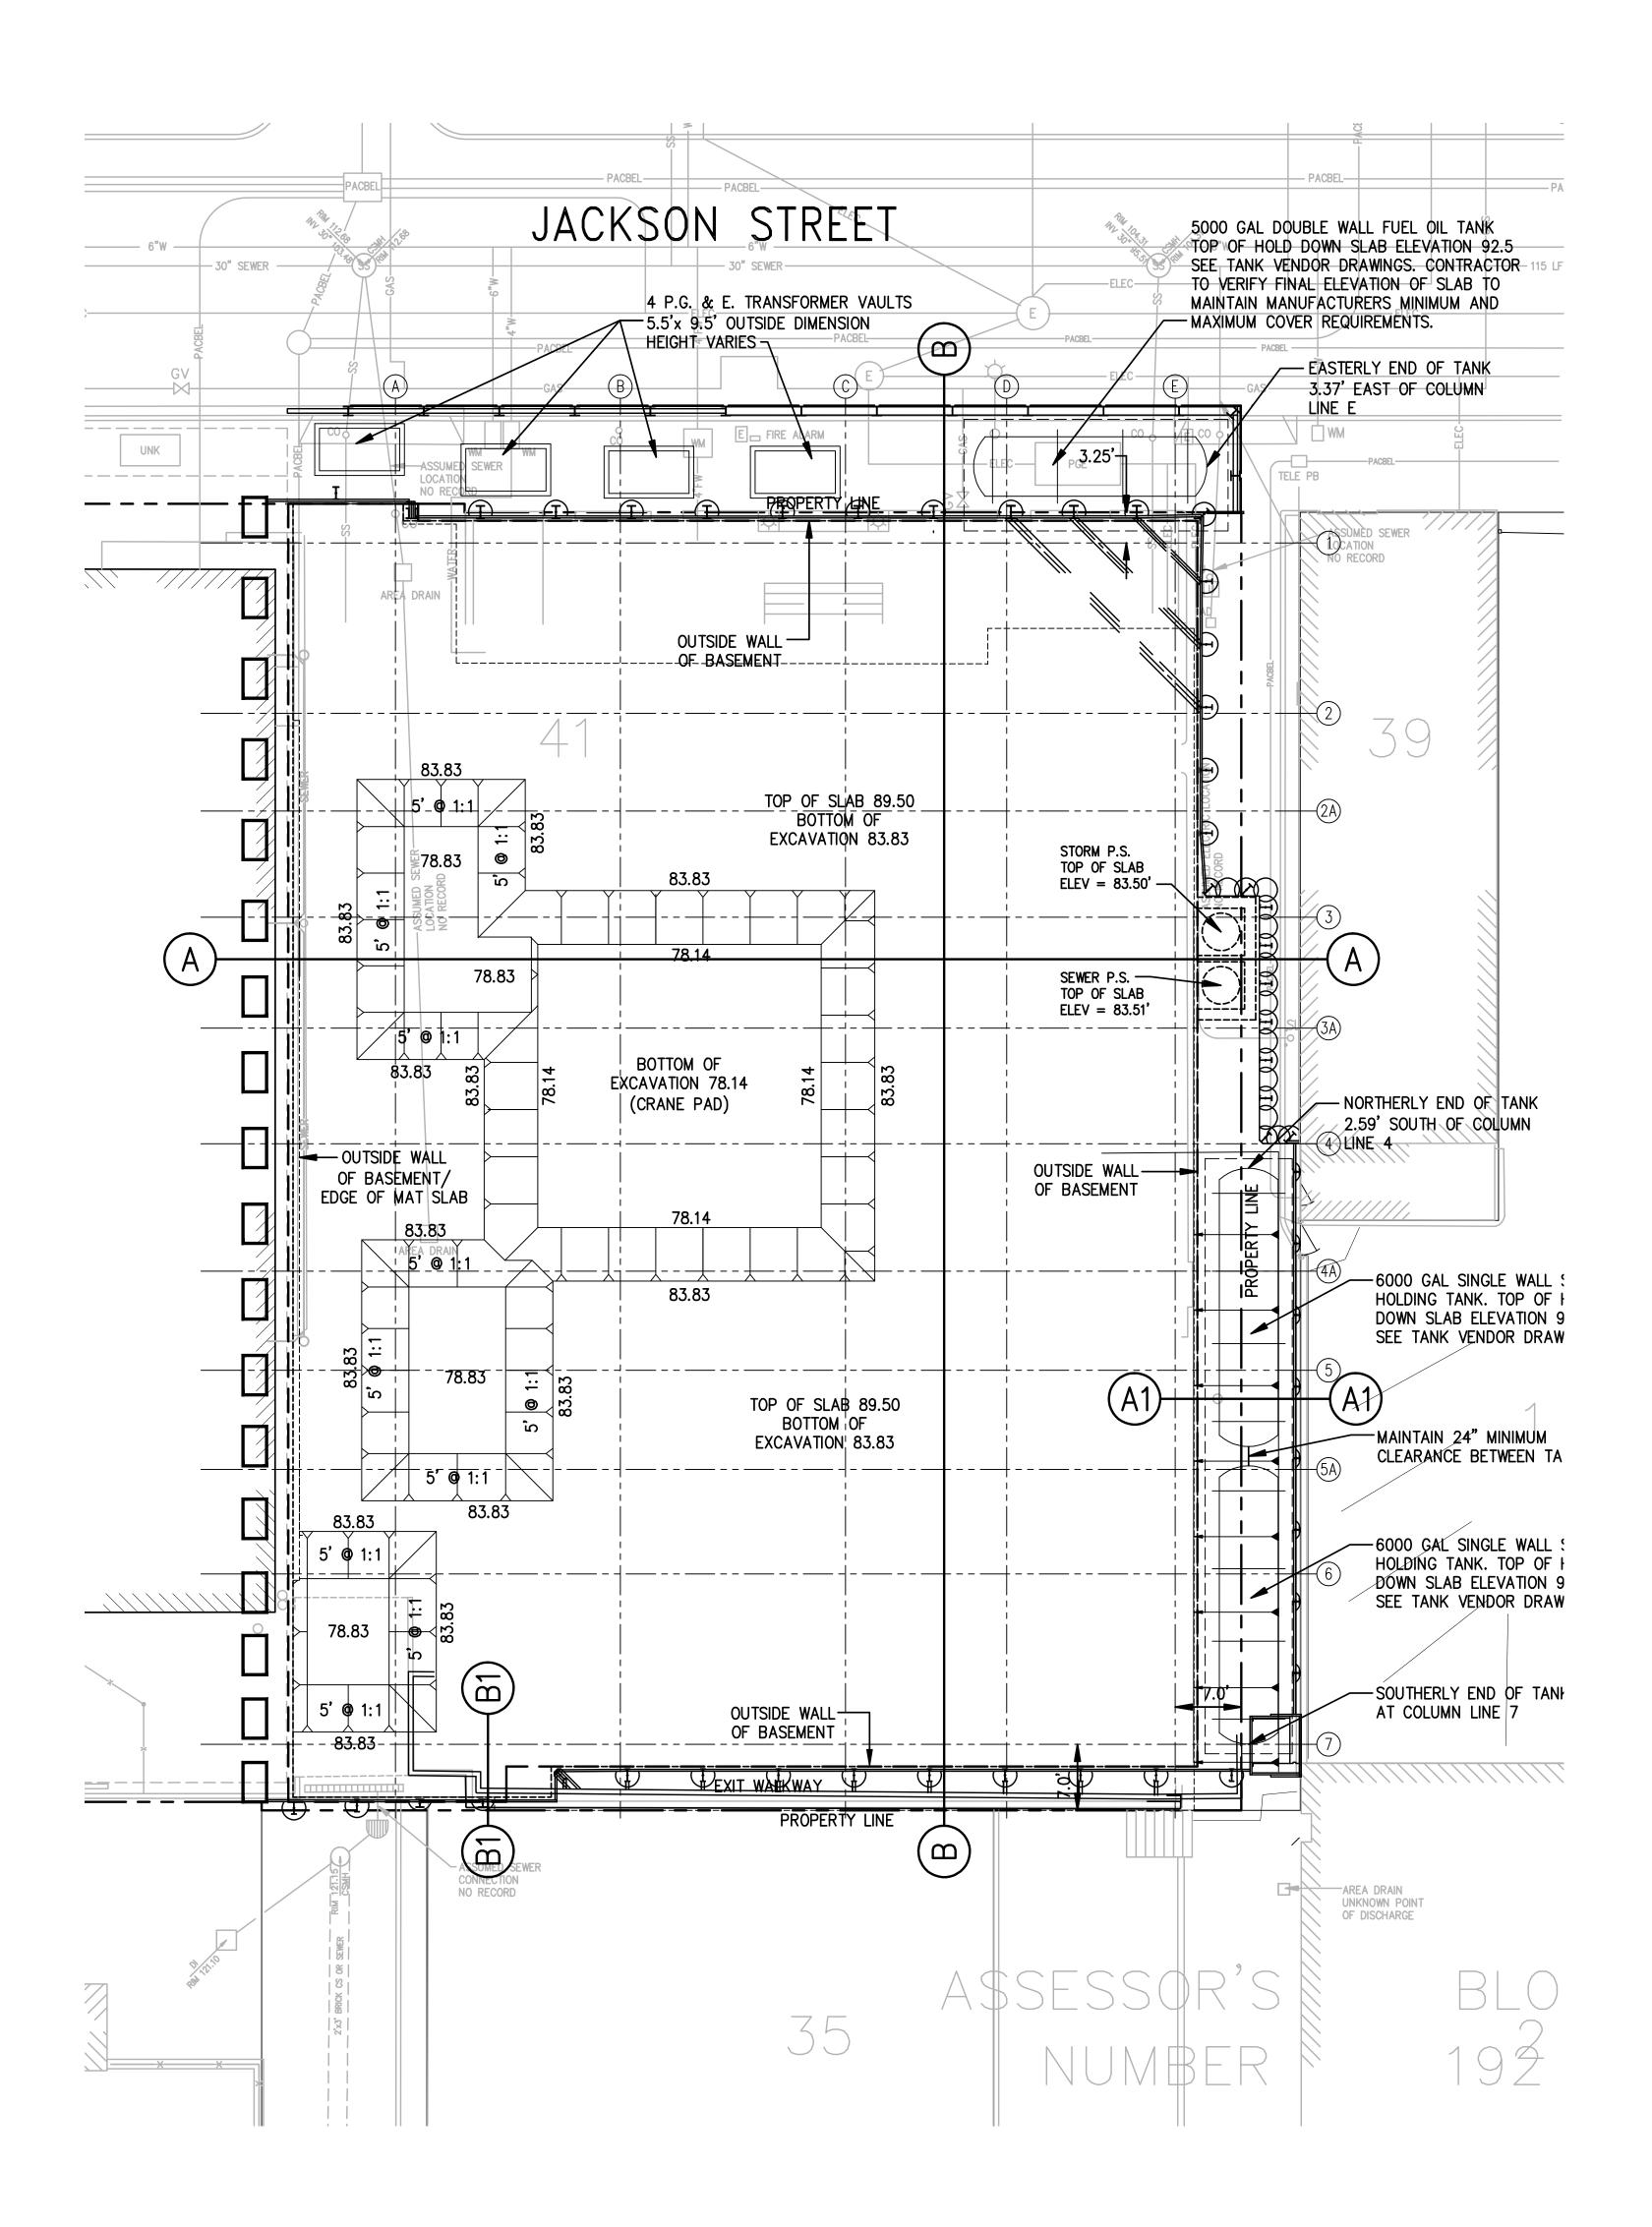



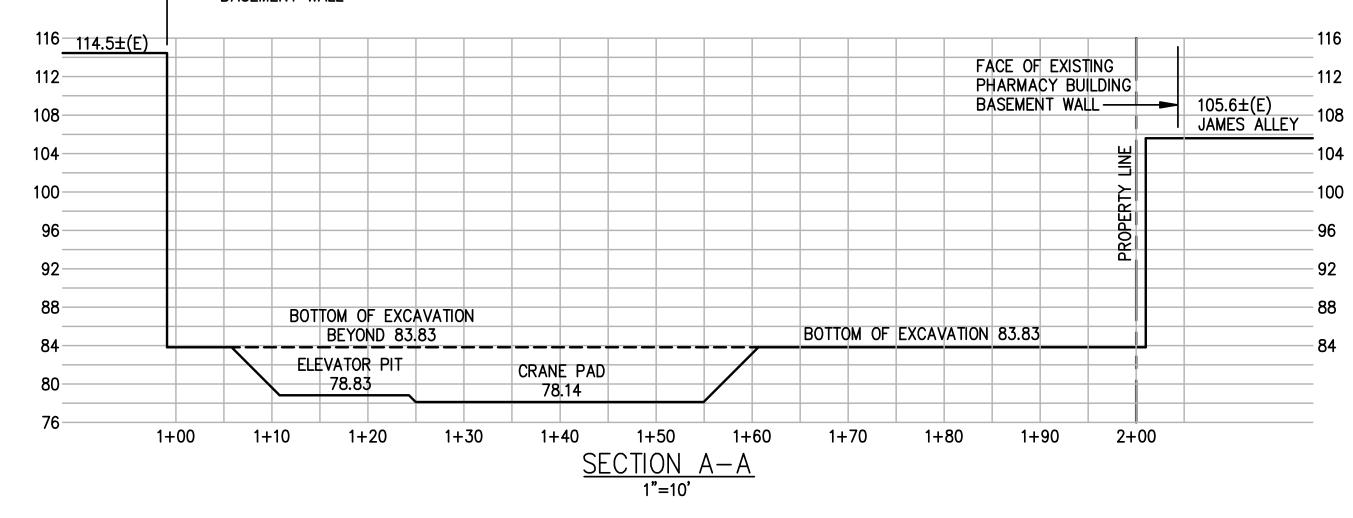

GENERAL NOTES:


- 1. CONSTRUCTION TO BE UNDERTAKEN IN ACCORDANCE WITH THE CITY AND COUNTY OF SAN FRANCISCO STANDARD PLANS AND SPECIFICATIONS. IF NECESSARY, CONTRACTOR IS RESPONSIBLE FOR OBTAINING A PROJECT SITE COPY OF STANDARD PLANS AND SPECIFICATIONS, WHICH ARE AVAILABLE AT THE CONTRACTS AND ADMINISTRATION DEPARTMENT, DEPARTMENT OF PUBLIC WORKS, 875 STEVENSON STREET, ROOM 420, SAN FRANCISCO (TEL: 415-554-6229).
- CONTRACTOR SHALL CONSULT WITH PROJECT GEOTECHNICAL ENGINEER AND BE FAMILIAR WITH THE GEOTECHNICAL REPORT AND UPDATED REPORT REGARDING SITE EXCAVATION AND SOIL CONDITIONS, PREPARED BY TREDWELL AND ROLLO, DATED MARCH 7, 2007 AND OCTOBER 25, 2007 RESPECTIVELY WHICH ARE AVAILABLE FROM THE ARCHITECT.
- THIS EXCAVATION PLAN WAS BASED ON BASEMENT AND FOUNDATION FRAMING PLANS PREPARED BY ANOTHER CONSULTANT AND RECEIVED BY KCA ENGINEERS ON JUNE 30, 2008. CONTRACTOR SHALL USE MOST UP TO DATE STRUCTURAL PLANS AND PROJECT ZERO DATUM, BOTH OF WHICH MAY CHANGE, AT THE TIME OF ACTUAL EXCAVATION.
- 4. SHORING OR UNDERPINNING IS PROPOSED AROUND THE ENTIRE SITE. SHORING IN AREAS WHERE THERE ARE NO ADJACENT BUILDINGS AND UNDERPINNING AT ADJACENT BUILDING. SEE SHORING DRAWINGS PREPARED BY SURE ENGINEERS. SHORING SHOWN ON THIS DRAWING IS SCHEMATIC ONLY.
- 5. CONTRACTOR TO COMPLY WITH THE CITY AND COUNTY OF SAN FRANCISCO CONSTRUCTION AND
- 6. SEE SHEET C1.1 FOR PUMP STATIONS AND SEWER HOLDING TANK.

DEMOLITION DEBRIS RECOVERY PROGRAM ORDINANCE NO. 27-06.

- 7. SEE STRUCTURAL PLANS FOR LOCATION AND ELEVATION OF ELEVATOR PITS AND OTHER AREAS THAT ARE LOWER THAN THE BOTTOM OF THE MAT SLAB.
- 8. BASEMENT PAVING SECTION (68") CONSISTS OF THE FOLLOWING, WHICH IS TO BE VERIFIED BY CONTRACTOR PRIOR TO START OF EXCAVATION:

6" FINISH SLAB 18" CLASS 2 AGGREGATE BASE 36" MAT SLAB 4" PROTECTION SLAB 1" WATERPROOFING MEMBRANE 3" RAT SLAB

- 9. TRANSFORMER VAULTS HAVE A VARYING HEIGHT WITH 6" OF COMPACTED 3/4" MINUS ROCK BASE. VERIFY WITH P.G. & E. PRIOR TO ORDERING OR INSTALLING. DUE TO THE SLOPE OF THE STREET, THE BOXES MAY REQUIRE SPECIAL CONSTRUCTION. ELEVATIONS SHOWN ARE FINISH FLOOR ELEVATIONS.
- 10. SHORING SHOWN ON THIS PLAN IS FOR GENERAL INFORMATION ONLY. SEE SHORING PLANS FOR FINAL LOCATIONS. CONTRACTOR TO COORDINATE THE SHORING PILE LOCATION TO ALLOW FOR PLACEMENT OF TANK HOLD DOWN STRAPS. HOLD DOWN STRAP INFORMATION IS SHOWN ON INCREMENT 5 DRAWINGS.
- 11. SEE INCREMENT 5 PLANS FOR PLUMBING AND ELECTRICAL INFORMATION INCLUDING AS A MINIMUM: SEWER HOLDING TANKS AND APPURTENANCES. FUEL STORAGE TANKS AND APPURTENANCES. SEWER LINES AND STORM DRAIN LINES AND APPUTENANCES NOT IN THE PUBLIC STREET. GAS LINE FROM STREET TO THE GAS METER ROOM.
 - TRANSFORMER VAULTS AND APPURTENANCES. ELECTRICAL, CABLE, COMMUNICATIONS CONDUIT AND APPUTENANCES.
- 11. ONSITE GRADING QUANTITY: CUT - ±9,500 CUBIC YARDS FILL - 0 CUBIC YARDS

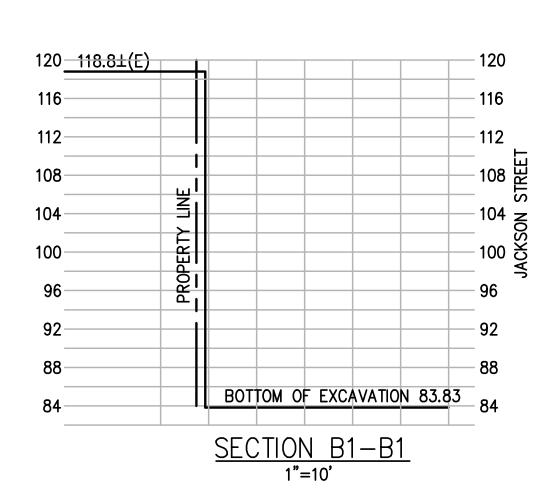


PROPOSED BUILDING ELEVATIONS:

BASEMENT

LEVEL	CITY DATUM	ARCHITECT DATUM
PENTHOUSE	216.0	111.50
ROOF	201.0	96.50
SIXTH FLOOR	186.0	81.50
FIFTH FLOOR	171.0	66.50
FOURTH FLOOR	157.5	53.00
THIRD FLOOR	144.0	39.50
SECOND FLOOR	130.5	26.00
FIRST FLOOR	117.0	12.50
GROUND FLOOR	104.5	0.00

NOTE: CONTRACTOR TO VERIFY THE EXISTING FLOOR ELEVATION OF THE 1979 BUILDING AT EACH LEVEL WHEN FORMING FOR EACH NEW BUILDING FLOOR, TO ASSURE THAT ACCESS BETWEEN BUILDINGS IS AT A CONFORMED GRADE.

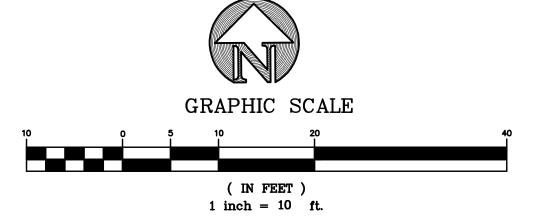

CHINESE

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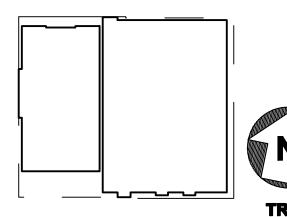
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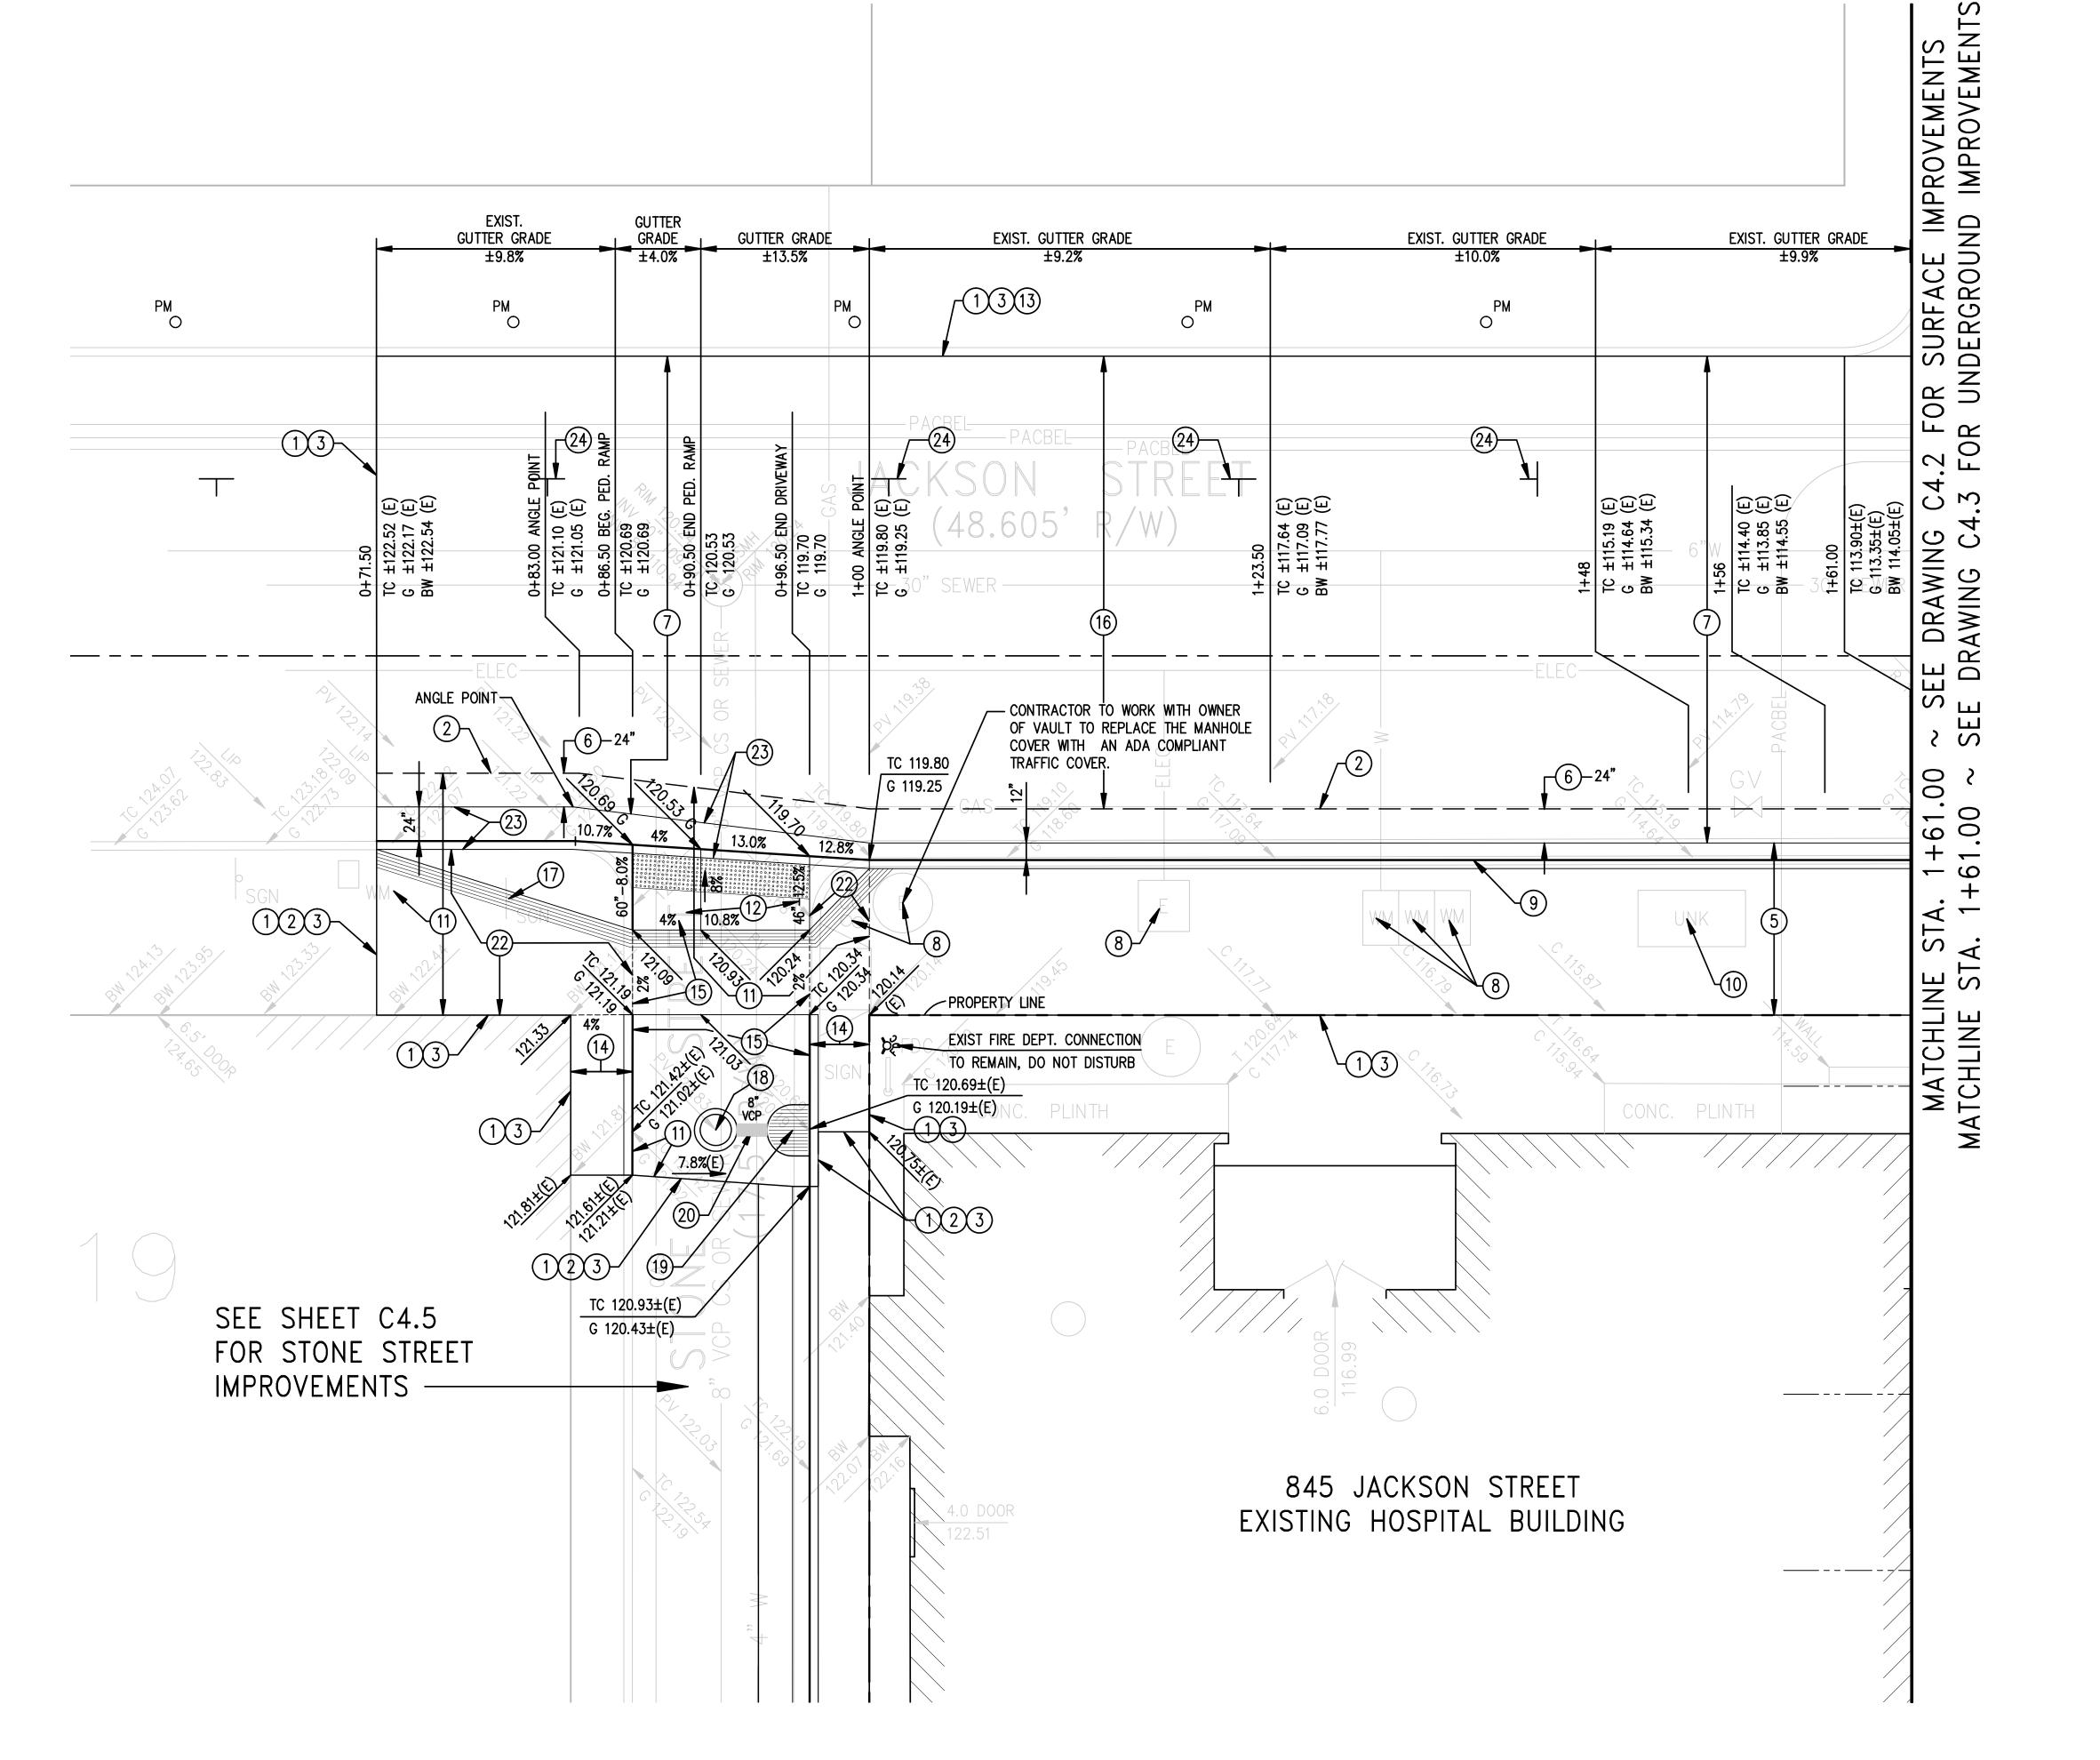


Drawing Title

HOSPITAL **EXCAVATION**

PLAN Project Number

Print Date




(845 JACKSON STREET AND STONE STREET INTERSECTION)

- 1) LIMIT OF WORK.
- 2 SAWCUT LINE.
- 3 MATCH EXISTING.
- 4 NOT USED
- (5) REMOVE CURB, GUTTER AND SIDEWALK AND CONSTRUCT CONCRETE CURB WITH ± 12 " WIDE CONCRETE GUTTER AND ± 9 '-1" WIDE CONCRETE SIDEWALK. (OFFICIAL WIDTH IS 10')
- (6) REMOVE PAVING AND BASE AND CONSTRUCT 8" CONCRETE BASE.
- 7 PLACE 2" AC PAVING.
- 8 ADJUST TOPS OF BOXES, VAULTS, CLEANOUTS, VALVE COVERS, ETC. TO THE PLANE OF THE NEW PAVING SURFACE.
- (9) PAINT CURB WHITE WITH APPROPRIATE CITY OF SAN FRANCISCO STENCILS INDICATING THE AREA FROM STATION 1+00.00 TO 1+61.00 ON JACKSON STREET AS A PASSENGER LOADING ZONE.
- (10) METAL COVER THAT MAY BE ACCESS TO BASEMENT. RECONSTRUCT IN THE PLANE OF THE NEW PAVING. REPLACE IF DAMAGED OR WARPED.
- (11) REMOVE CURB, GUTTER, PAVING, BASE AND PEDESTRIAN RAMPS.
- (12) CONSTRUCT 10.5 FOOT WIDE COMBINATION AUTOMOBILE RAMP AND PEDESTRIAN CURB RAMP. 8" THICK CONCRETE OVER 8" CLASS 2 AGGREGATE BASE, WITH TEKWAY CEMENTATIOUS DETECTABLE DOMED SURFACE AND GROOVED
- (13) PROTECT EXISTING CURB IN PLACE.
- (14) CONSTRUCT CONCRETE CURB OF VARYING HEIGHT AND 3.5' WIDE CONCRETE SIDEWALK (OFFICIAL WIDTH 3.5').
- (15) CONSTRUCT CONCRETE STREET PAVING 8" CONCRETE OVER 8" CLASS 2 AGGREGATE BASE.
- (16) GRIND/PLANE ±2" OF EXISTING PAVING PER CITY STANDARD. THE DEPTH OF GRIND/PLANE TO BE ± 2 " BELOW PROPOSED FINISH GRADE.
- (17) ADJUST STREET NAME SIGN HEIGHT TO THE PLANE OF NEW PAVING.
- (18) CONSTRUCT STANDARD SEWER MANHOLE OVER EXISTING SEWER LINE. BREAK OUT EXISTING PIPE WITHIN NEW MANHOLE.
- (19) CONSTRUCT STANDARD CONCRETE CATCH BASIN WITHOUT CURB INLET AND WITH CAST IRON TRAP.
- 20 INSTALL 8" VCP SEWER BETWEEN MANHOLE AND CATCH BASIN. THE ELEVATIONS FOR THIS PIPE WILL BE DETERMINED IN THE FIELD, AFTER THE ELEVATION OF THE EXISTING SEWER IS DETERMINED WHEN IT IS EXCAVATED FOR THE CONSTRUCTION OF THE MANHOLE.
- (21) NOT USED
- (22) CONSTRUCT STANDARD CONCRETE SIDEWALK OF VARYING WIDTH.
- (23) CONSTRUCT CONCRETE CURB AND CONCRETE GUTTER WIDTH VARYING FROM 12" TO 24".
- 4" WIDE WHITE PAINTED SPACE MARKINGS. VERIFY SPACING WITH DPT PRIOR TO PAINTING IN CASE OF PARKING METER RELOCATIONS

GENERAL NOTES:

- 1. ALL CONSTRUCTION TO BE UNDERTAKEN IN ACCORDANCE WITH THE CITY OF SAN FRANCISCO STANDARD DETAILS AND SPECIFICATIONS.
- 2. ELEVATIONS ARE ON CITY OF SAN FRANCISCO DATUM.
- CONTRACTOR TO MAINTAIN PEDESTRIAN ACCESS AND PEDESTRIAN LOADING AND UNLOADING SPACE IN FRONT OF EXISTING HOSPITAL ON JACKSON STREET 24 HOURS A DAY, 7 DAYS A WEEK. IF THIS CANNOT BE ACCOMPLISHED, CONTRACTOR IS TO COORDINATE WITH HOSPITAL STAFF FOR ALTERNATE ACCESS.
- 4. CONTRACTOR IS CAUTIONED TO USE CARE IN WORKING ADJACENT TO AND IN THE SIDEWALK ALONG JACKSON STREET AND STONE STREET DUE TO THE PRESENCE OF AN UNDER-SIDEWALK BASEMENT.
- SEE STRUCTURAL AND WATERPROOFING PLANS FOR ADDITIONAL CONSTRUCTION REQUIREMENTS IN THE VICINITY OF JACKSON STREET AND STONE STREET.

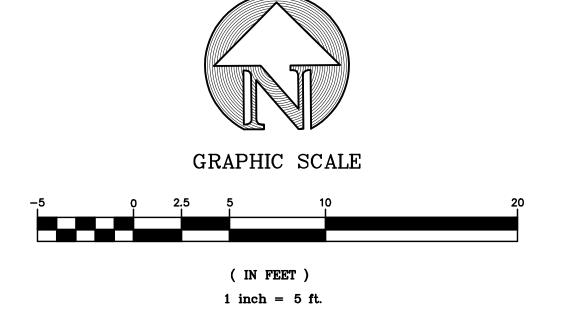



CHINESE

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OSHPD RESUBMITTAL	_	10.15.12
FOR REVIEW	_	02.04.13
OSHPD/CCSF RESUBMITTAL	_	02.19.13

Seals and Signatures


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Office of Statewide Health Planning and Development

FACILITIES DEVELOPMENT DIVISION



STREET **IMPROVEMENTS** 845 JACKSON STREET

Project Number

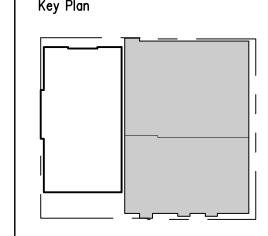Drawing Number

Print Date

DETAILED ELEVATION PLAN


AT TRANSFORMER VAULTS

CONSTRUCTION NOTES:

(835 JACKSON STREET)

- 1) LIMIT OF WORK.
- 2 SAWCUT LINE.
- (3) MATCH EXISTING.
- (4) REMOVE CURB, GUTTER AND SIDEWALK AND CONSTRUCT CONCRETE CURB WITH ±12" WIDE CONCRETE GUTTER AND ±10' WIDE CONCRETE SIDEWALK. (OFFICIAL WIDTH IS 10')
- (5) REMOVE CURB, GUTTER AND SIDEWALK AND CONSTRUCT CONCRETE CURB WITH ±12" WIDE CONCRETE GUTTER AND ±9'-1" WIDE CONCRETE SIDEWALK. (OFFICIAL WIDTH IS 10')
- (6) REMOVE PAVING AND BASE AND CONSTRUCT 8" CONCRETE BASE.
- 7 PLACE ±2" AC PAVING TO GRADES SHOWN.
- (8) ADJUST TOPS OF BOXES, VAULTS, CLEANOUTS, VALVE COVERS, ETC. TO THE PLANE OF THE NEW PAVING SURFACE.
- (9) PAINT CURB WHITE WITH APPROPRIATE CITY OF SAN FRANCISCO STENCILS INDICATING THE AREA FROM STATION 1+61 TO 2+58.75 ON JACKSON STREET AS A PASSENGER LOADING ZONE.
- (10) EXISTING STRUCTURES AND LATERALS TO BE REMOVED PER THE REQUIREMENTS OF THE RESPECTIVE UTILITY ENTITY.
- (11) REMOVE STREET LIGHT AND BASE.
- (12) CONSTRUCT 11.75 FOOT WIDE COMBINATION AUTOMOBILE RAMP AND PEDESTRIAN CURB RAMP. 8" THICK CONCRETE OVER 8" CLASS 2 AGGREGATE BASE, WITH TEKWAY CEMENTATIOUS DETECTABLE DOMED SURFACE AND GROOVED
- (13) PROTECT EXISTING CURB IN PLACE.
- (14) EXISTING TRANSFORMER VAULT TO BE REMOVED. COORDINATE WITH PG & E.
- (15) MATCH GRADES AT NEW HOSPITAL BUILDING.
- GRIND/PLANE ± 2 " OF EXISTING PAVING PER CITY STANDARD. THE DEPTH OF GRIND/PLANE TO BE ± 2 " BELOW PROPOSED FINISH GRADE.
- (17) RELOCATE STREET NAME SIGN TO (17A)
- (18) NOT USED
- (19) 4" WIDE WHITE PAINTED SPACE MARKINGS. VERIFY SPACING WITH DPT PRIOR TO PAINTING IN CASE OF PARKING METER RELOCATIONS.

- 4. CONTRACTOR IS CAUTIONED TO USE CARE IN WORKING ADJACENT TO AND IN THE SIDEWALK ALONG JACKSON STREET AND STONE STREET DUE TO THE PRESENCE OF AN UNDER-SIDEWALK BASEMENT.
- 5. SEE STRUCTURAL AND WATERPROOFING PLANS FOR ADDITIONAL CONSTRUCTION REQUIREMENTS IN THE VICINITY OF JACKSON STREET AND STONE STREET.

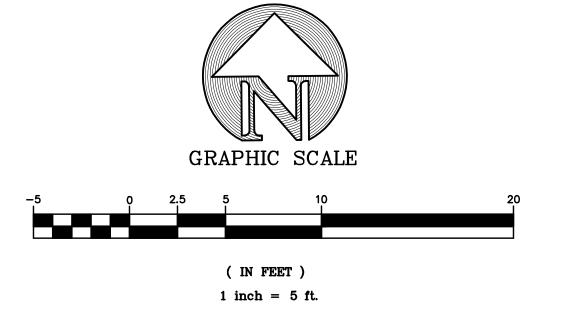

CHINESE

845 JACKSON STREET SAN FRANCISCO, CA

OSHPD # IS-072017 Facility Number 14621

NEW ACUTE CARE HOSPITAL & SKILLED NURSING UNIT

JACOBS

6688 North Central Expressway Suite 400, MB13 Dallas, TX 75206

Phone: 214.424.7500

CONSULTANTS:

MAZZETTI & ASSOCIATES - F.W.ASSOCIATES, INC. - SJ ENGINEERS

OWNER CONSULTANTS: KCA ENGINEERS SURE ENGINEERS TREADWELL & ROLLO



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Seals and Signatures


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Office of Statewide Health Planning and Development

FACILITIES DEVELOPMENT DIVISION



Drawing Title SURFACE **IMPROVEMENTS**

835 JACKSON STREET Project Number

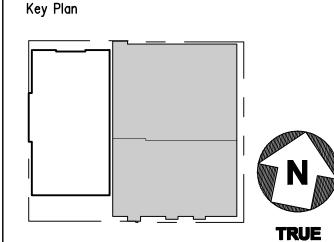024338 Drawing Number

Print Date

UTILITY CONSTRUCTION NOTES:

- 8" VCP COMBINED SEWER WITH CLEANOUT AT END AND WYE TO 12" VCP COMBINED SEWER.
- 22 SEE PLUMBING, MECHANICAL, ELECTRICAL, ETC., PLANS FOR LOCATION AND ELEVATION OF UTILITY POINTS OF CONNECTION. SEE INCREMENT 5 PLANS.
- 23 APPROXIMATE LOCATION FOR NEW PRIMARY ELECTRICAL SERVICE CONDUITS. COORDINATE WITH PG&E FOR REQUIREMENTS EXACT LOCATION AND AMOUNT OF CONDUIT. SEE INCREMENT 5 PLANS.
- EXACT LOCATION AND AMOUNT OF CONDUIT. SEE INCREMENT 5 PLANS..
- 27 CONNECT 4" STORM SEWER WITH FRESH AIR INLET AND TRAP TO THE 8"
- 29 12" VCP COMBINED SEWER @ ±1% SLOPE. SEE SHEET C4.4.
- NEW UNDERGROUND PG&E TRANSFORMER VAULTS EXACT LOCATION, SIZE DEPTH TO BE DETERMINED BY PG&E.
- 31 NEW ELECTRICAL SERVICE ENTRANCE. CONDUIT BETWEEN UNDERGROUND VAULT AND MAIN ELECTRICAL ROOM. EXACT LOCATION AND ELEVATION TO BE DETERMINED WITH PG&E. SEE INCREMENT 5 PLANS.
- 32 FUEL OIL VENT AND SERVICE LINES. SEE PLUMBING AND FUEL OIL PLANS.
- 34 INSTALL SHUTOFF VALVES PER NFPA 24 AND CITY OF SAN FRANCISCO STANDARDS.
- 36 CONSTRUCT STANDARD CITY SEWER MANHOLE FOR PIPES 27" TO 48" IN

- 41 4-5" ELECTRICAL CONDUIT TO TEMPORARY ELECTRICAL SERVICE PANEL. SEE INCREMENT 5 PLANS.


(835 JACKSON STREET)

- 15 6" VCP STORM SEWER WITH FRESH AIR INLET AND TRAP.
- 5,000 GALLON DOUBLE WALL FUEL STORAGE TANKS 6' DIAMETER, 24.75 FOOT LONG. SEE PLUMBING DRAWINGS FOR PIPING, HOLDDOWN SLAB DIMENSIONS, BACKFILL AND MANHOLE. ALL COVERS TO CONFORM TO ADA REQUIREMENTS AND TO HAVE A SLIP RESISTANT SURFACE. SEE INCREMENT 5 PLANS
- 24 APPROXIMATE LOCATION FOR COMMUNICATIONS, CABLE, TELEVISION, TELEPHONE, ETC. CONDUITS. SEE COMMUNICATIONS, ETC. PLANS FOR
- COMBINED SEWER.
- 28 COORDINATE CONSTRUCTION OF WATER AND FIRE WATER LINES WITH WATER AND FIRE DEPARTMENTS. WATER METER TO BE INSTALLED IN SIDEWALK FOR DOMESTIC WATER SERVICE.

- SEE INCREMENT 5 PLANS.
- 33 2-5" ELECTRICAL CONDUIT FOR FIRE PUMP SERVICE. SEE INCREMENT 5 PLANS.
- MAIN SHUTOFF VALVE IS LOCATED IN FIRE PUMP ROOM. SEE PLUMBING DRAWINGS. SEE INCREMENT 5 DRAWINGS.
- DIAMETER. SEE NOTE "H" ON SHEET C4.4.
- 37 SUPPORT EXISTING WATER AND ELECTRICAL DUCTS CONDUITS AND PIPES AS NECESSARY DURING MANHOLE CONSTRUCTION.
- CONNECT 6" SANITARY SEWER AND 4" STORM DRAIN FROM BUILDING TO THE 8" COMBINED SEWER WITH A FRESH AIR INLET AND TRAP.
- 39 GAS SERVICE LINE. SEE PLUMBING PLANS. CONSTRUCTION TO BE UNDERTAKEN PER PG & E STANDARDS. SEE INCREMENT 5 PLANS.
- 40 NEW TELEPHONE CONDUITS, CONDUCTORS, ETC. COORDINATE WITH



- 1. ALL CONSTRUCTION TO BE UNDERTAKEN IN ACCORDANCE WITH THE CITY OF SAN FRANCISCO STANDARD DETAILS AND SPECIFICATIONS.
- 2. ELEVATIONS ARE ON CITY OF SAN FRANCISCO DATUM.
- 3. CONTRACTOR TO MAINTAIN PEDESTRIAN ACCESS AND PEDESTRIAN LOADING AND UNLOADING SPACE IN FRONT OF EXISTING HOSPITAL ON JACKSON STREET 24 HOURS A DAY, 7 DAYS A WEEK. IF THIS CANNOT BE ACCOMPLISHED, CONTRACTOR IS TO COORDINATE WITH HOSPITAL STAFF FOR ALTERNATE ACCESS.
- 4. SEE INCREMENT 5 PLANS FOR PLUMBING AND ELECTRICAL INFORMATION INCLUDING A. FUEL STORAGE TANK AND APPURTENANCES. B. MAIN FIRE WATER SHUTOFF VALVE. C. FUEL OIL PLUMBING, VENT AND ELECTRICAL LINES. D. GAS LINES.

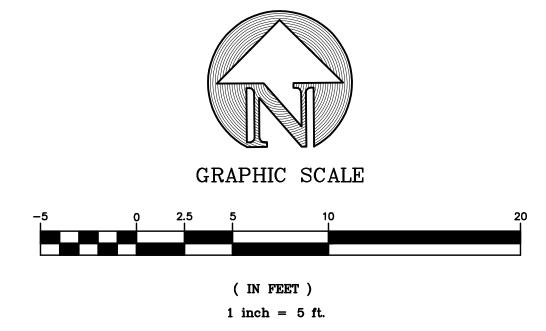

EMASSI CHINESE

845 JACKSON STREET SAN FRANCISCO, CA

OSHPD # IS-072017

Facility Number 14621 **NEW ACUTE CARE**

HOSPITAL & SKILLED

NURSING UNIT JACOBS

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Dallas, TX 75206 Phone: 214.424.7500

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OWNER CONSULTANTS:

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BID SET 07-23-12




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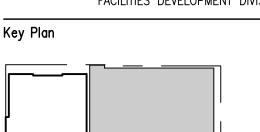
Seals and Signatures


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Office of Statewide Health Planning and Development FACILITIES DEVELOPMENT DIVISION






Drawing Title **UNDERGROUND IMPROVEMENTS**

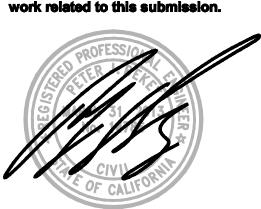835 JACKSON STREET

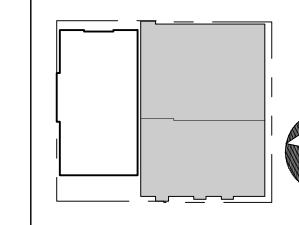Print Date

Project Number 024338 Drawing Number

JAMES ALLEY SURFACE IMPROVEMENTS SCALE: 1" = 5

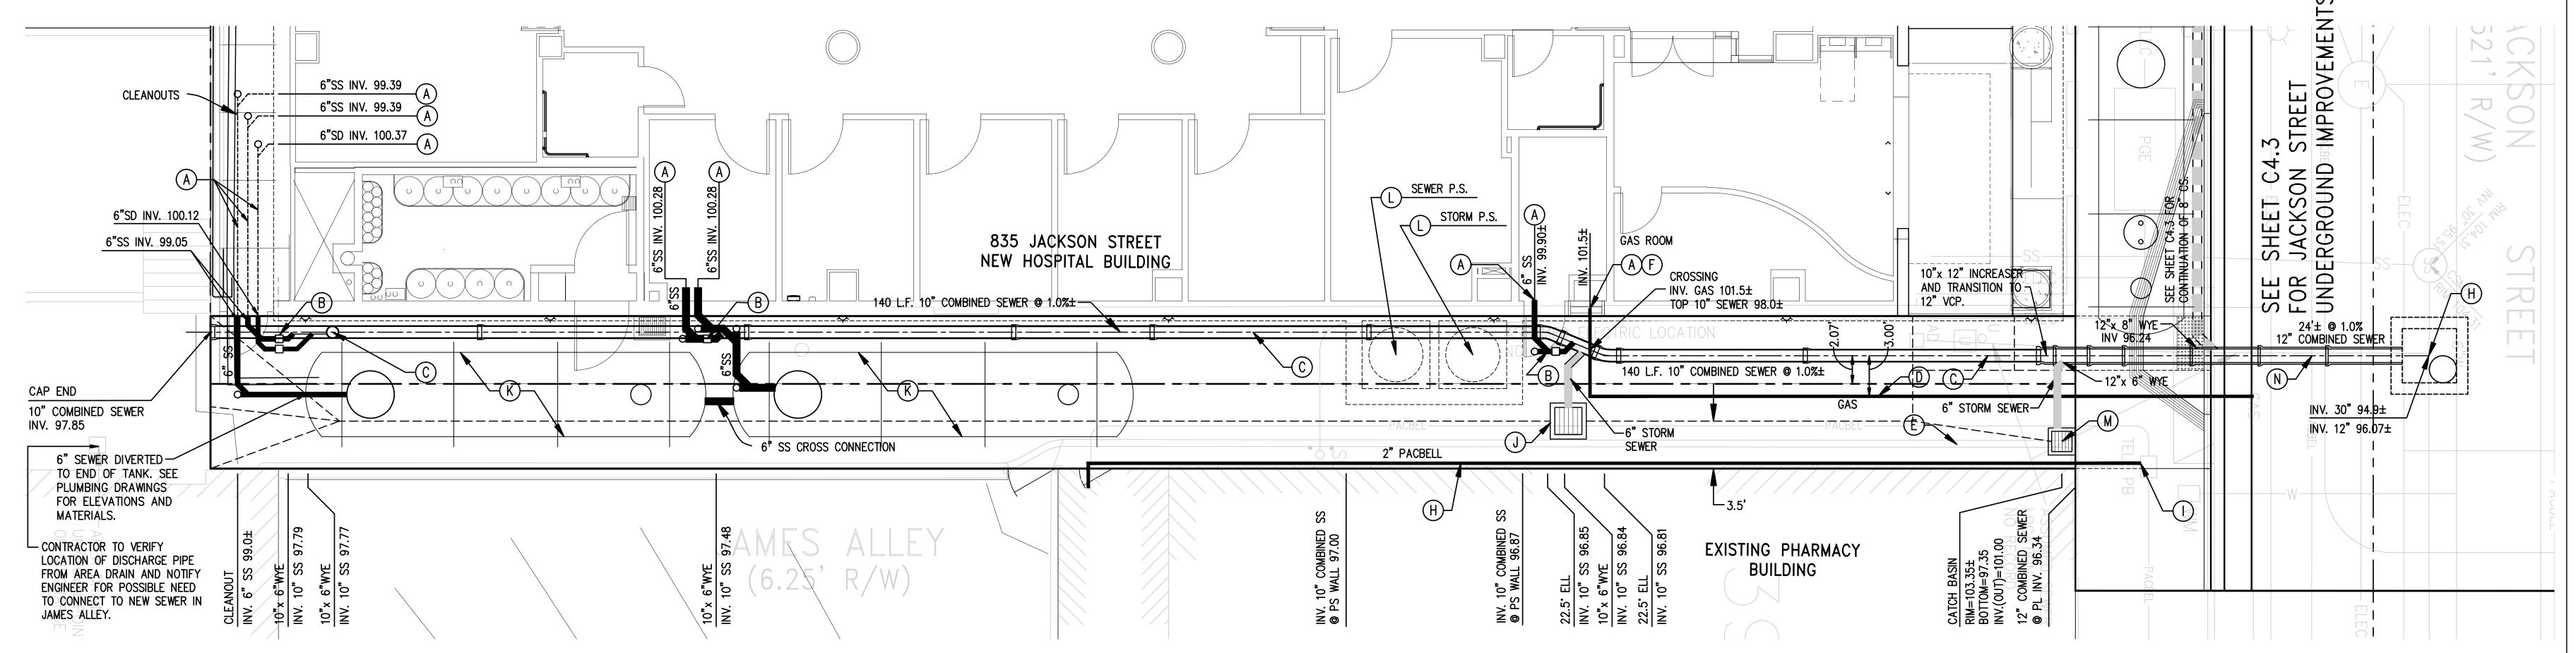

JAMES ALLEY UNDERGROUND IMPROVEMENTS

SCALE: 1" = 5

CONSTRUCTION NOTES:

(JAMES ALLEY SURFACE IMPROVEMENTS)

- 1 LIMIT OF WORK
- 2 SAWCUT LINE
- (3) MATCH EXISTING
- (4) MATCH NEW HOSPITAL BUILDING
- THICK CONCRETE PAVING ON 8" THICK CLASS 2 AGGREGATE BASE.
- (6) REMOVE STREET LIGHT, BOLLARDS, CONDUIT, WIRES, ETC.
- (7) REMOVE PIPES, DRAINS AND BOXES.
- 8 REMOVE TELEPHONE CONDUIT, WIRES, BOXES, ETC. COORDINATE WITH AT&T TO PROVIDE TEMPORARY SERVICE.
- (9) BELOW EACH BUILDING MOUNTED LIGHT, INSTALL A "NO PARKING ANY TIME" SIGN, A "DANGER COMPRESSED GAS" SIGN, AND A "NO SMOKING" SIGN.
- (10) ON THE OUTSIDE OF THE DOOR ATTACH A "DANGER COMPRESSED GAS" SIGN.
- (11) ON THE OUTSIDE FACE OF THE NEW HOSPITAL BUILDING AND ON THE OUTSIDE FACE OF THE PHARMACY BUILDING, INSTALL AN "EMERGENCY VEHICLES ONLY" SIGN.
- (12) INSTALL A SINGLE BICYCLE RACK BELOW EACH BUILDING MOUNTED LIGHT AND ONE HALF WAY BETWEEN. THE BICYCLE RACK SHOULD BE A BARCO 2 BIKE POST TURNED SIDEWAYS TO ACCOMODATE ONLY ONE BIKE. THIS DOES NOT INCLUDE THE LIGHT CLOSEST TO JACKSON STREET.
- (13) MATCH NEW WALL
- (14) ON THE OUTSIDE OF THE DOOR ATTACH A "NO SMOKING" SIGN.

CONSTRUCTION NOTES:

(JAMES ALLEY UTILITIES)

- SEE PLUMBING PLANS FOR HORIZONTAL AND VERTICAL LOCATION, PIPE SIZE AND PIPE MATERIAL OF UTILITY STUBOUTS FROM BUILDING TO POINT OF CONNECTION. SEE INCREMENT 5 PLANS.
- (B) CONSTRUCT VCP SEWER AND STORM DRAIN LATERALS WITH FRESH AIR INLET AND TRAP. SEE PLUMBING PLANS. SEE INCREMENT 5 PLANS.
- CONSTRUCT 10" DUCTILE IRON COMBINED SEWER WITH CLEANOUT.
- D CONSTRUCT PG&E GAS SERVICE LINE. SEE PLUMBING PLANS FOR ALL CONSTRUCTION INFORMATION. SEE INCREMENT 5 PLANS.
- WITH PACBELL FOR TEMPORARY SERVICE DURING CONSTRUCTION PERIOD.


REROUTED NEW TELEPHONE CONDUITS, CONDUCTORS, ETC. COORDINATE

- (F) INSTALL BOLLARDS PER PG & E STANDARDS TO PROTECT GAS LINE RISER.
- G NOT USED. (H) CONSTRUCT STANDARD CITY MANHOLE FOR PIPE SIZES 27" TO 48". CONSTRUCT MANHOLE BASE AND LEDGE AND INSTALL 12" COMBINED SEWER STUB. REMOVE UPPER HALF OF 30" PIPE LEAVING BOTTOM HALF AS THE FLOWLINE OF THE MANHOLE. THEN COMPLETE THE MANHOLE CONSTRUCTION.
- (I) CONNECT TO EXISTING AT&T BOX.
- (J) INSTALL 24"x24" CATCH BASIN/SAND TRAP. CENTRAL PRECAST OR EQUAL, WITHOUT CLEANOUT AND WITH CAST IRON TRAP. GRATE TO BE ADA COMPLIANT AND TRUCK LOAD CAPACITY WITH LOCKING DEVICES.
- (K) 6,000 GALLON SEWER HOLDING TANK $\pm 6'-2$ 3/4" DIAMETER AND ± 29'-6 1/4" LENGTH. SEE PLUMBING PLANS FOR PIPING, HOLD DOWN SLAB DIMENSIONS, BACKFILL AND MANHOLES. .ALL COVERS TO CONFORM TO ADA. REQUIREMENTS AND TO HAVE A SLIP RESISTANT SURFACE. SEE INCREMENT


- TWO PUMP STATIONS. SEE STRUCTURAL, ELECTRICAL AND PLUMBING PLANS FOR ADDITIONAL INFORMATION. ALL COVERS TO CONFORM TO ADA REQUIREMENTS AND TO HAVE A SLIP RESISTANT SURFACE.
- INSTALL 18"x18" CATCH BASIN/SAND TRAP. CENTRAL PRECAST OR EQUAL, WITHOUT CLEANOUT AND WITH CAST IRON TRAP. GRATE TO BE ADA COMPLIANT AND TRUCK LOAD CAPACITY WITH LOCKING DEVICES.
- 12" EXTRA STRENGTH VCP PIPE COMBINED SEWER.
- O NOT USED

GENERAL NOTES:

- 1. ALL CONSTRUCTION TO BE UNDERTAKEN IN ACCORDANCE WITH THE CITY OF SAN FRANCISCO STANDARD DETAILS AND SPECIFICATIONS.
- 2. ELEVATIONS ARE ON CITY OF SAN FRANCISCO DATUM.
- SEE INCREMENT 5 PLANS FOR PLUMBING AND ELECTRICAL INFORMATION
- FUEL STORAGE TANK AND APPURTENANCES.
- GAS LINE. FUEL STORAGE TANK INTERCONNECT PIPELINES.
- ELECTRICAL AND CONTROL LINES. SANITART SEWER PIPELINES FROM FACE OF BUILDING TO STORAGE

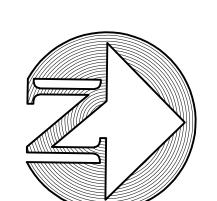

GRAPHIC SCALE

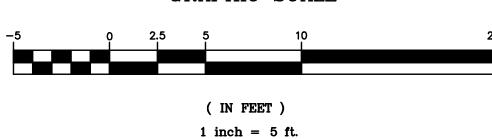

CHINESE 除制 HOSPITAL

845 JACKSON STREET SAN FRANCISCO, CA

OSHPD # IS-072017 Facility Number 14621

NEW ACUTE CARE HOSPITAL & SKILLED NURSING UNIT

JACOBS

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Phone: 214.424.7500

ARUP **MAZZETTI & ASSOCIATES** - F.W.ASSOCIATES, INC. - SJ ENGINEERS

OWNER CONSULTANTS: KCA ENGINEERS SURE ENGINEERS TREADWELL & ROLLO

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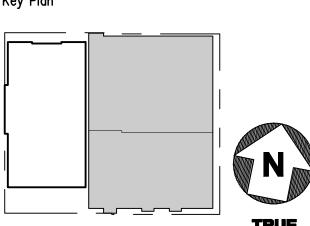
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REVIEWED IN ACCORDANCE WITH THE REQUIREMENTS OF T24, CCR APPROVED

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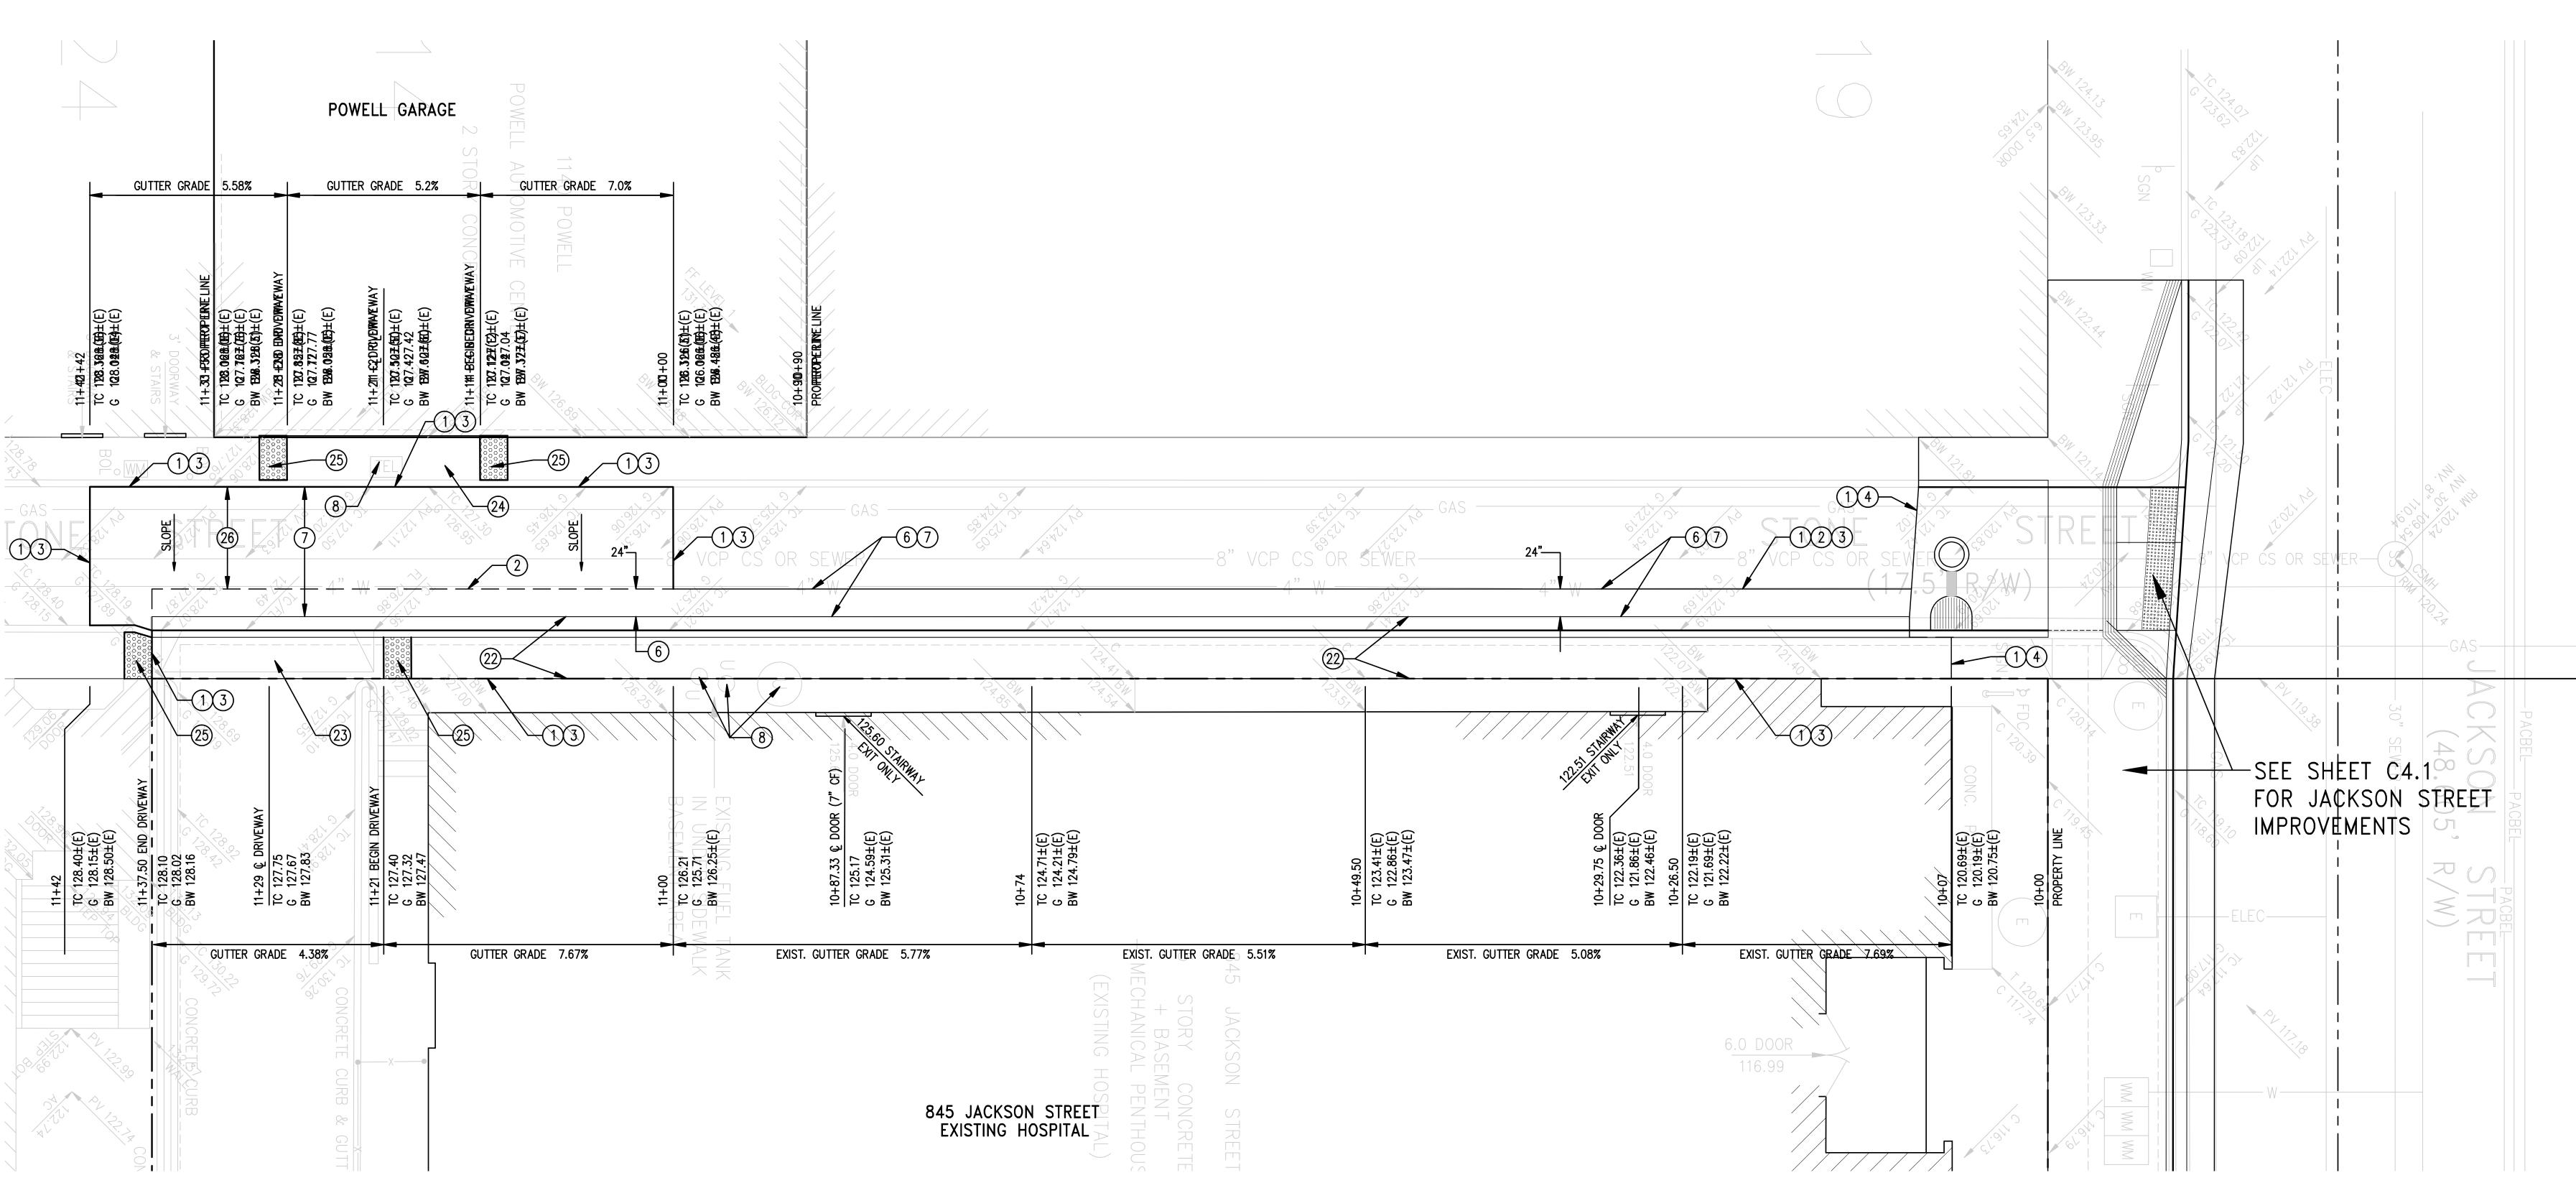
Drawing Title STREET **IMPROVEMENTS**

JAMES ALLEY

Project Number 024338

Drawing Number C4.4

Print Date




(STONE STREET)

- 1 LIMIT OF WORK.
- 2 SAWCUT LINE.
- (3) MATCH EXISTING.
- 4) MATCH IMPROVEMENTS ON SHEET C4.1.
- (6) REMOVE PAVING AND BASE AND CONSTRUCT 8" CONCRETE BASE.
- 7 PLACE 2" AC PAVING.
- 8 ADJUST TOPS OF BOXES, VAULTS, CLEANOUTS, VALVE COVERS, ETC. TO THE PLANE OF THE NEW PAVING SURFACE.
- 22) REMOVE CURB, GUTTER AND SIDEWALK AND CONSTRUCT CONCRETE CURB WITH ± 12 " WIDE CONCRETE GUTTER AND $\pm 3'-6$ " WIDE CONCRETE SIDEWALK. (OFFICIAL WIDTH IS 3.5')
- (23) CONSTRUCT 16' WIDE, 6" THICK CONCRETE AUTOMOBILE RAMP.
- 24 EXISTING SIDEWALK TO BE USED AS A 14 FOOT WIDE CONCRETE AUTOMOBILE RAMP.
- (25) APPLY A 24" LONG DOMED SURFACE FOR THE FULL WIDTH OF THE SIDEWALK AT EACH END OF THE DRIVEWAY.
- GRIND/PLANE $\pm 2"$ OF EXISTING PAVING PER CITY STANDARD. THE DEPTH OF GRIND/PLANE TO BE A MINIMUM OF $\pm 2"$ BELOW PROPOSED FINISH GRADES.

GENERAL NOTES:

- CITY OF SAN FRANCISCO STANDARD DETAILS AND SPECIFICATIONS.
- 2. ELEVATIONS ARE ON CITY OF SAN FRANCISCO DATUM.
- LOADING AND UNLOADING SPACE IN FRONT OF EXISTING HOSPITAL ON JACKSON STREET 24 HOURS A DAY, 7 DAYS A WEEK. IF THIS CANNOT BE ACCOMPLISHED, CONTRACTOR IS TO COORDINATE WITH HOSPITAL STAFF FOR ALTERNATE ACCESS.
- 4. CONTRACTOR IS CAUTIONED TO USE CARE IN WORKING ADJACENT TO AND IN THE SIDEWALK ALONG STONE STREET AND JACKSON STREET DUE TO THE PRESENCE OF AN UNDER-SIDEWALK BASEMENT.
- 5. SEE STRUCTURAL AND WATERPROOFING PLANS FOR ADDITIONAL CONSTRUCTION REQUIREMENTS IN THE VICINITY OF STONE STREET AND JACKSON STREET.

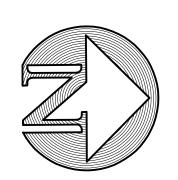

GRAPHIC SCALE

(IN FEET)

1 inch = 5 ft.

STONE STREET Project Number

Drawing Title

STREET

024338 Drawing Number C4.5

IMPROVEMENTS


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10/01/10



1. ALL CONSTRUCTION TO BE UNDERTAKEN IN ACCORDANCE WITH THE

3. CONTRACTOR TO MAINTAIN PEDESTRIAN ACCESS AND PEDESTRIAN

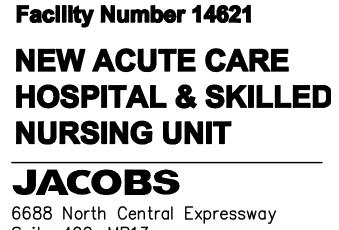

845 JACKSON STREET SAN FRANCISCO, CA

OSHPD # IS-072017

CHINESE

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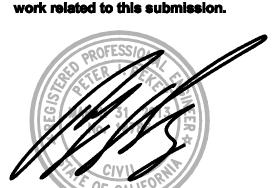
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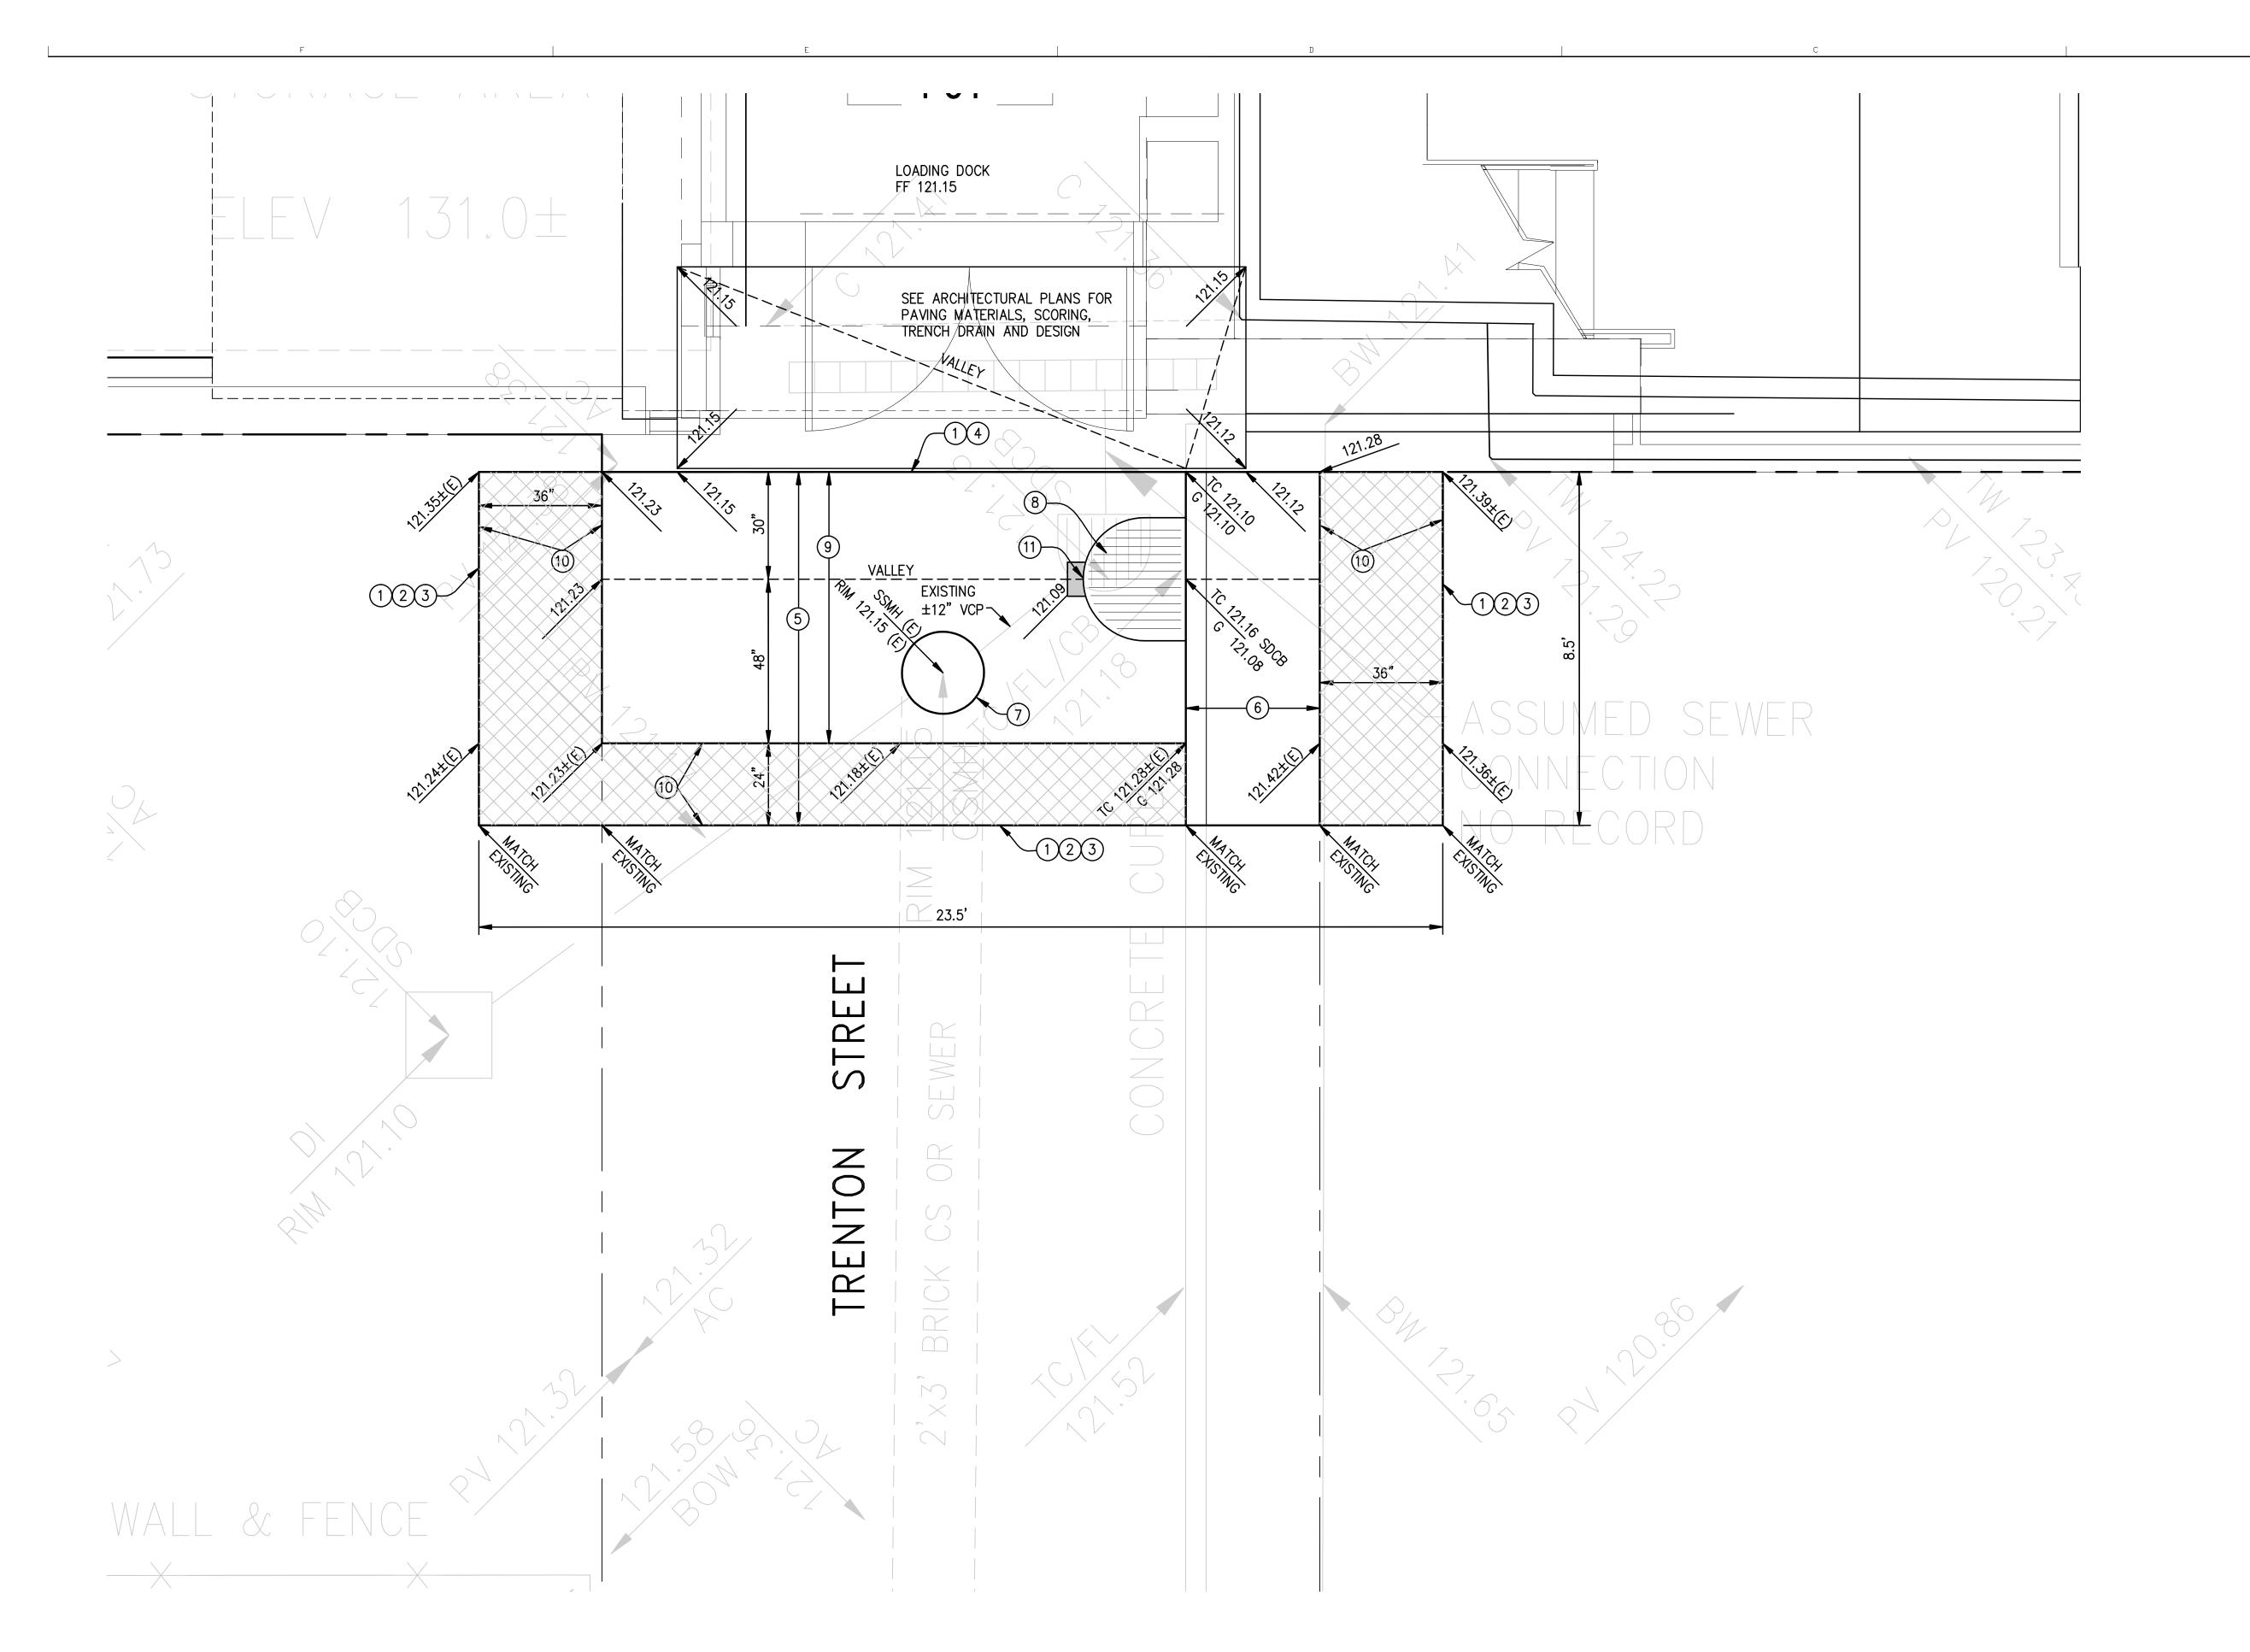
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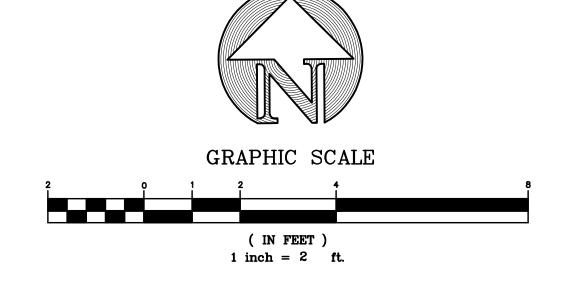


- 3 MATCH EXISTING.

- (7) ADJUST MANHOLE COVER INTO THE PLANE OF THE NEW PAVING.
- (9) CONSTRUCT 8" THICK CONCRETE VALLEY GUTTER WITH #4 BARS EACH WAY TOP AND BOTTOM AT 12" SPACING TO GRADES SHOWN,
- (10) CONSTRUCT 3" THICK AC PAVING ON 8" CONCRETE BASE.
- CONNECT NEW CATCH BASIN TO EXISTING STORM DRAIN PIPE WITH SAME SIZE AND MATERIAL STORM DRAIN PIPE. VERIFY ELEVATION PRIOR TO CONSTRUCTING CATCH BASIN.

GENERAL NOTES:

- THE CITY OF SAN FRANCISCO STANDARD DETAILS AND SPECIFICATIONS.
- 3. CONTRACTOR IS TO EXERCISE CARE WHILE WORKING IN THIS AREA BECAUSE OF THE PRESENCE OF SCHOOL CHILDREN.



- 1 LIMIT OF WORK.
- 2 SAWCUT LINE.
- 4 MATCH LOADING RAMP FOR NEW HOSPITAL BUILDING.
- (5) REMOVE PAVING, BASE, FLUSH CURB, SIDEWALK, ETC.
- 6 CONSTRUCT CONCRETE CURB WITH ±3' WIDE CONCRETE SIDEWALK. (OFFICIAL WIDTH 3.5')
- 8 REMOVE EXISTING CATCH BASIN AND CONSTRUCT STANDARD CITY CATCH BASIN WITHOUT CURB INLET AND WITH CAST IRON TRAP.
- ON 8" CONCRETE BASE.

- 1. ALL CONSTRUCTION TO BE UNDERTAKEN IN ACCORDANCE WITH
- 2. ELEVATIONS ARE ON CITY OF SAN FRANCISCO DATUM.
- 4. PRIOR TO UNDERTAKING THIS CONSTRUCTION CONTRACTOR IS TO VERIFY THE EXISTING ELEVATIONS.
- NEW PAVING AND STRIPING HAS RECENTLY BEEN CONSTRUCTED BY THE ADJACENT SCHOOL. CONTRACTOR TO REPLACE ANY STRIPING DAMAGED BY CONSTRUCTION.



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SURE ENGINEERS

TREADWELL & ROLLO



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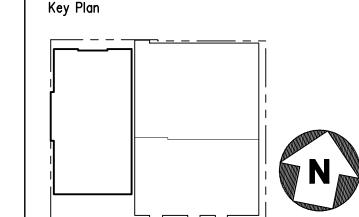
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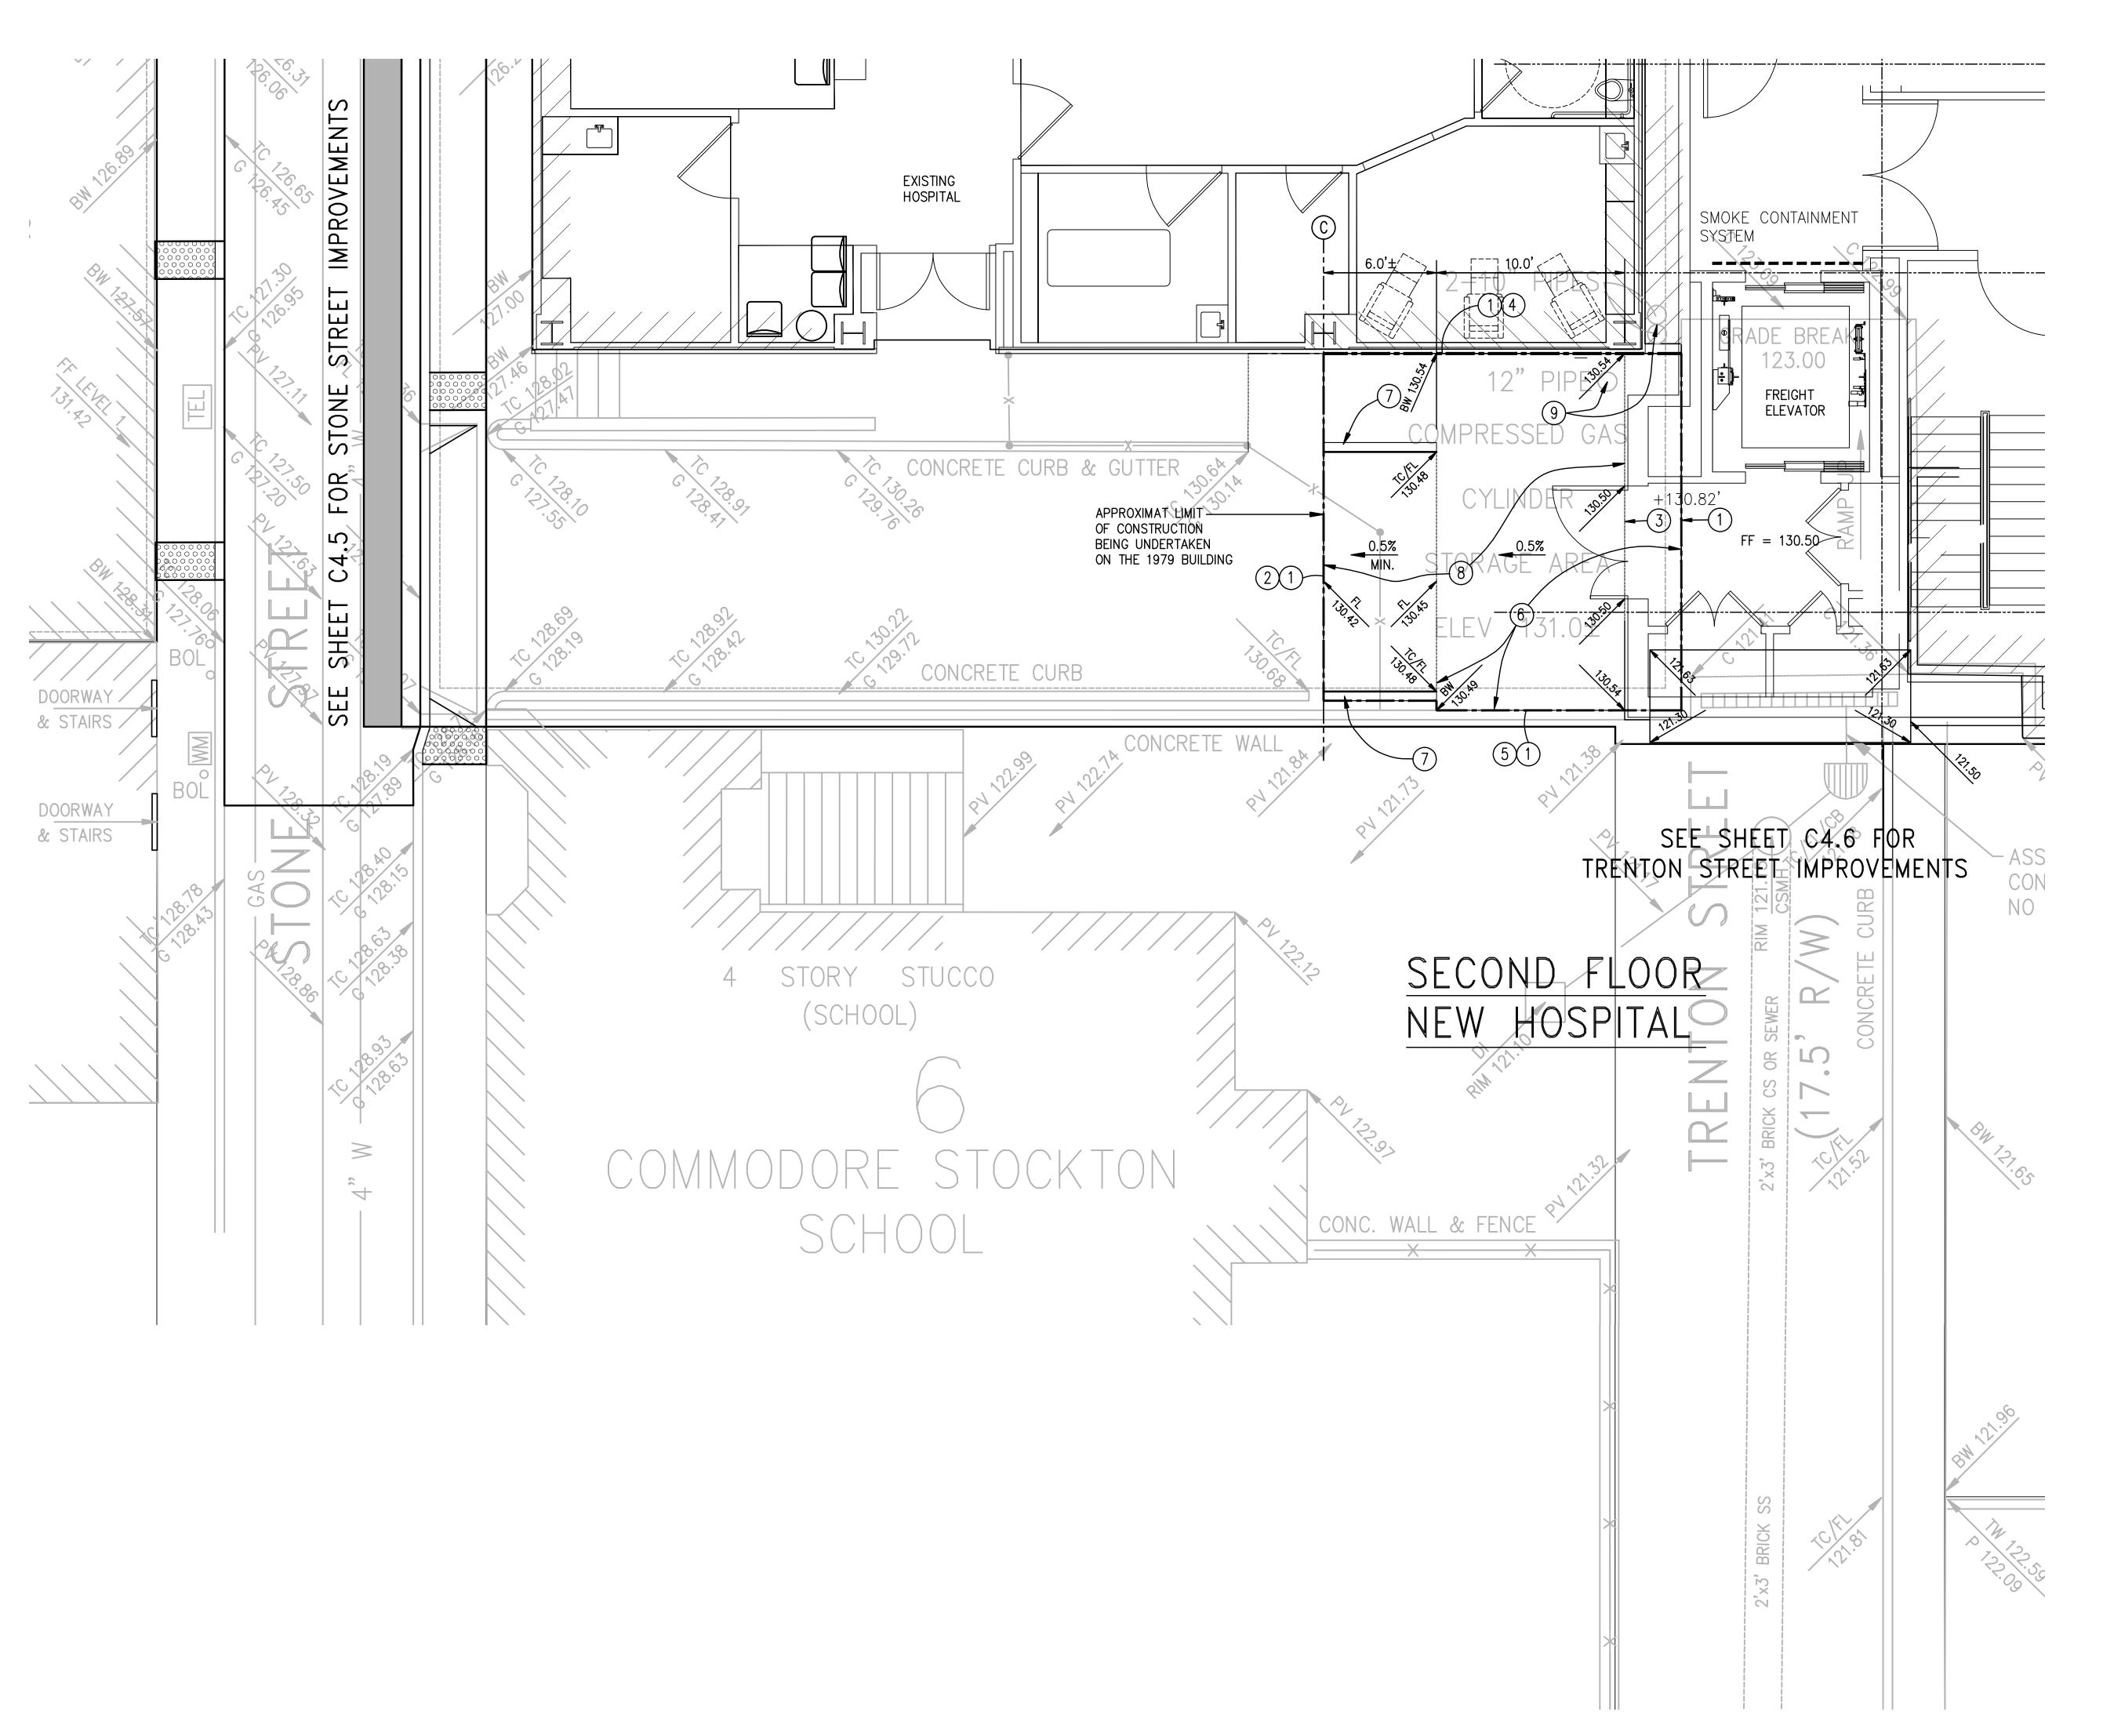
Office of Statewide Health Planning and Development FACILITIES DEVELOPMENT DIVISION



Drawing Title

STREET **IMPROVEMENTS**

TRENTON STREET Project Number



- (1) LIMIT OF WORK

- (7) CONSTRUCT NEW CURB. APPLY TO EXISTING STRUCTURE
- (8) CONSTRUCT CONCRETE PAVING AS NECESSARY TO CONFORM TO GRADES SHOWN. AFTER DEMOLITION THE ENGINEER WILL ISSUE A SKETCH ADJUSTING GRADES IF NECESSARY TO MINIMIZE THE IMPACT ON THE BASEMENT STRUCTURE. CONCRETE PAVING TO HAVE A BROOMED FINISH WITH APPROXIMATELY 36" SPACING ON SCORE LINES.

GENERAL NOTES:

- THE CITY OF SAN FRANCISCO STANDARD DETAILS AND SPECIFICATIONS.
- CONTRACTOR IS CAUTIONED TO USE EXTREME CARE WHILE WORKING IN THIS AREA IN ORDER TO NOT DAMAGE THE EXISTING BASEMENT ROOF SURFACE
- 4. EXISTING MEDICAL GAS FACILITIES TO BE RELOCATED IN ACCORDANCE WITH
- 5. PRIOR TO PLACING NEW PAVING, ARCHITECT WILL DETERMINE IF A WATER PROOFING MEMBRANE NEEDS TO BE INSTALLED.
- 6. THIS WORK TO BE COORDINATED WITH THE DESIGN PREPARED BY PERKINS EASTMAN ARCHITECTS FOR THE 1979 BUILDING, WHICH WILL PROBABLY HAVE BEEN COMPLETED AT THE TIME THIS WORK IS TO BE UNDERTAKEN.



- (2) MATCH EXISTING
- (3) MATCH PROPOSED HOSPITAL
- (4) MATCH EXISTING HOSPITAL
- (5) MATCH EXISTING WALL
- 6 REMOVE FENCING, TEMPORARY PAVING, CURB, SIDEWALK AND MEDICAL GAS ENCLOSURES.
- PER CALTRANS STANDARD A87 WITH 8" LONG #4 DOWELS GROUTED INTO HOLES AT \pm 5' SPACING.
- (9) PROTECT EXISTING PIPES IN PLACE.

- 1. ALL CONSTRUCTION TO BE UNDERTAKEN IN ACCORDANCE WITH
- 2. ELEVATIONS ARE ON CITY OF SAN FRANCISCO DATUM.
- PLANS BEING PREPARED BY OTHERS.

GRAPHIC SCALE (IN FEET)
1 inch = 4 ft.

等議議 CHINESE 等流域 HOSPITAL HOSPITAL **845 JACKSON STREET**

OSHPD # IS-072017

SAN FRANCISCO, CA

Facility Number 14621 **NEW ACUTE CARE**

HOSPITAL & SKILLED NURSING UNIT

JACOBS

6688 North Central Expressway Suite 400, MB13 Dallas, TX 75206 Phone: 214.424.7500

CONSULTANTS:

ARUP MAZZETTI & ASSOCIATES - F.W.ASSOCIATES, INC. - 8J ENGINEERS

OWNER CONSULTANTS: KCA ENGINEERS SURE ENGINEERS

TREADWELL & ROLLO


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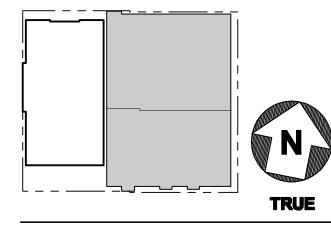
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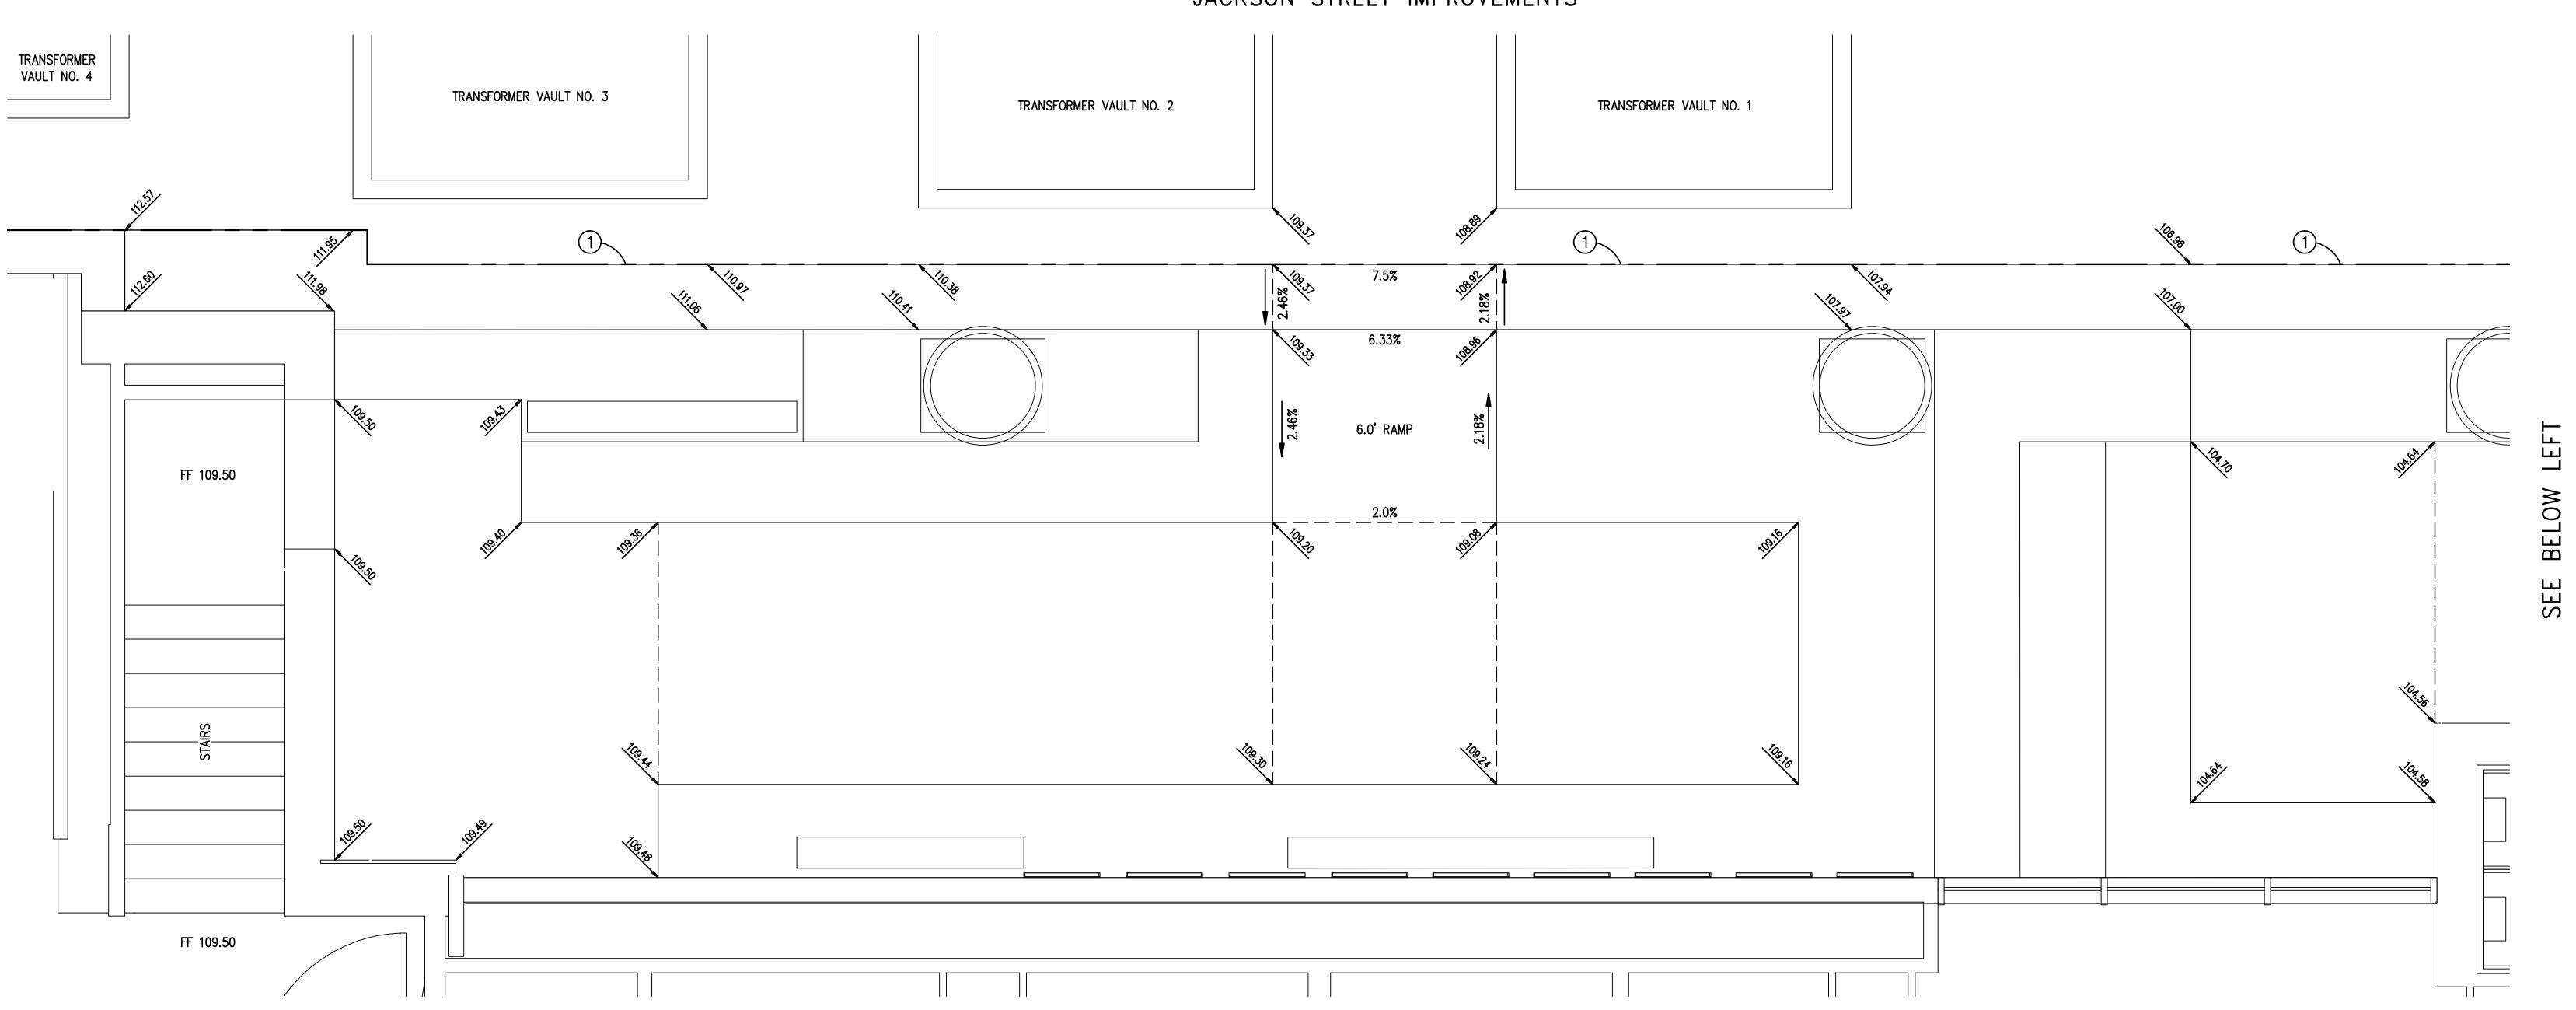



Drawing Title **GRADING PLAN BEHIND EXISTING**

HOSPITAL Project Number

Drawing Number

JACKSON STREET SEE SHEET C4.2 & C4.3 FOR JACKSON STREET IMPROVEMENTS

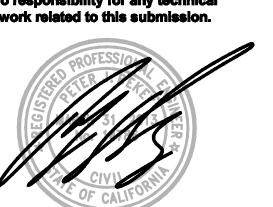

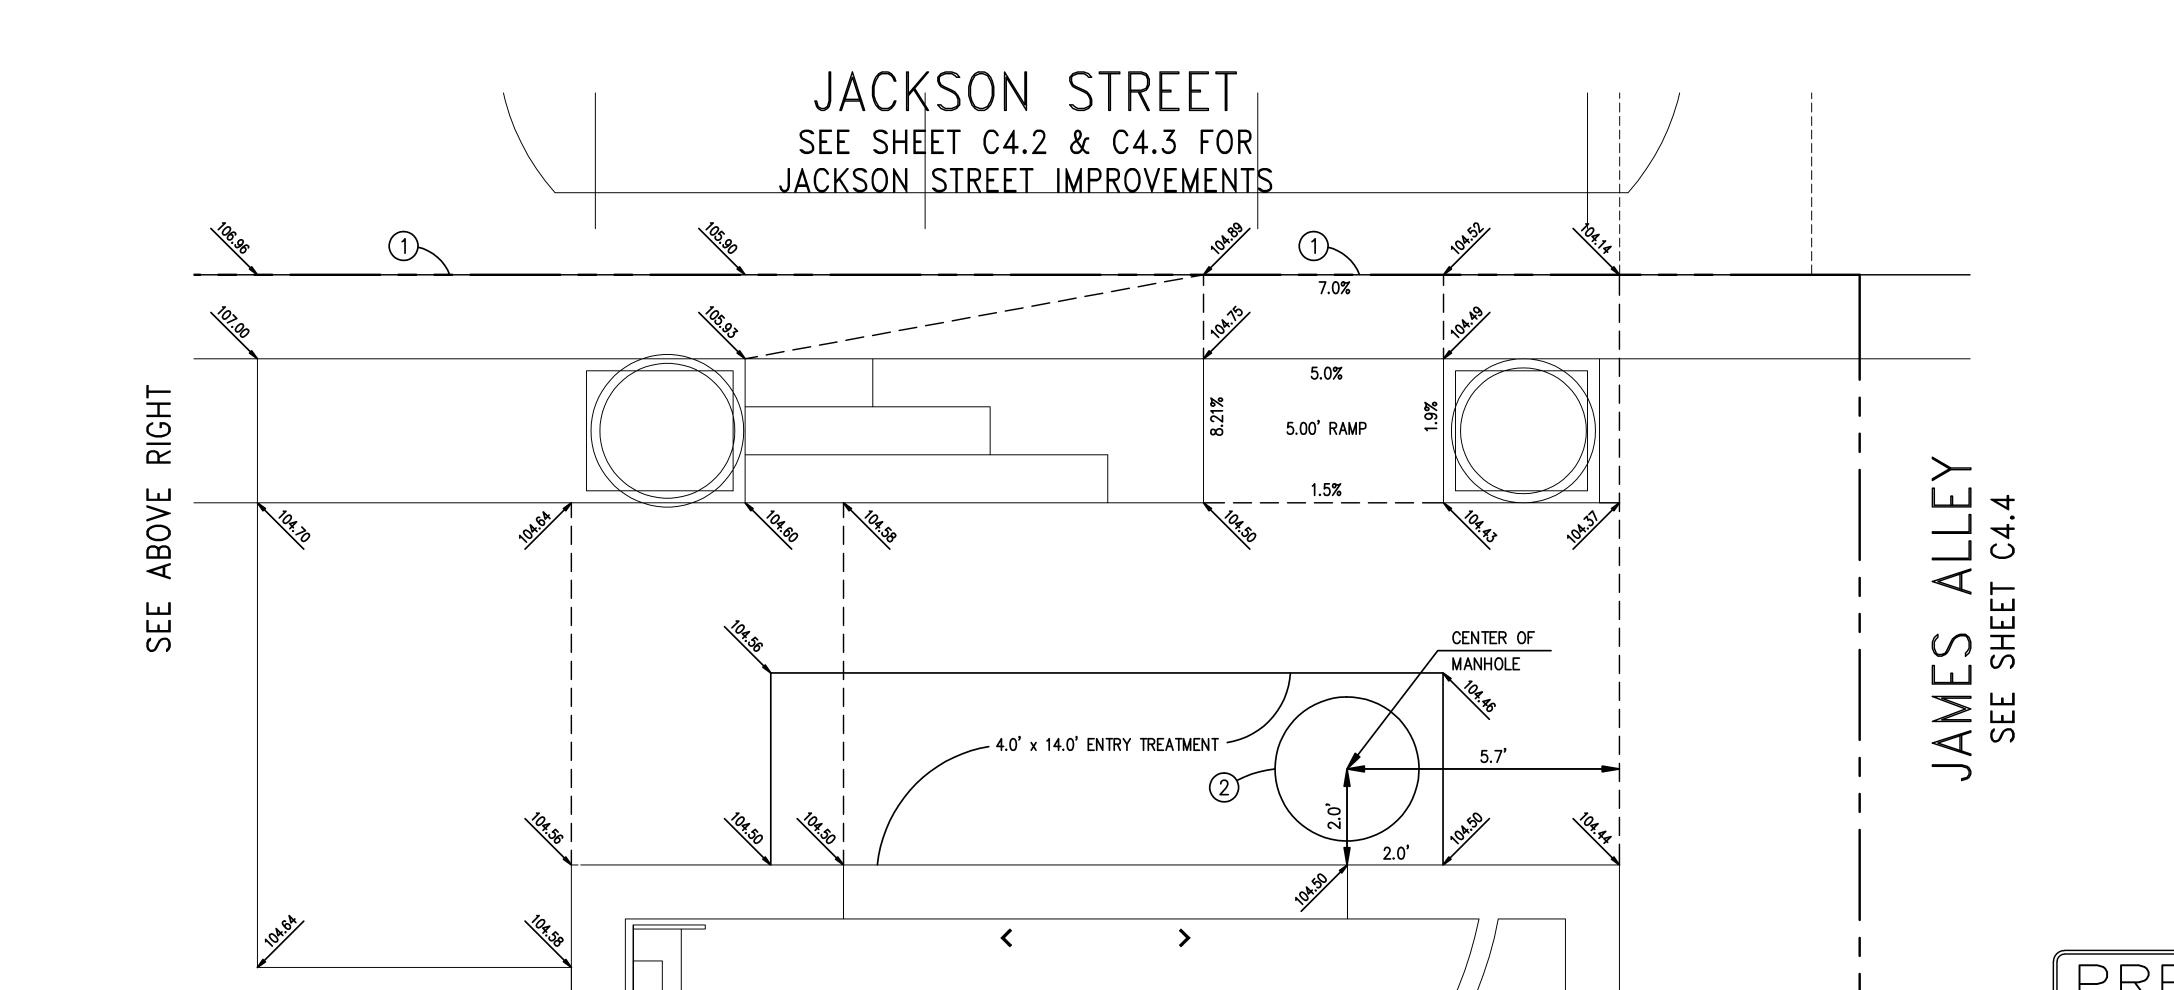

FF 104.50


GENERAL NOTES:

- 1. THIS PLAN IS FOR DETERMINING ELEVATIONS FOR THE TOPPING SLAB/FINISH SURFACE ONLY. SEE ARCHITECTURAL PLANS FOR PAVING MATERIALS, STAIR DETAILS, DRAINAGE AND ALL OTHER CONSTRUCTION ITEMS.
- 2. CONTRACTOR TO VERIFY THE LOCATION OF COLUMNS AND LEDGES AND NOTIFY ENGINEER, SO THAT FINISH GRADES CAN BE ADJUSTED TO ASSURE ADA COMPLIANCE.

CONSTRUCTION NOTES:

FOR REVIEW ~ 01.28.13

- 1) MATCH NEW STREET CONSTRUCTION
- 36" ACCESS MANHOLE TO FIRE PROTECTION STORAGE TANK. SEE ARCHITECTURAL PLANS FOR SURFACE TREATMENT OF THE MANHOLE COVER. SEE STRUCTURAL PLANS FOR CONSTRUCTION DETAILS FOR MANHOLE FRAME.

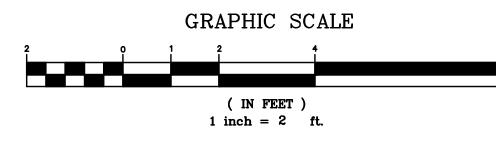

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845 JACKSON STREET SAN FRANCISCO, CA

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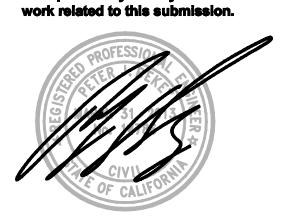
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CITY SUBMITTAL	_	09.17.10
CITY RESUBMITTAL	_	09.30.11
OSHPD RESUBMITTAL	_	10.15.12
REVISED TERRACES		01.25.13
FOR REVIEW	_	02.04.13
OSHPD/CCSF RESUBMITTAL	_	02.19.13


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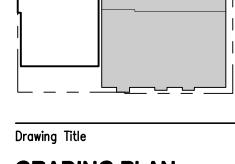
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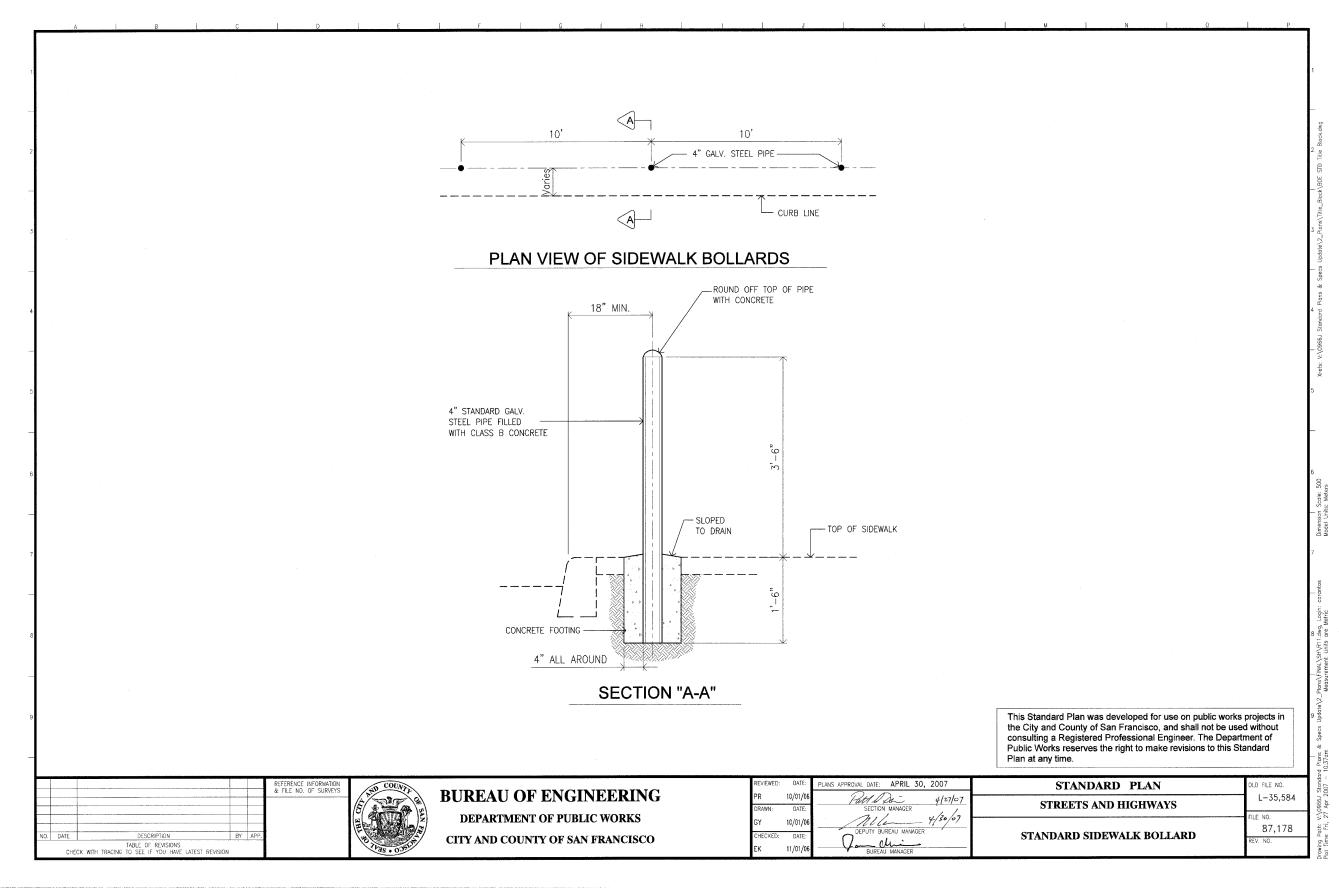
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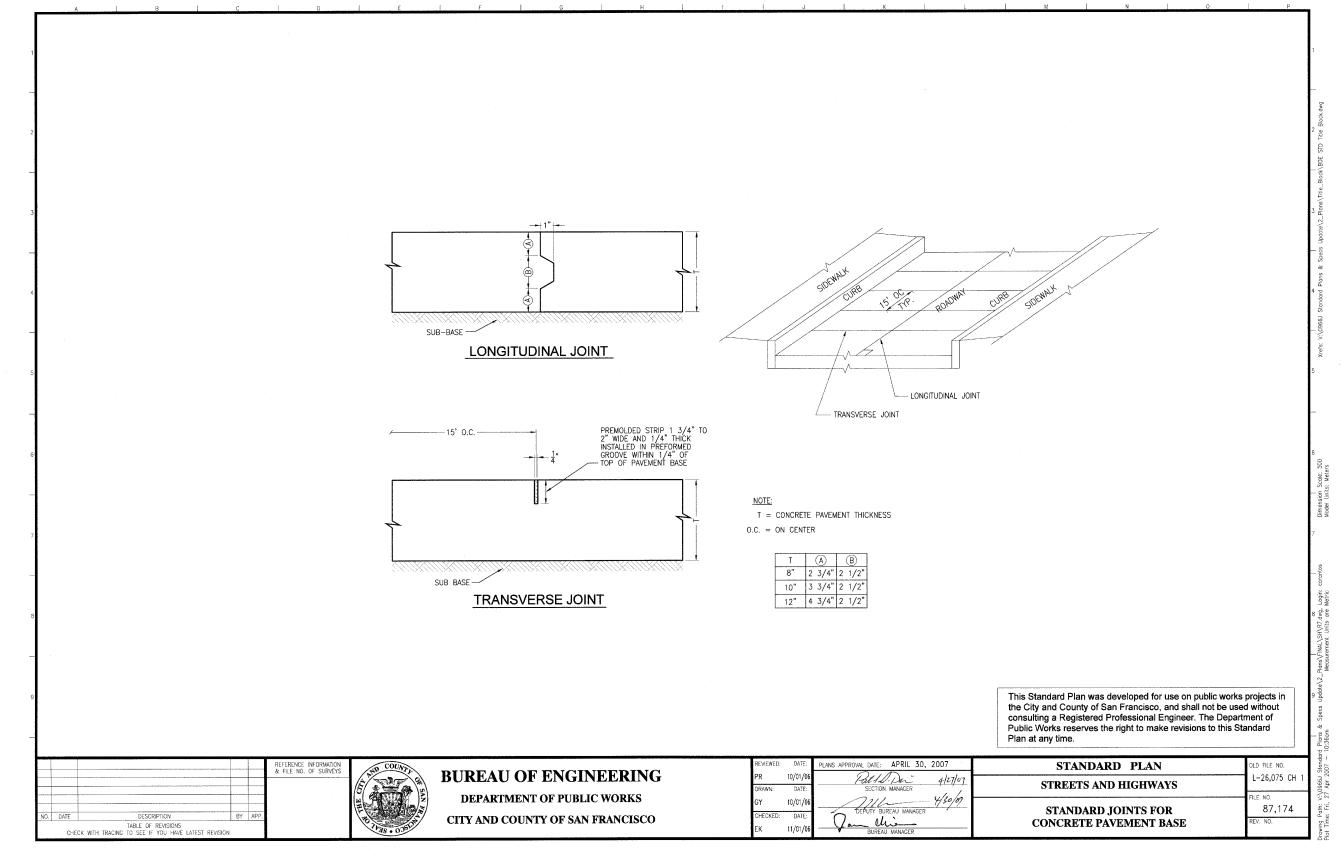
NEW HOSPITAL


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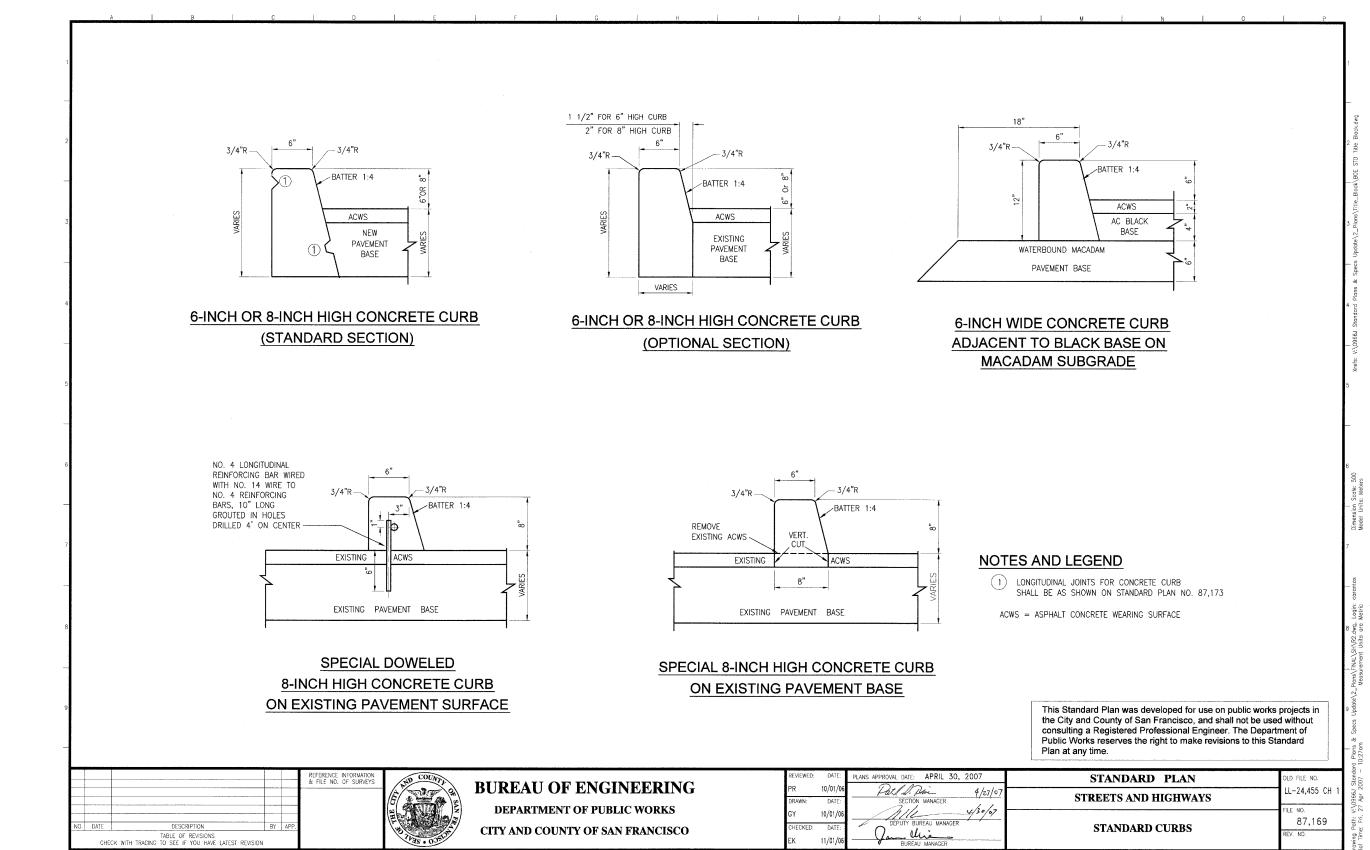
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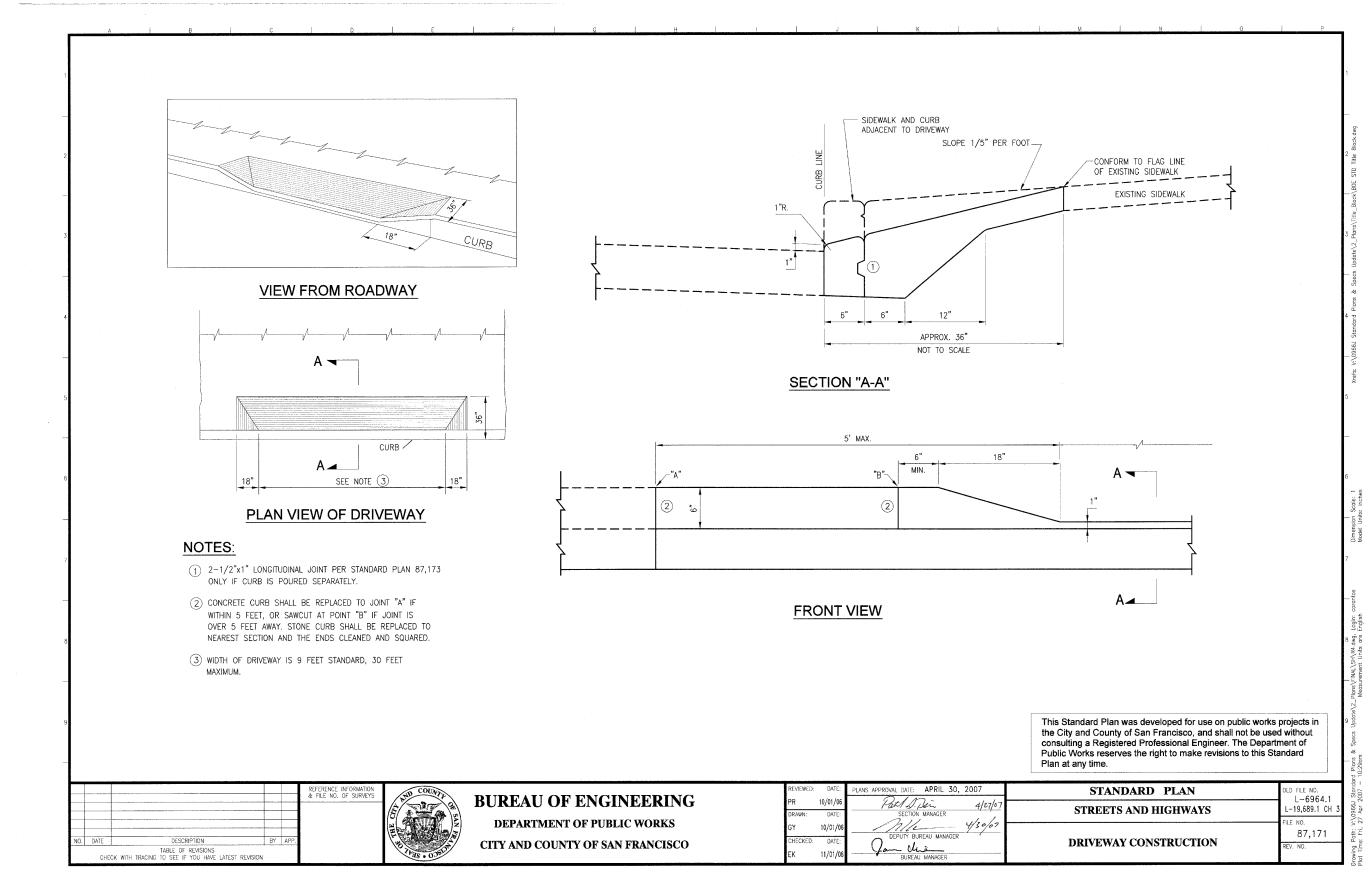
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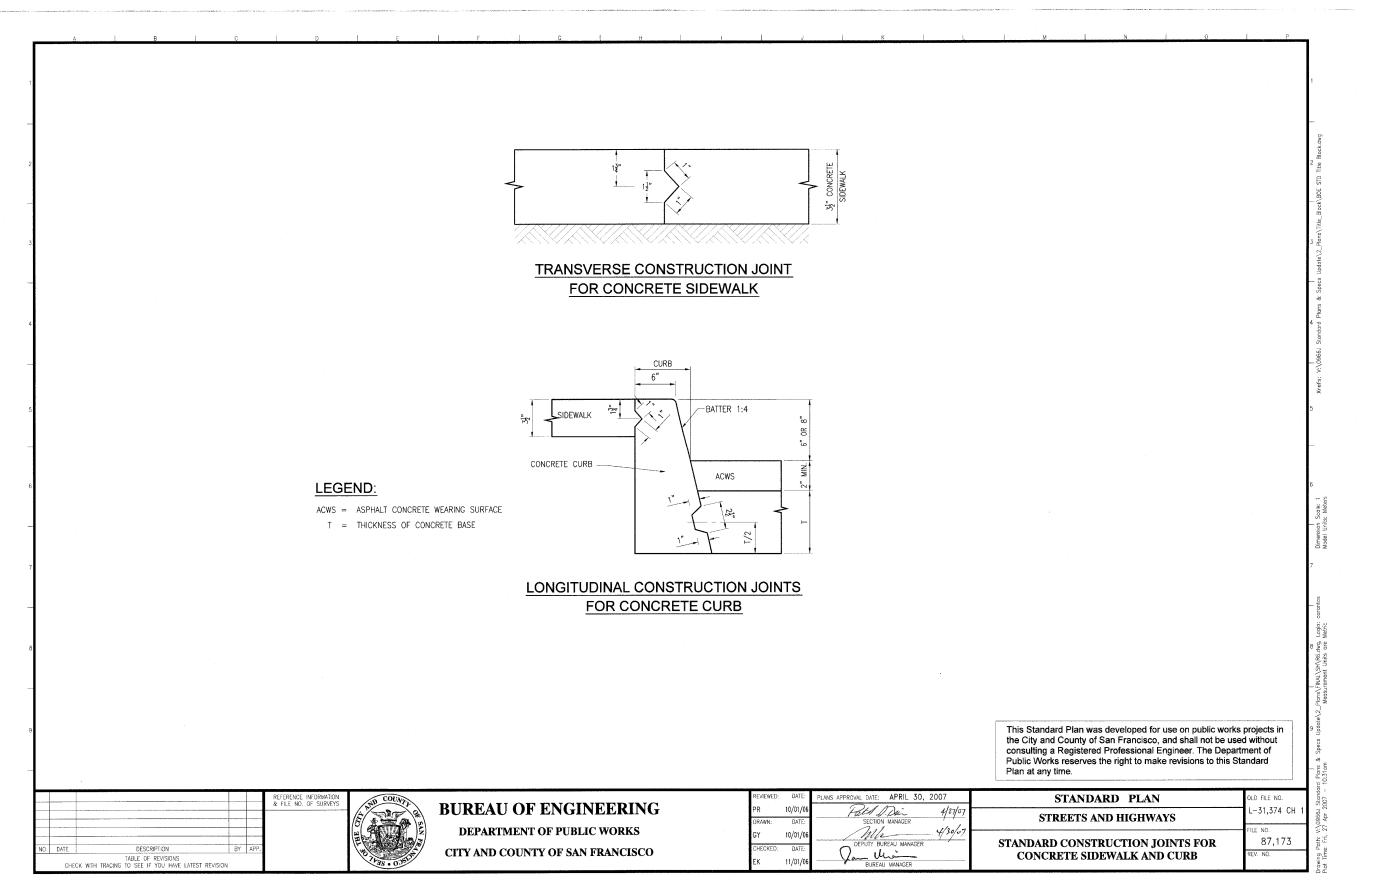








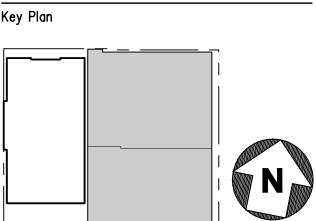

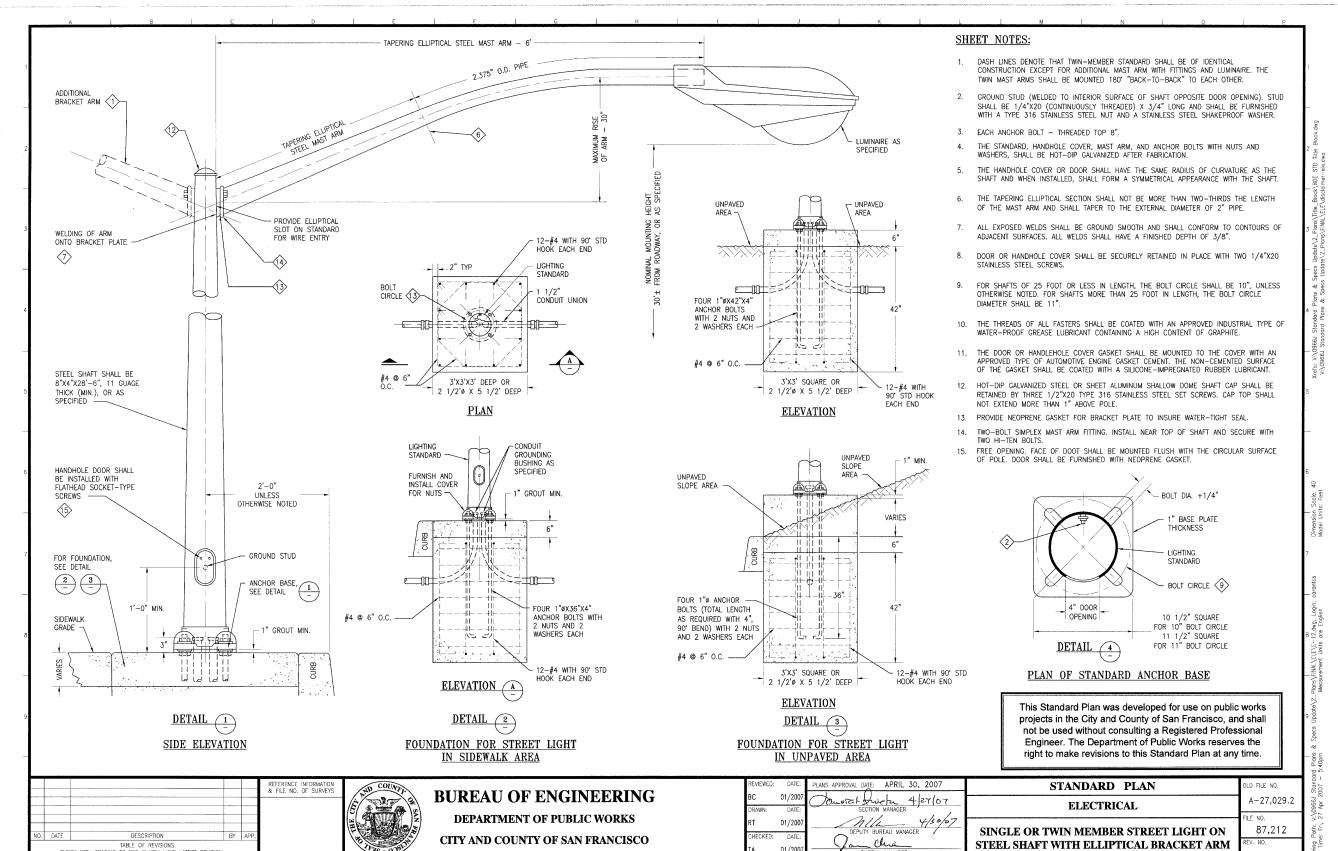



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OWNER CONSULTANTS:

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KCA ENGINEERS SURE ENGINEERS TREADWELL & ROLLO

BID SET 07-23-12

KCA ENGINEERS INC. CONSULTING CIVIL ENGINEERS

& LAND SURVEYORS 318 BRANNAN ST. SAN FRANCISCO, CA. 94107

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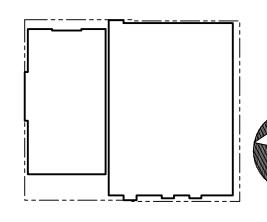
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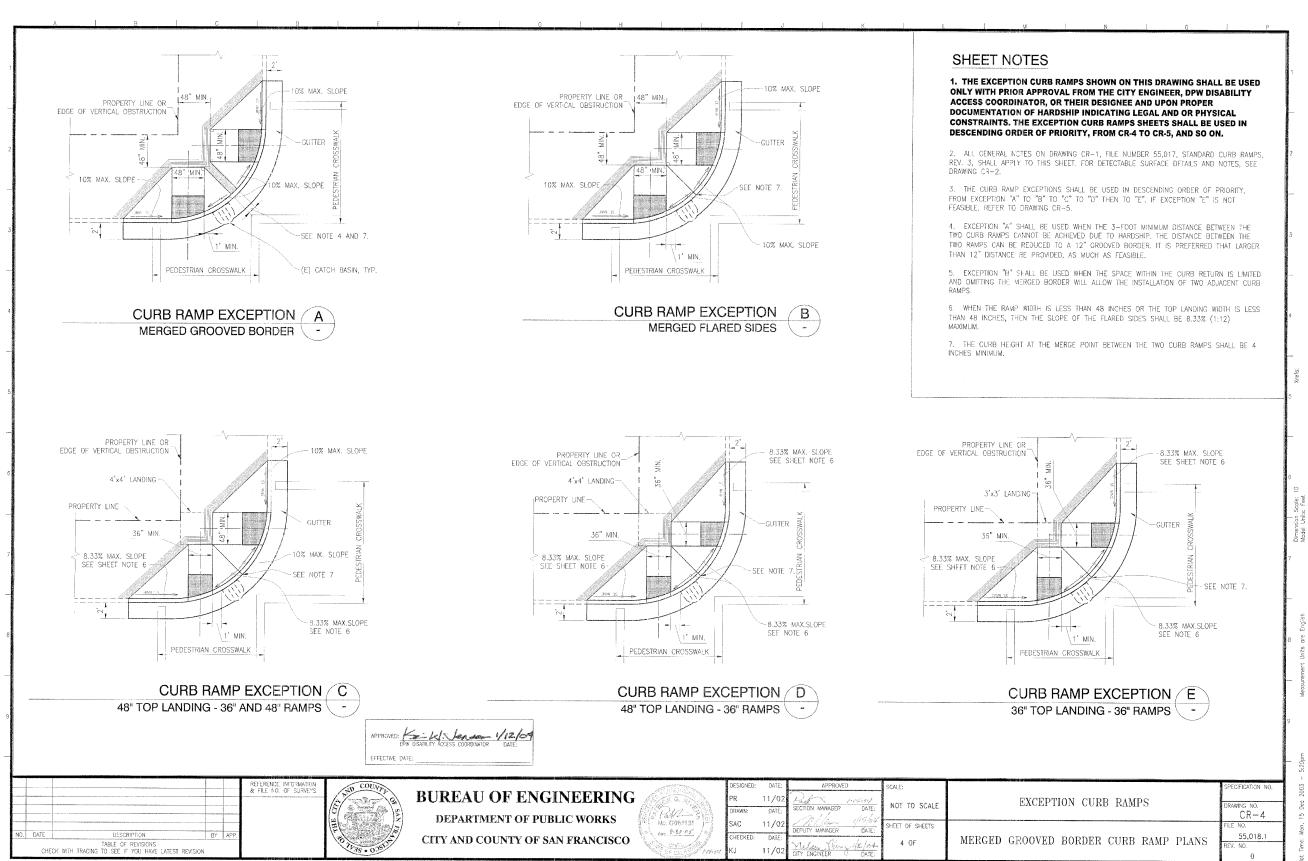
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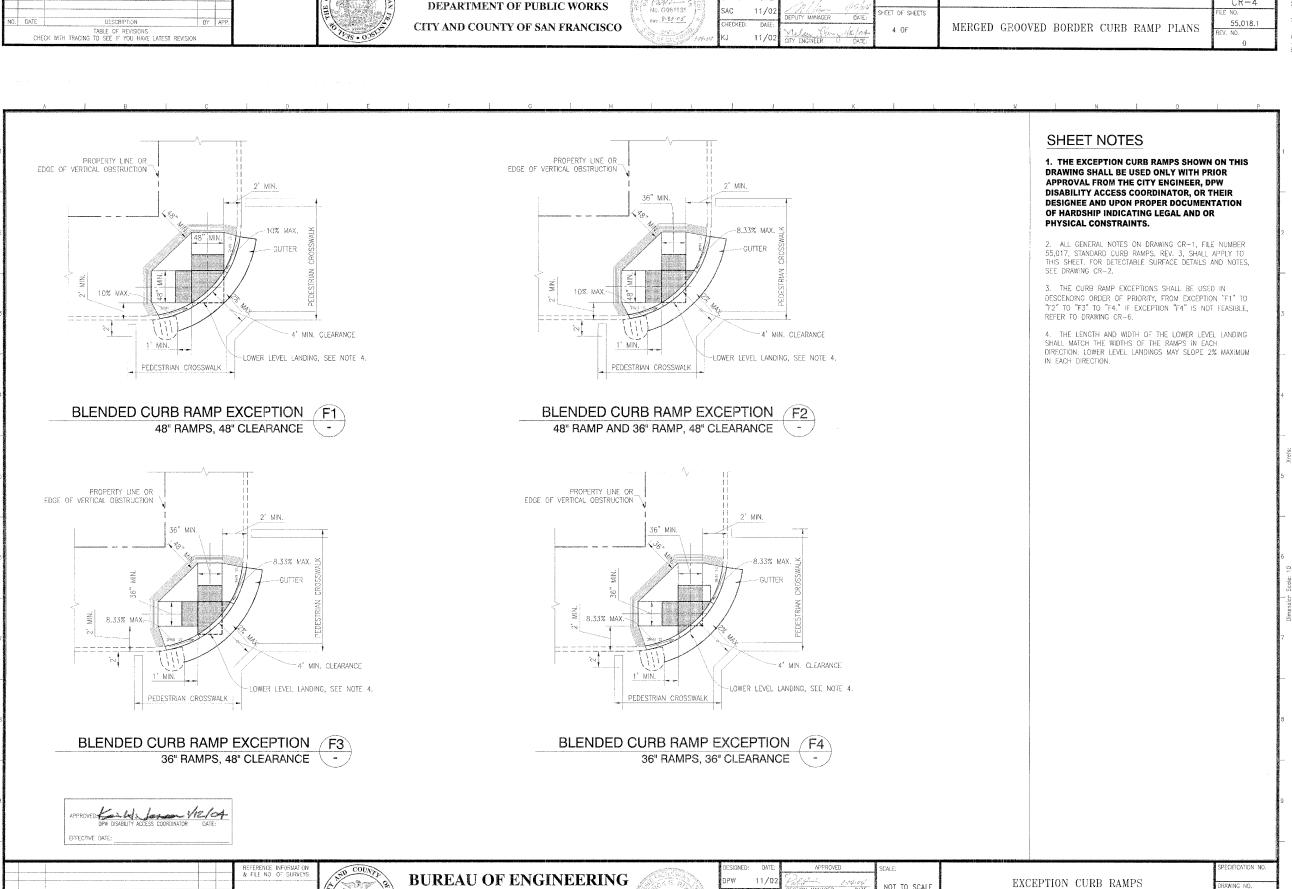
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Drawing Title **DETAILS**

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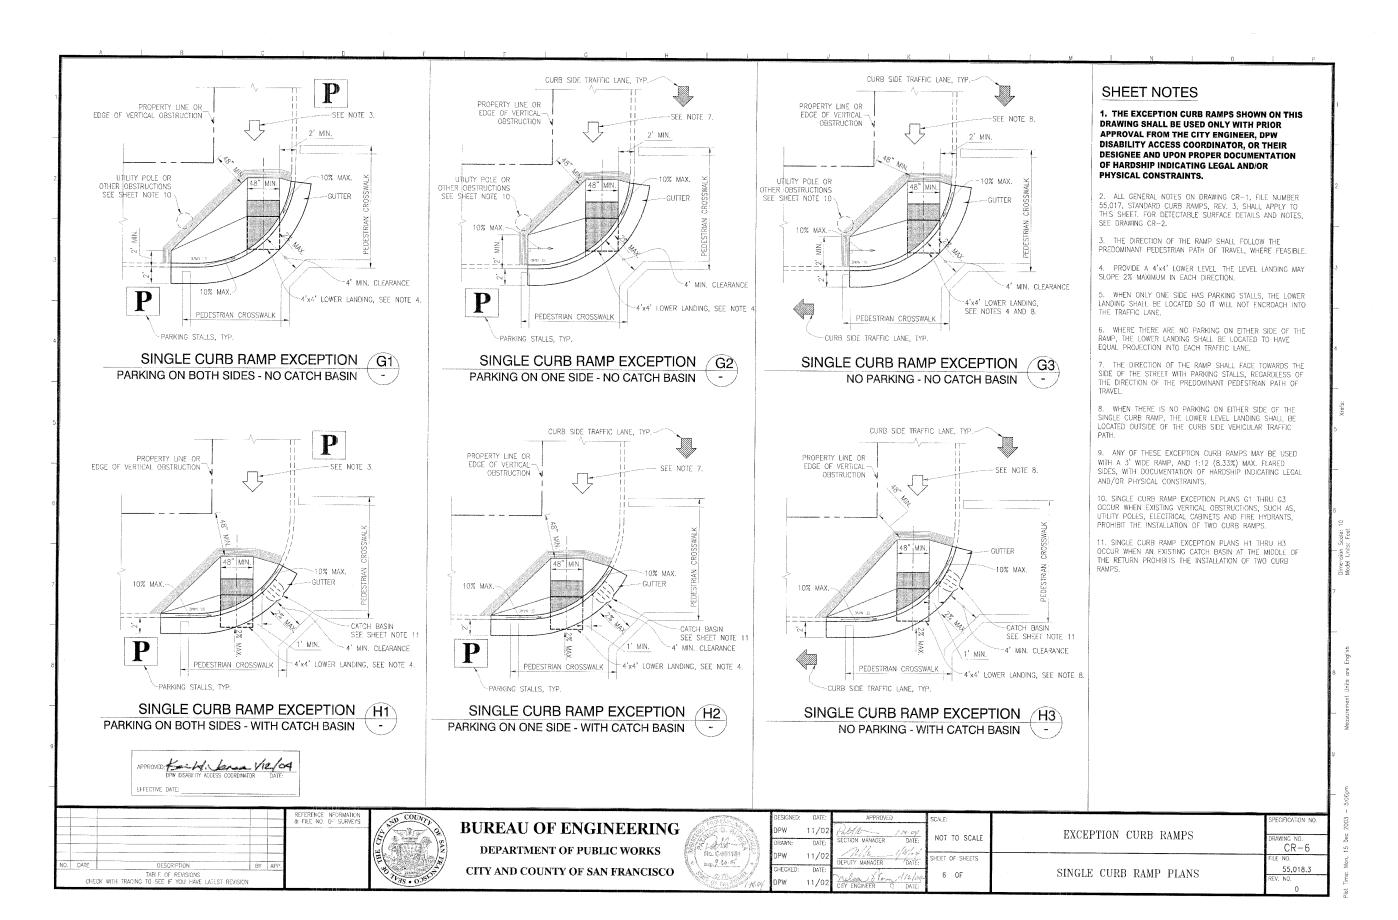






BLENDED CURB RAMP PLANS


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> > KCA JOB NO. 5550

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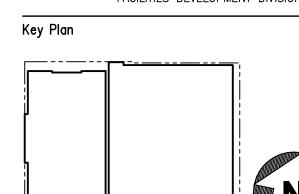
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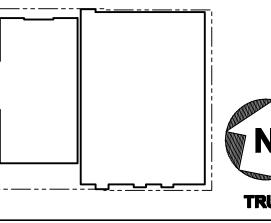
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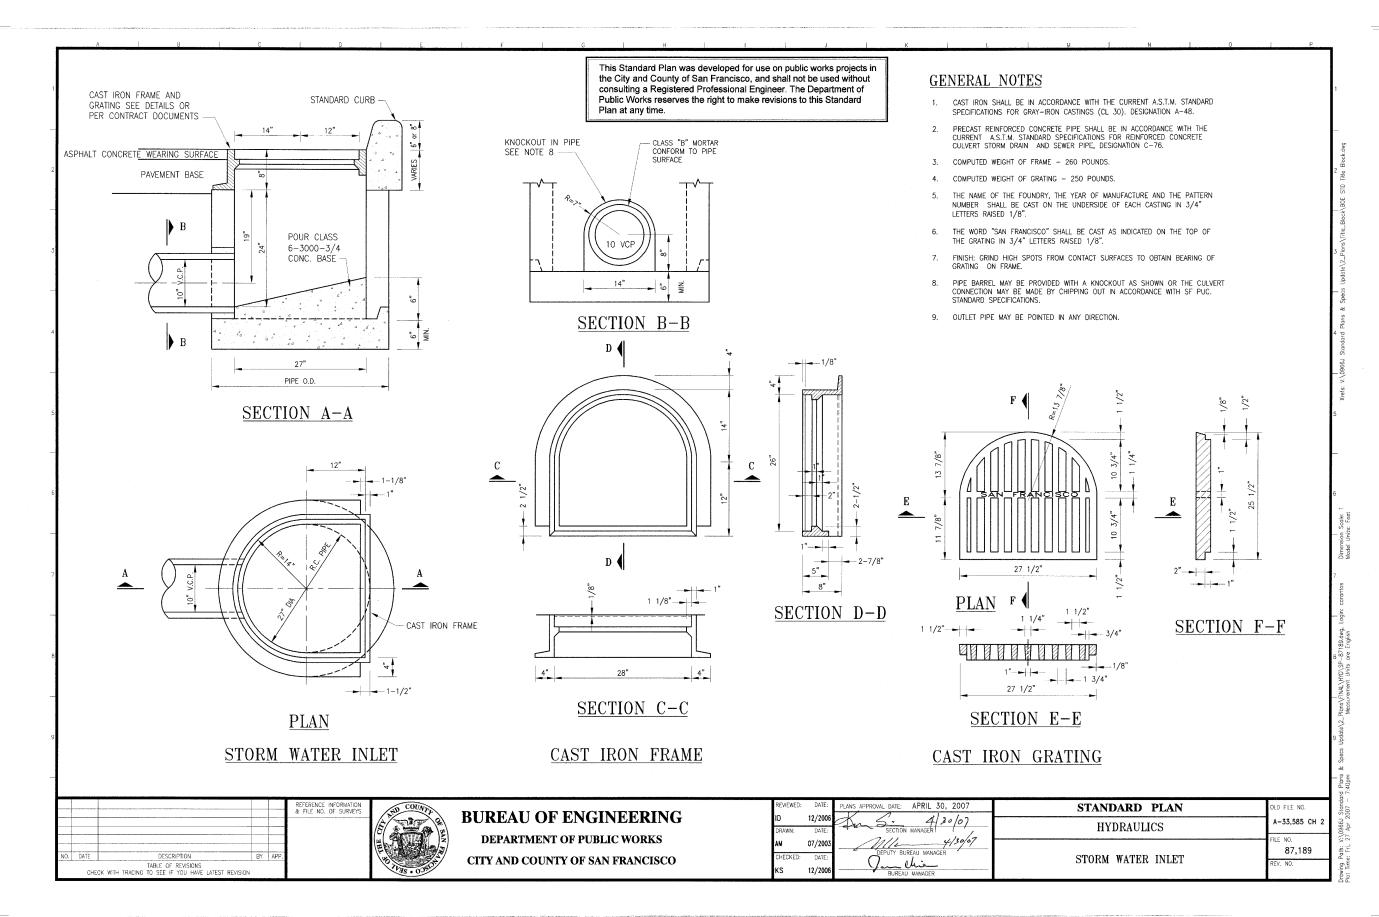
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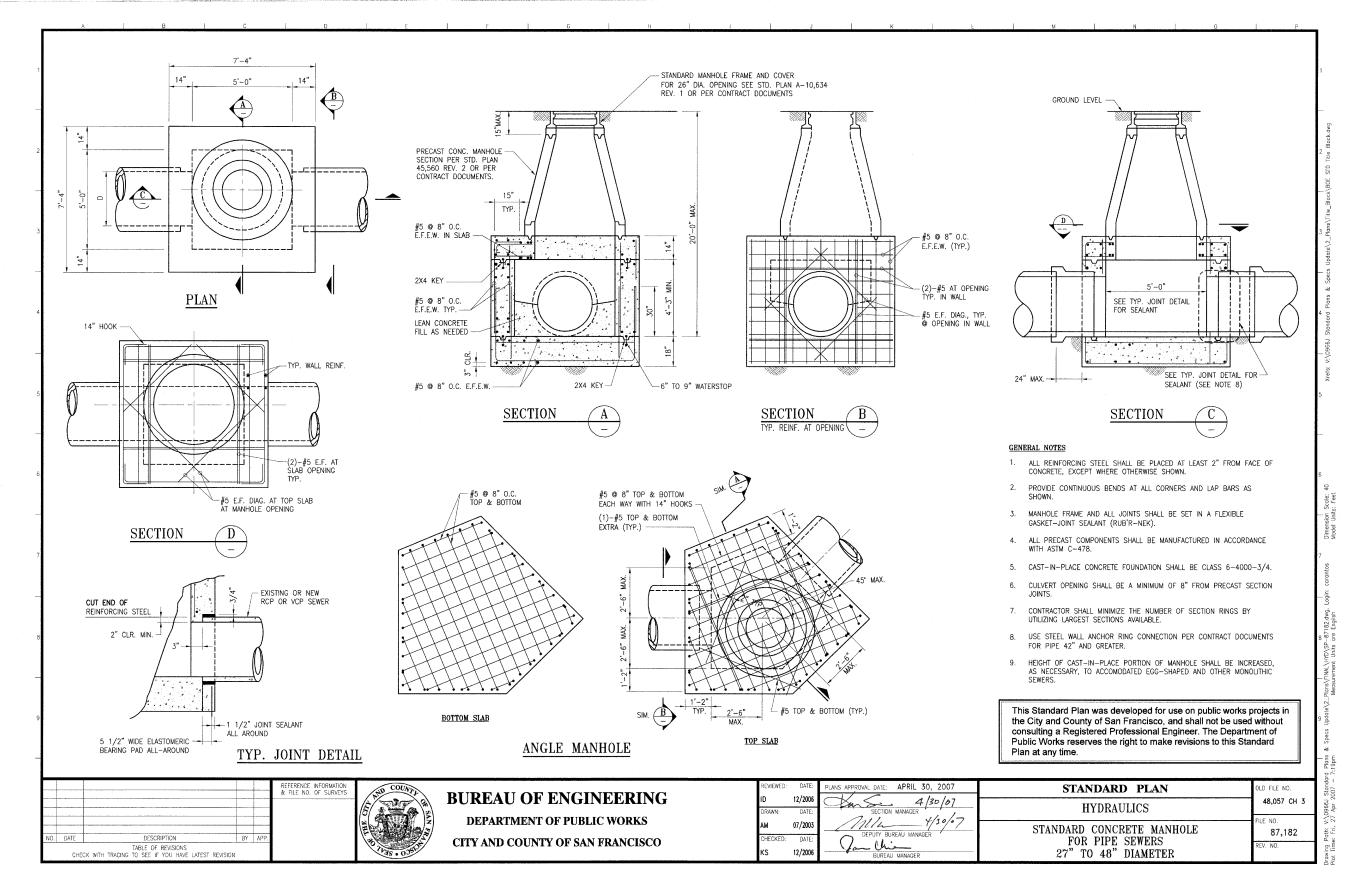


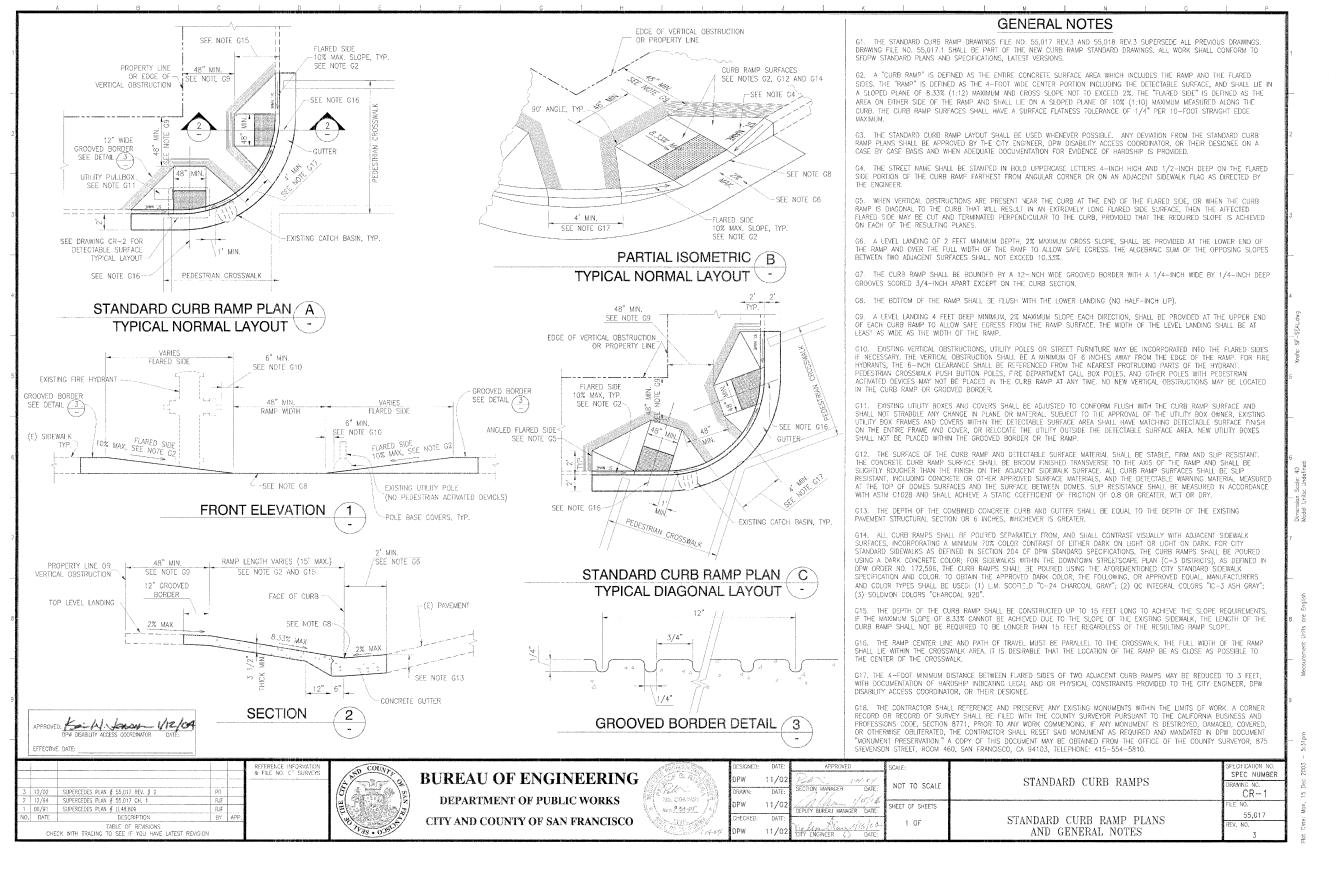



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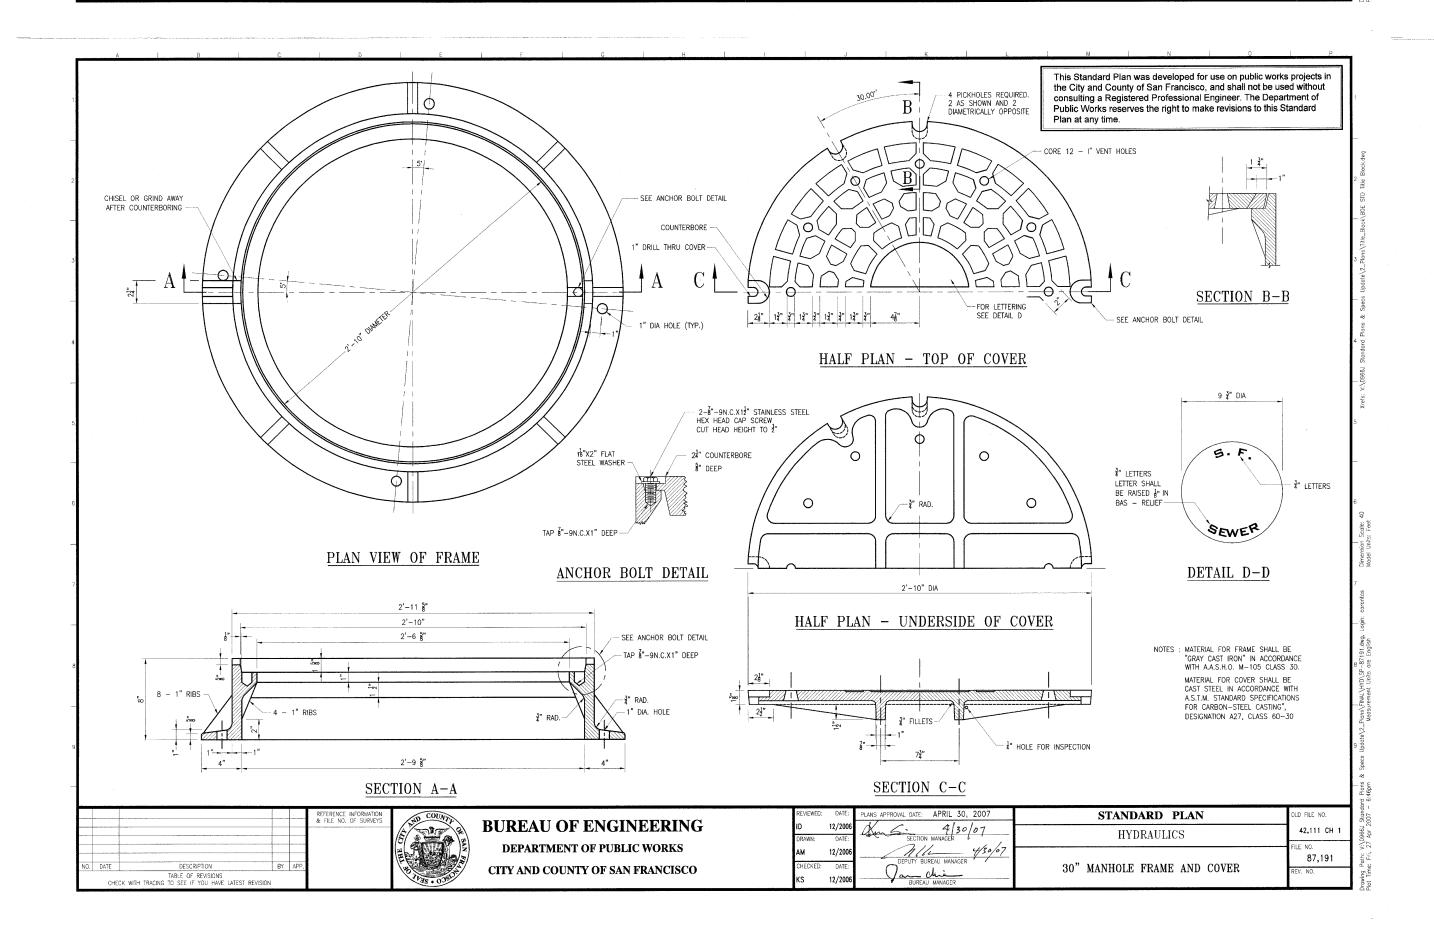
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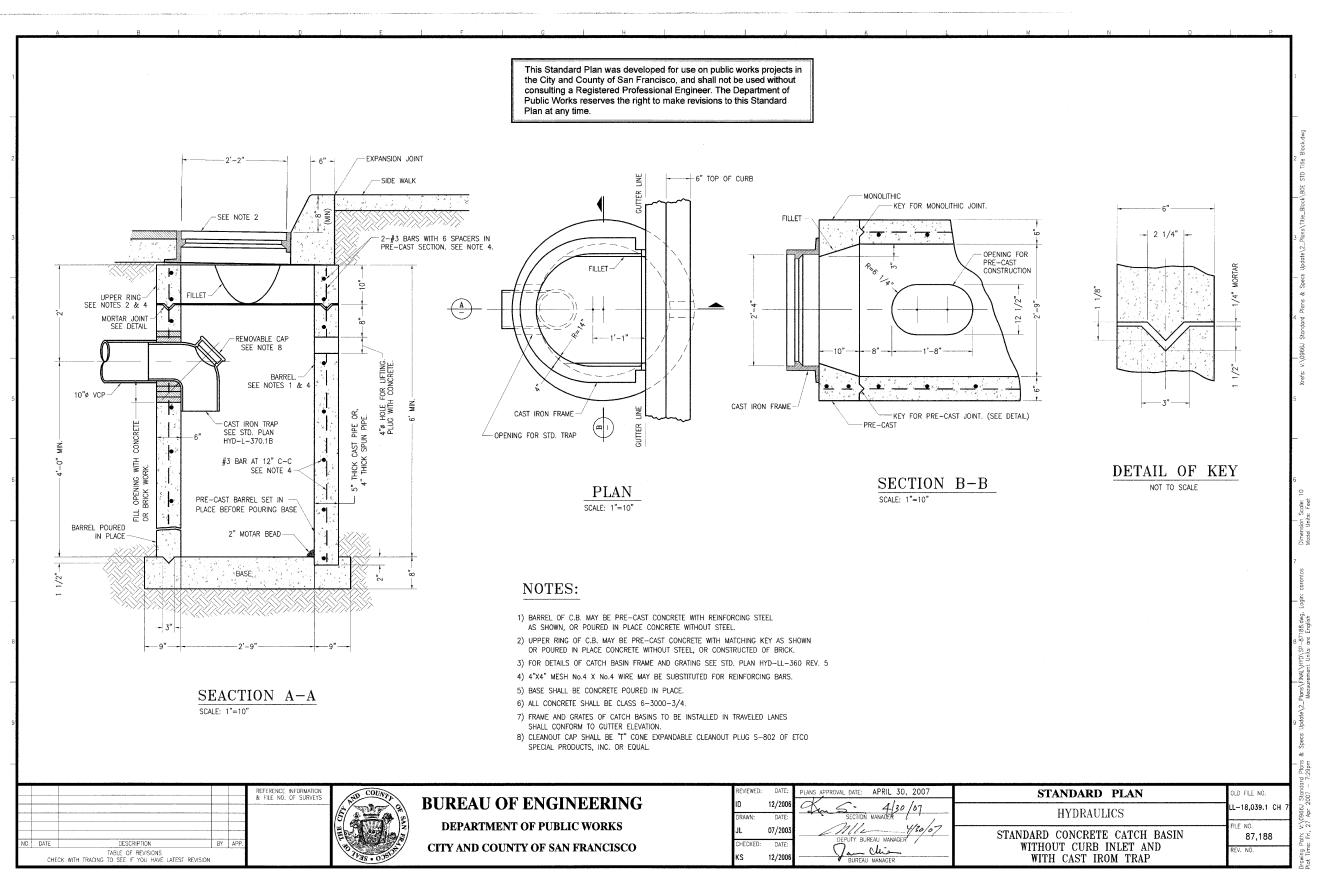


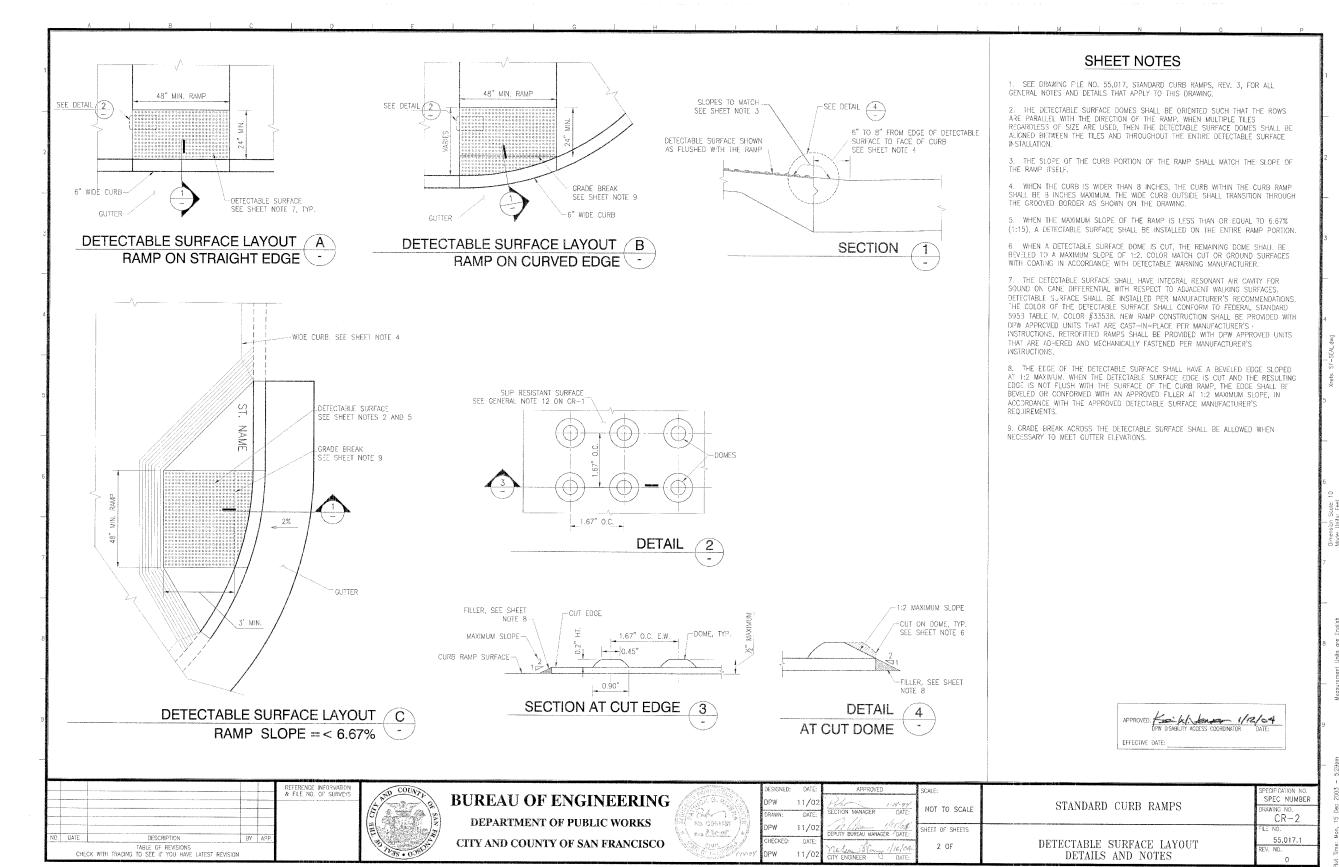

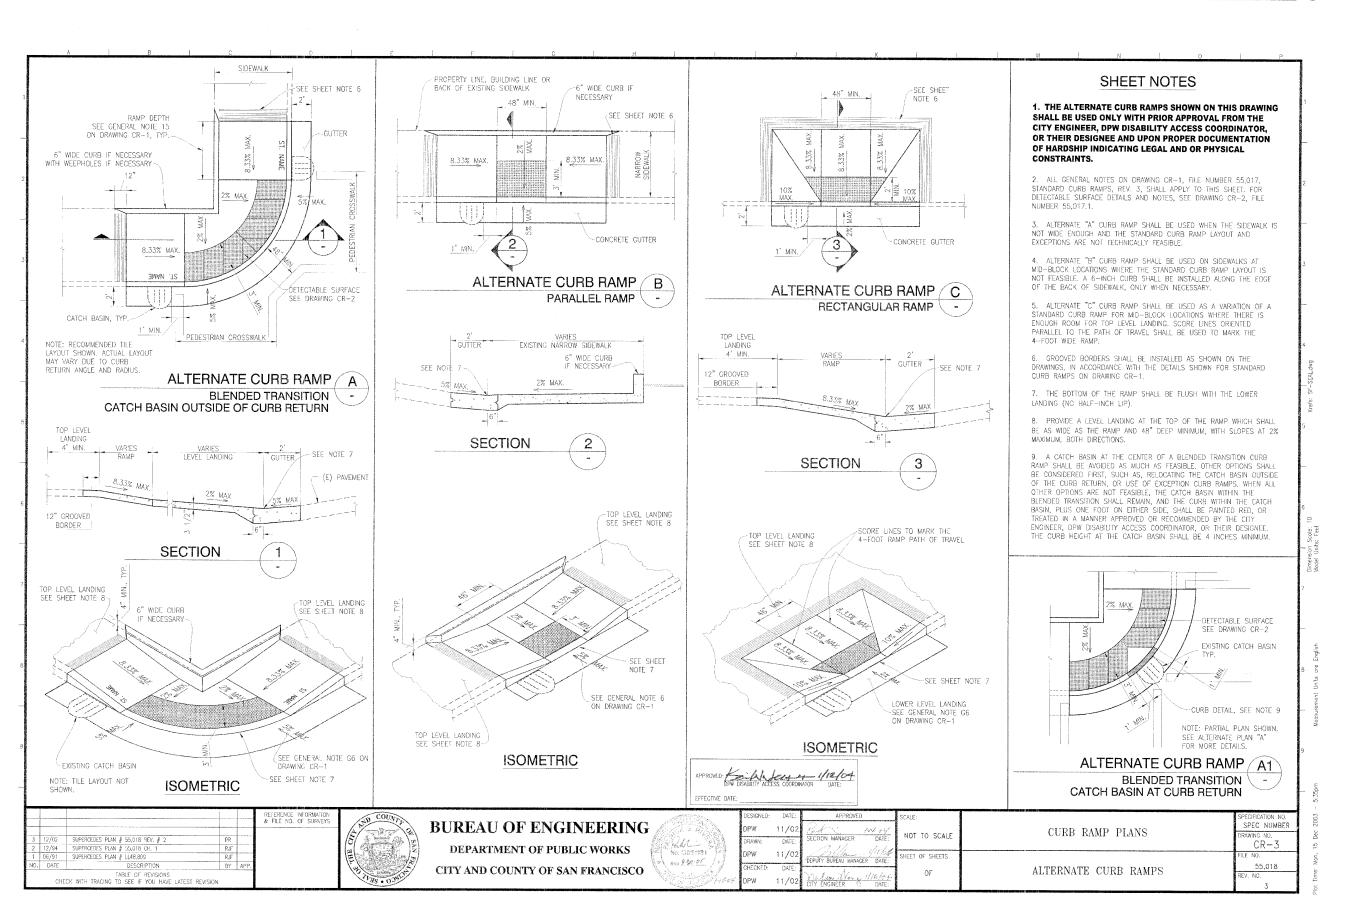



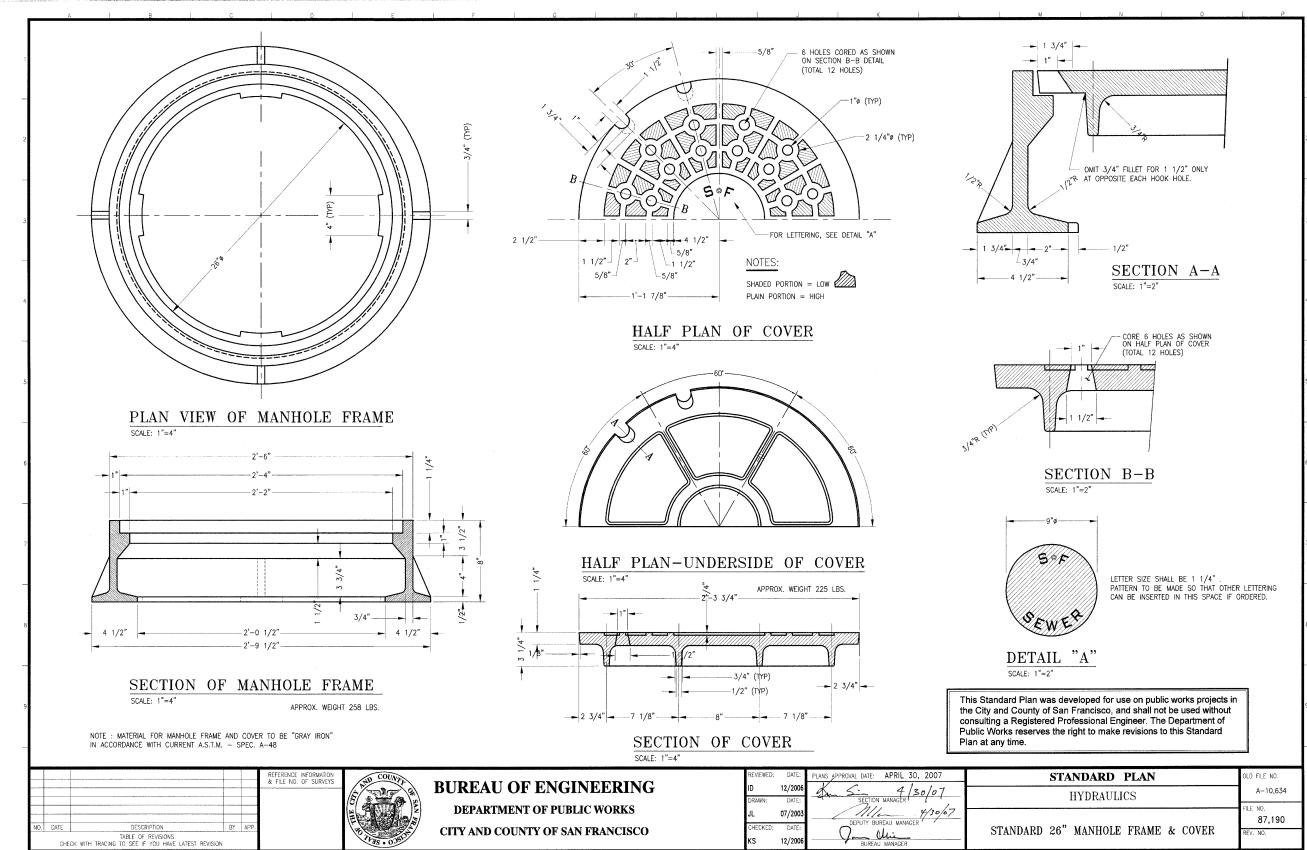

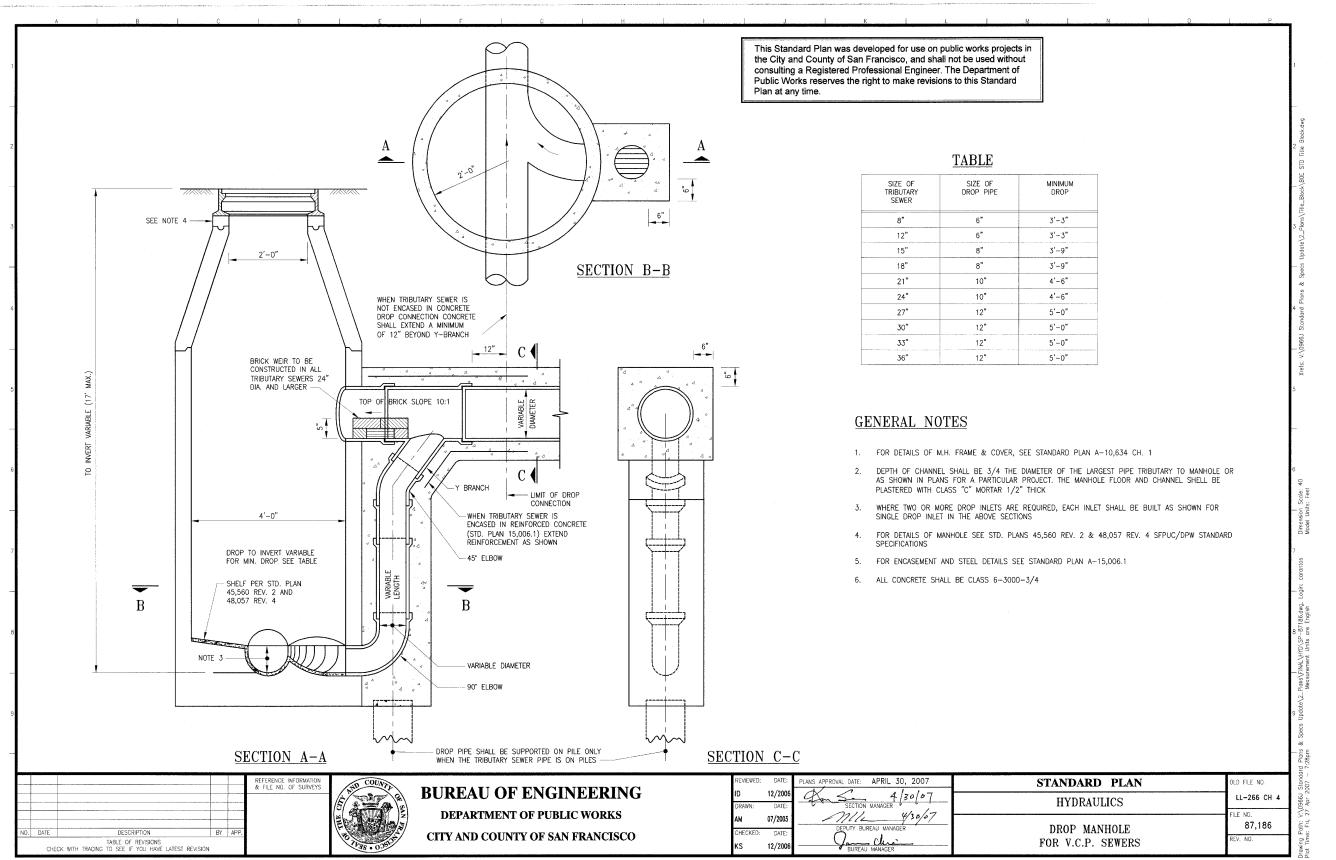



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MAZZETTI & ASSOCIATES

- F.W.ASSOCIATES, INC. - SJ ENGINEERS **OWNER CONSULTANTS:**

> **KCA ENGINEERS SURE ENGINEERS** TREADWELL & ROLLO

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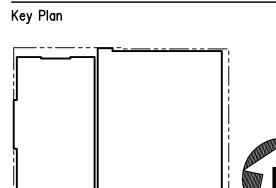
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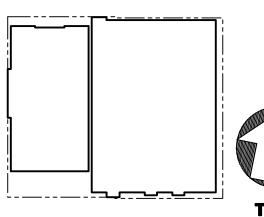
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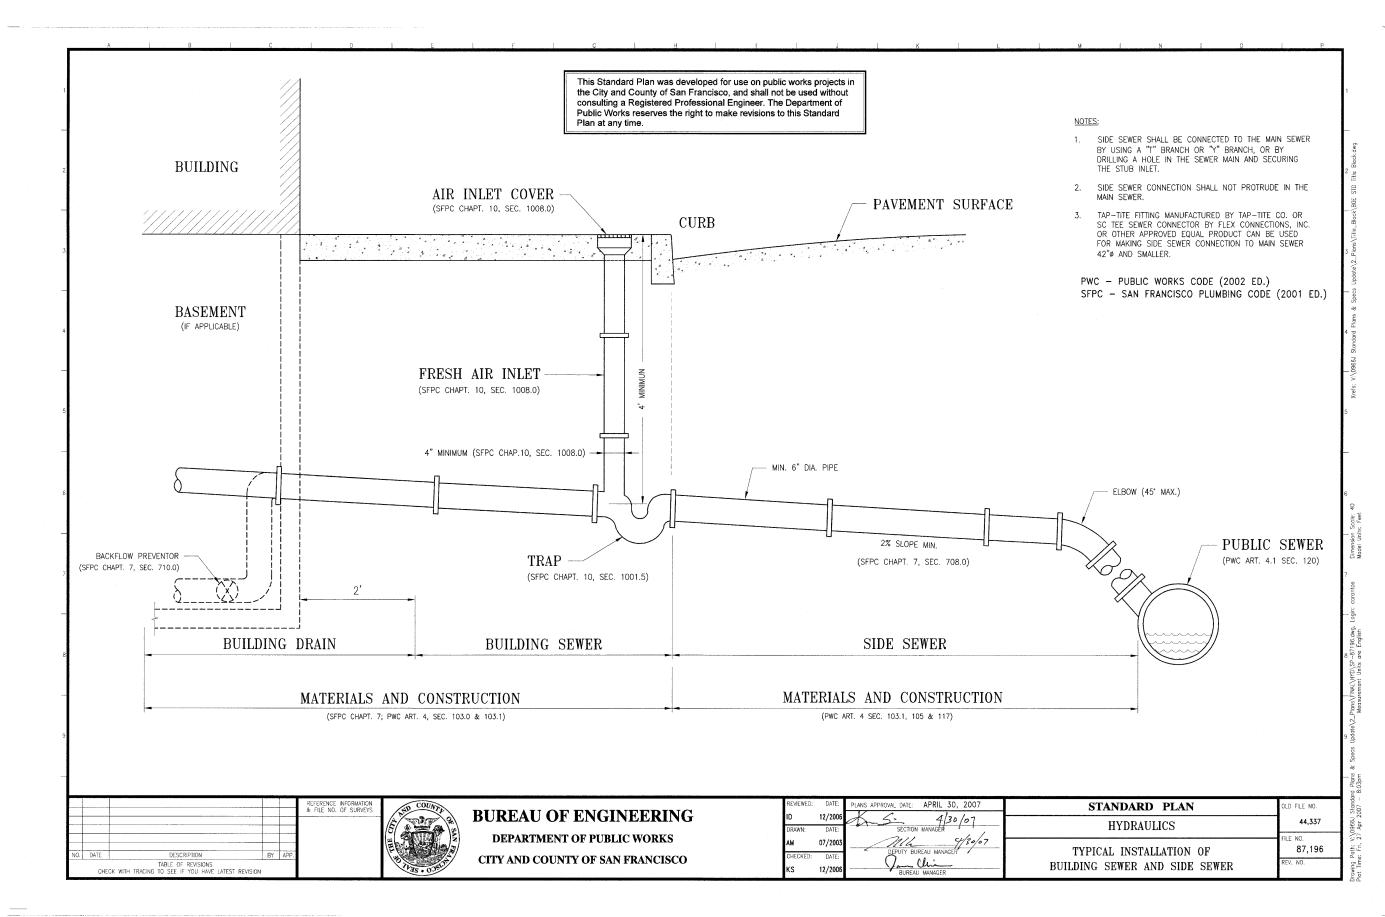






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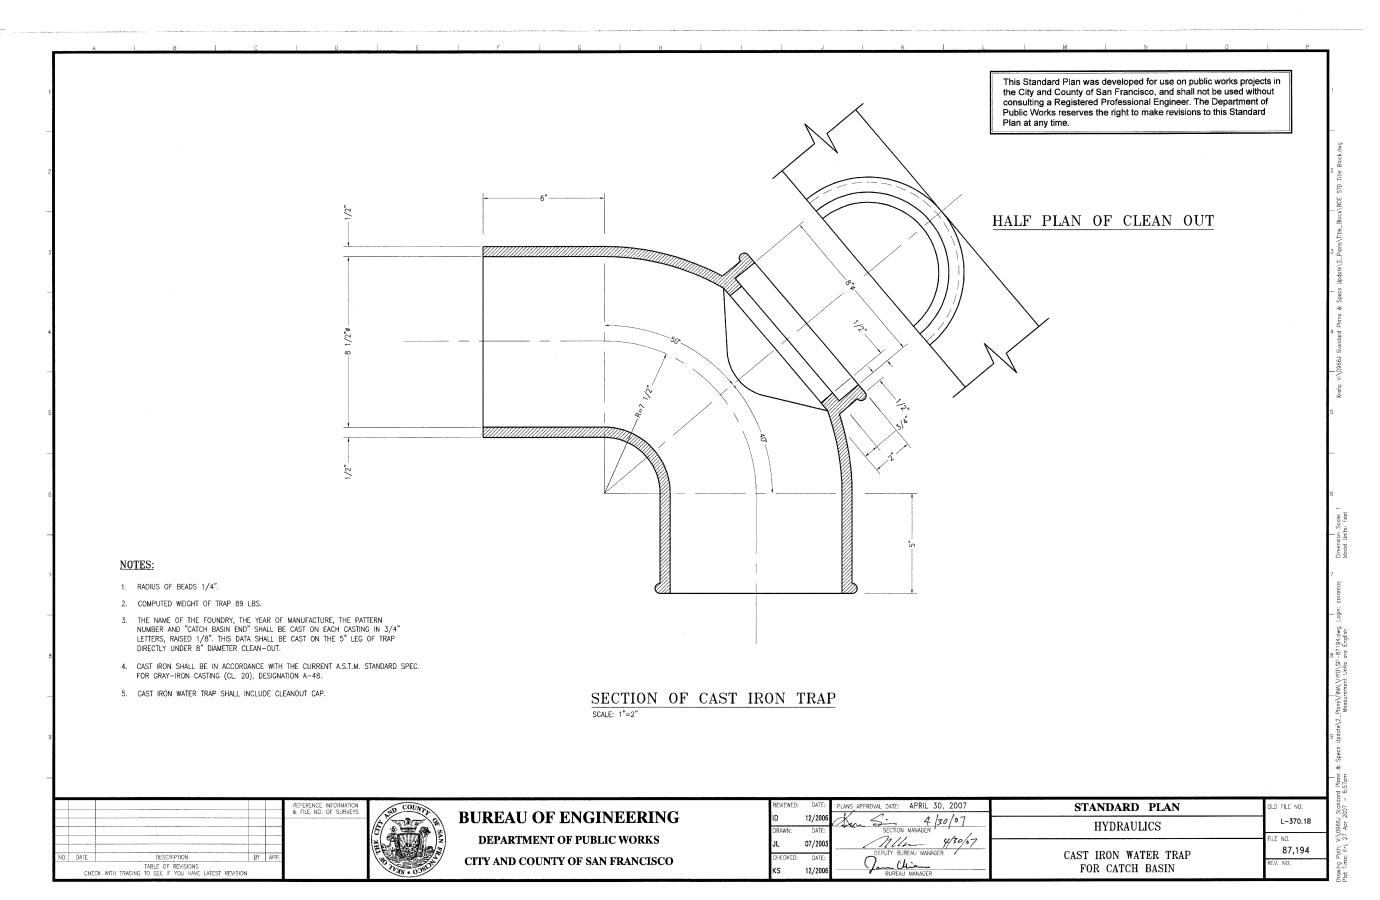
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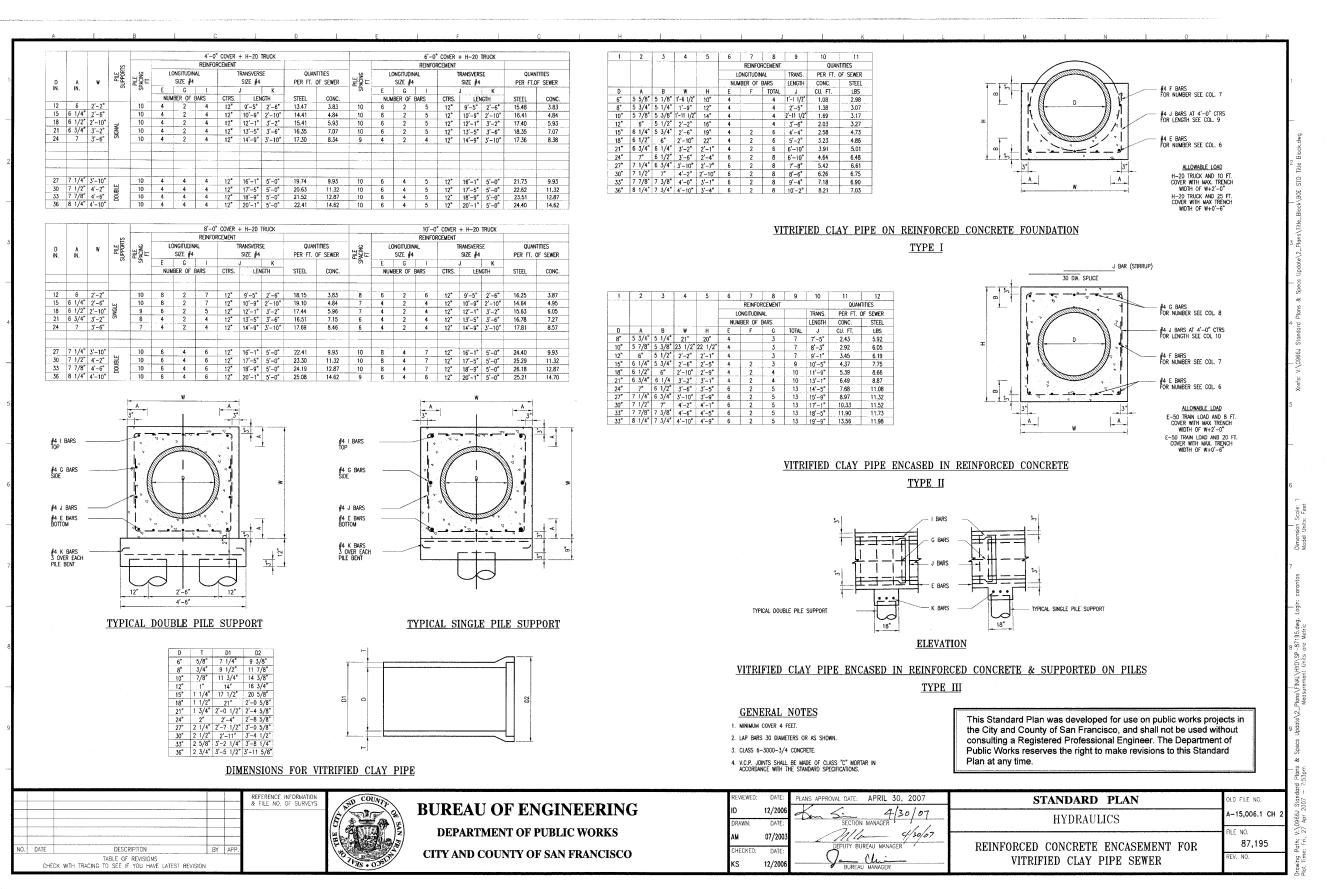
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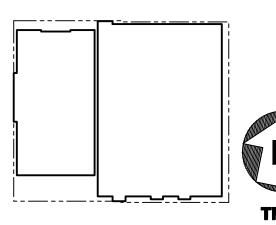
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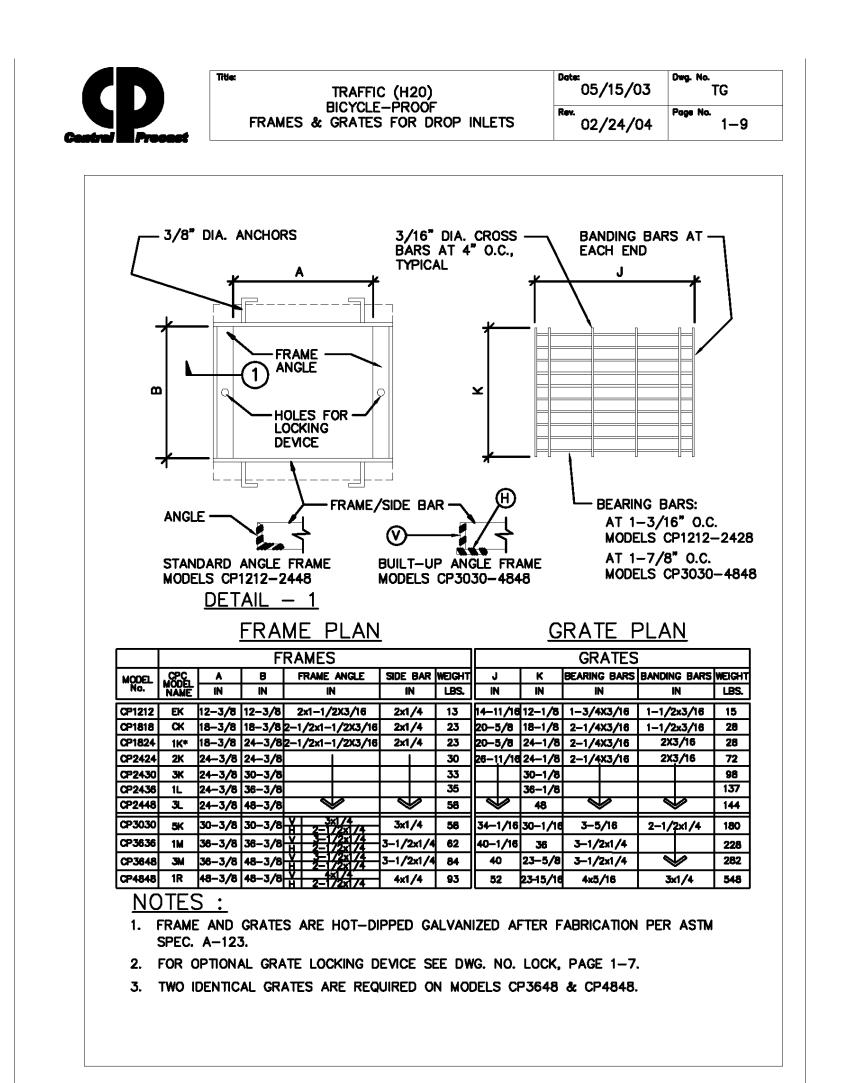
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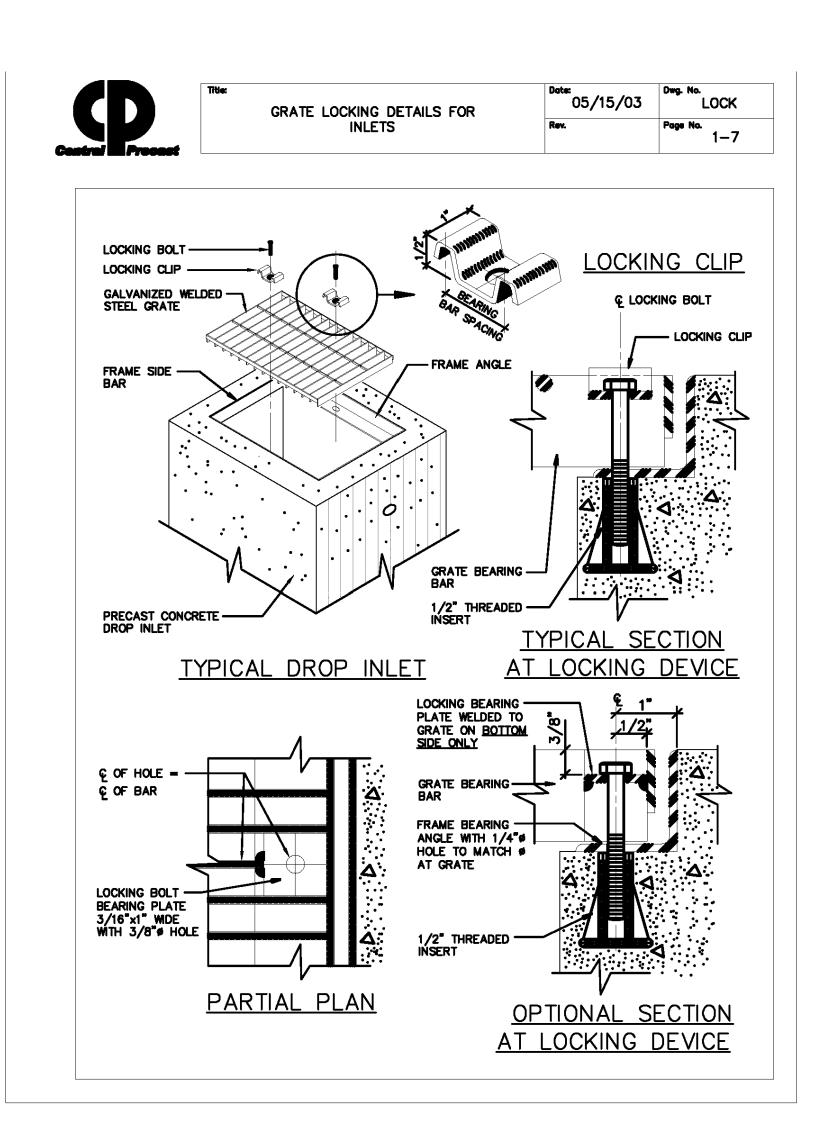
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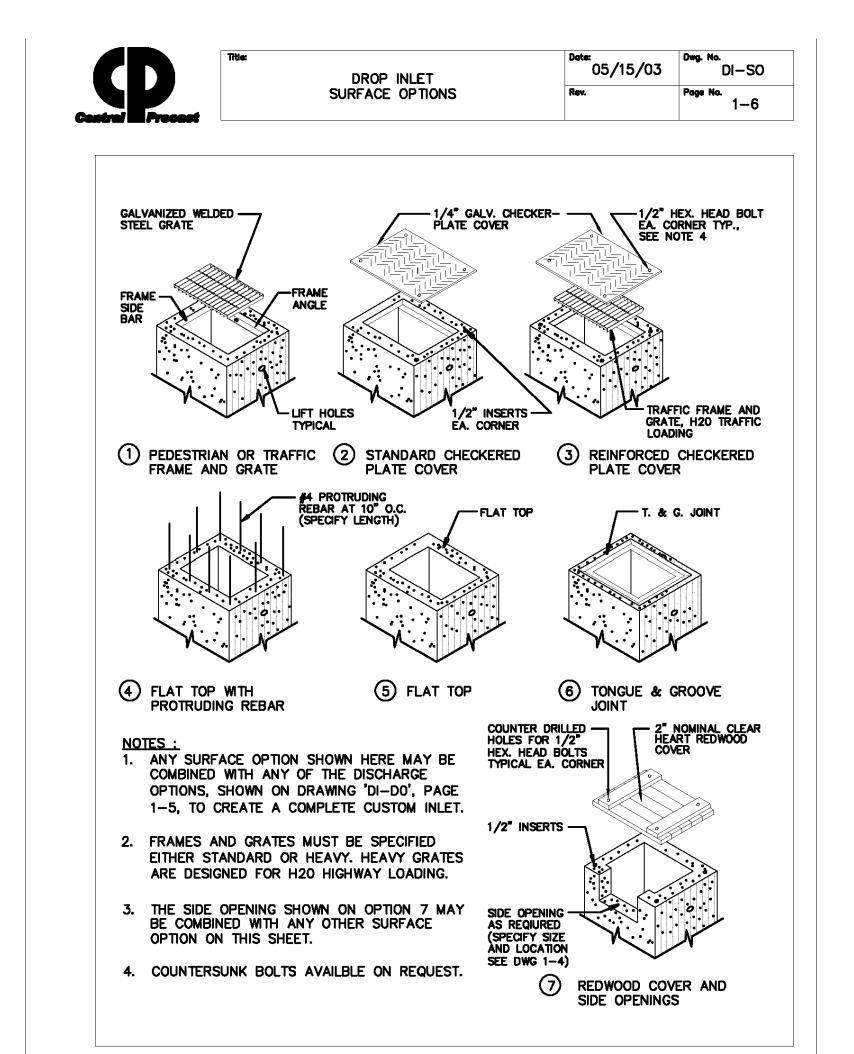



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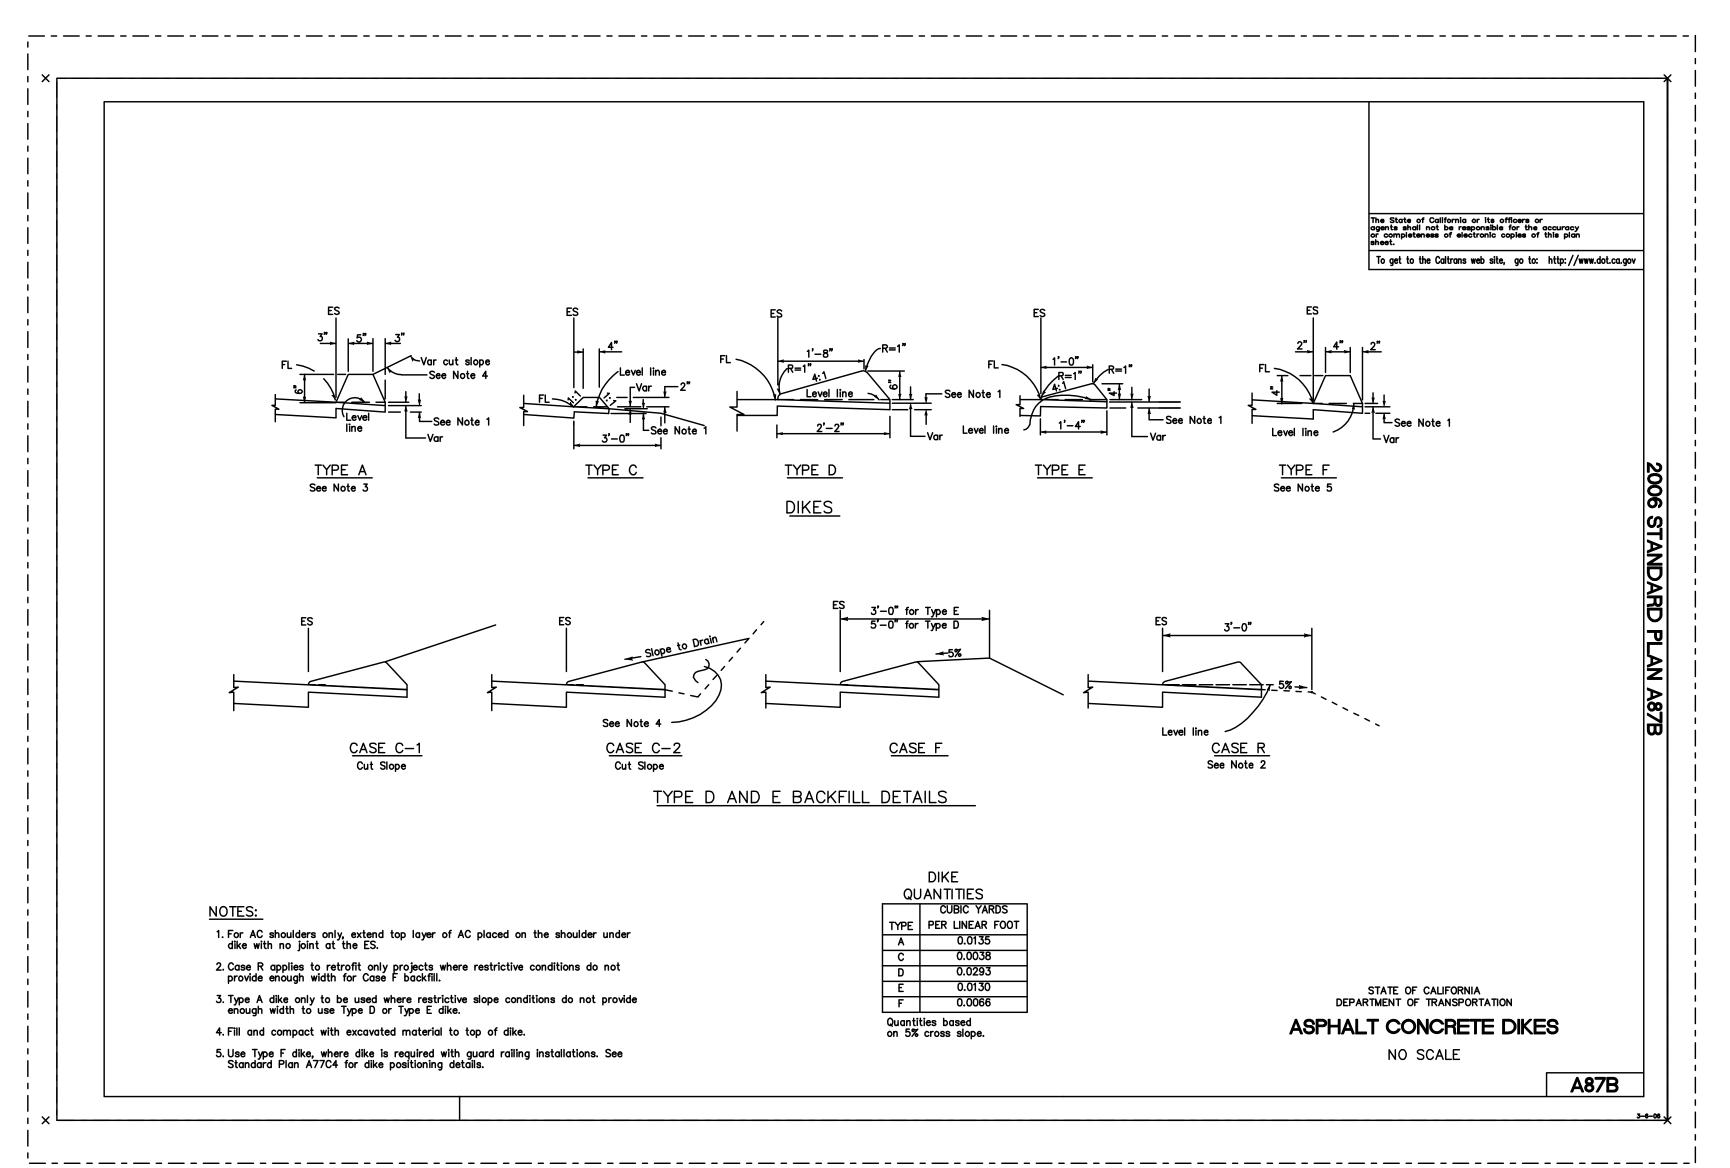
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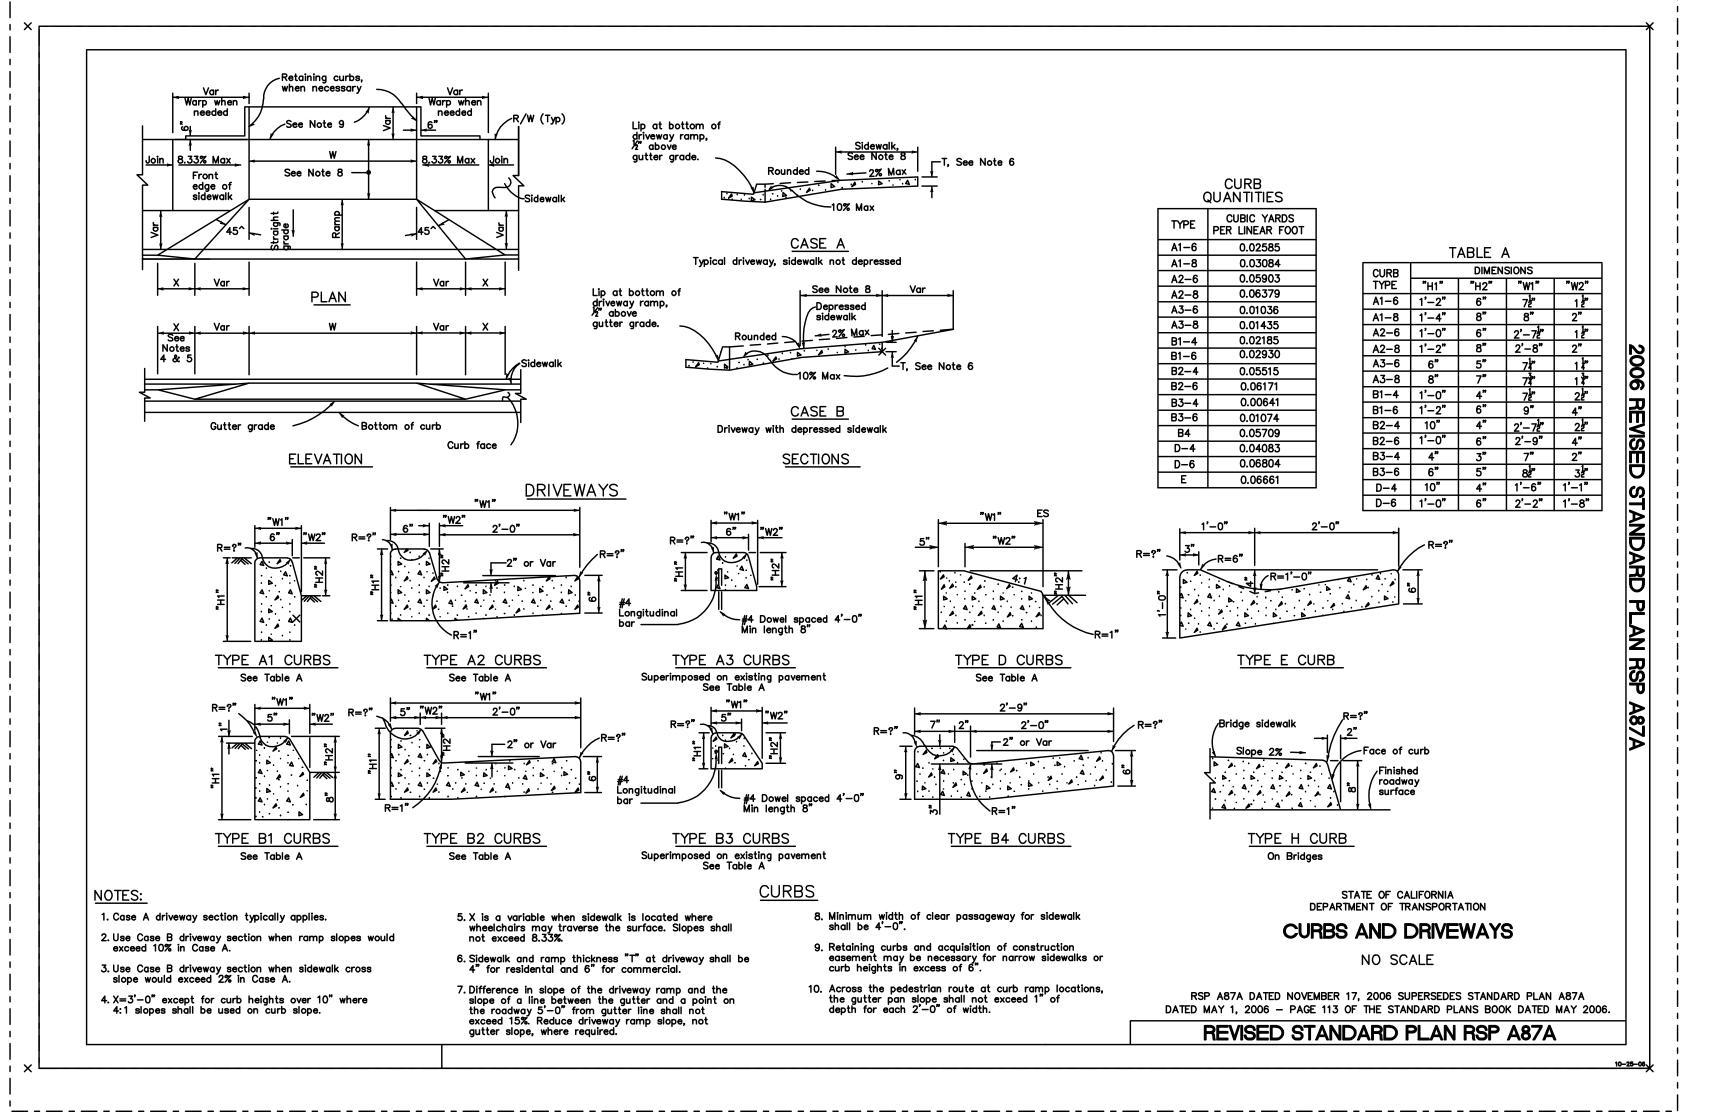






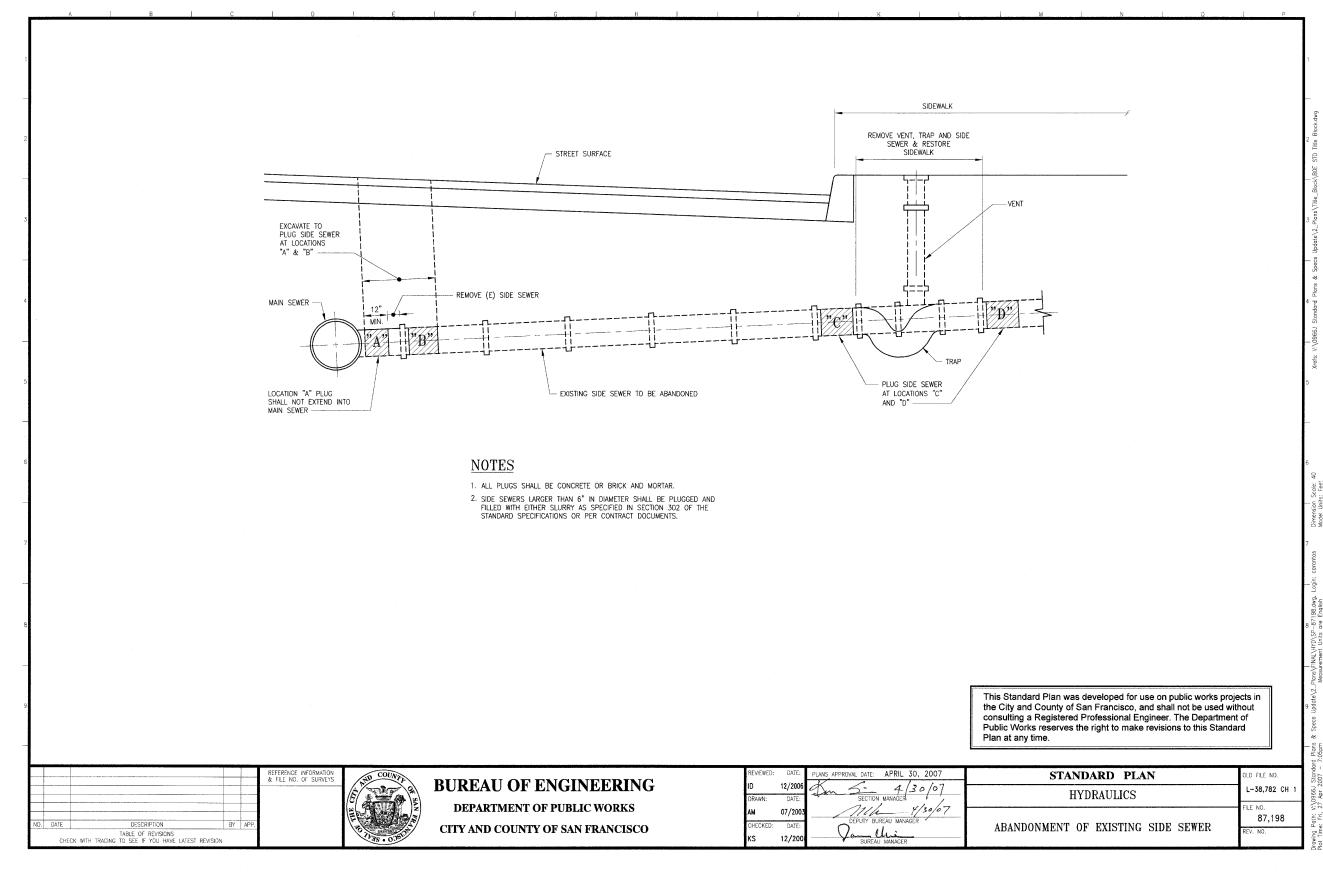

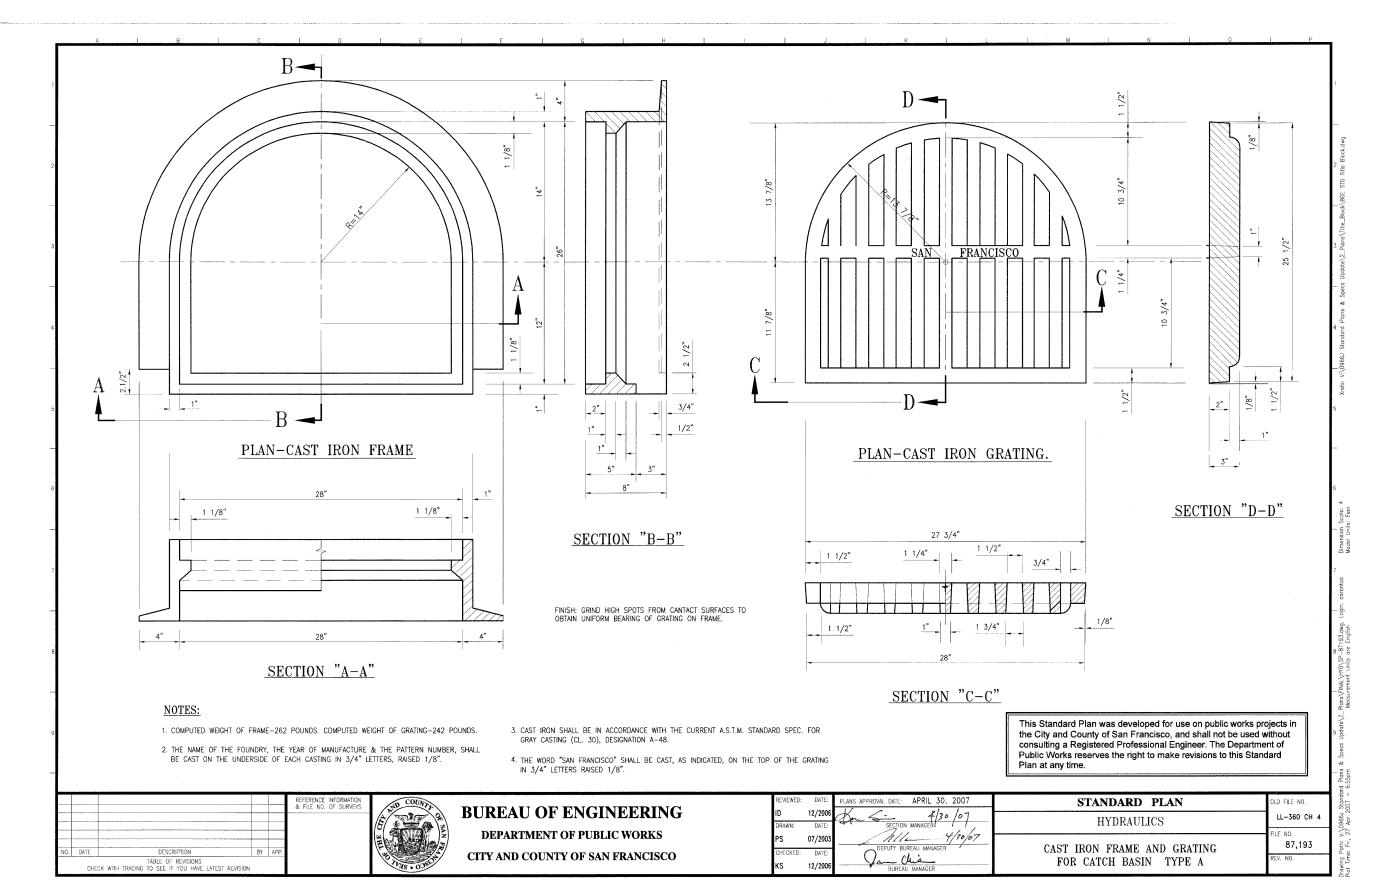

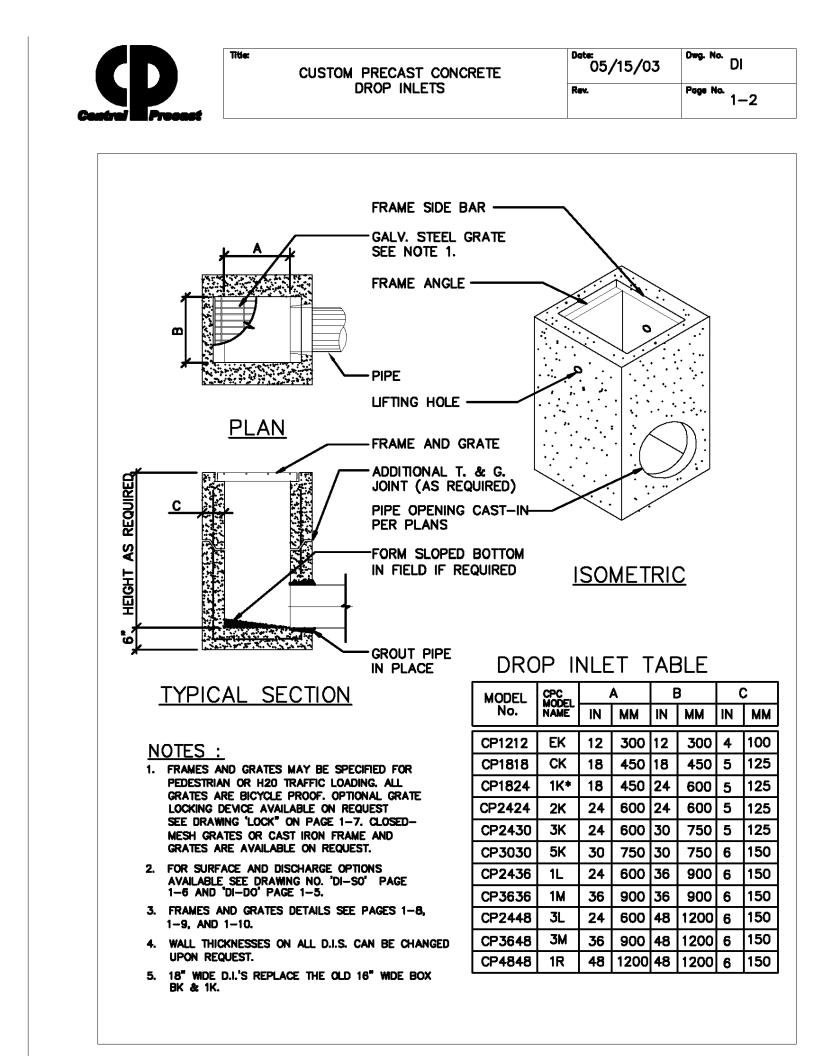



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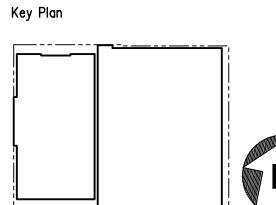
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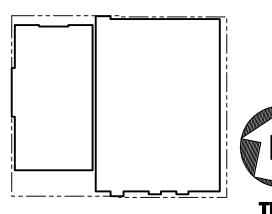
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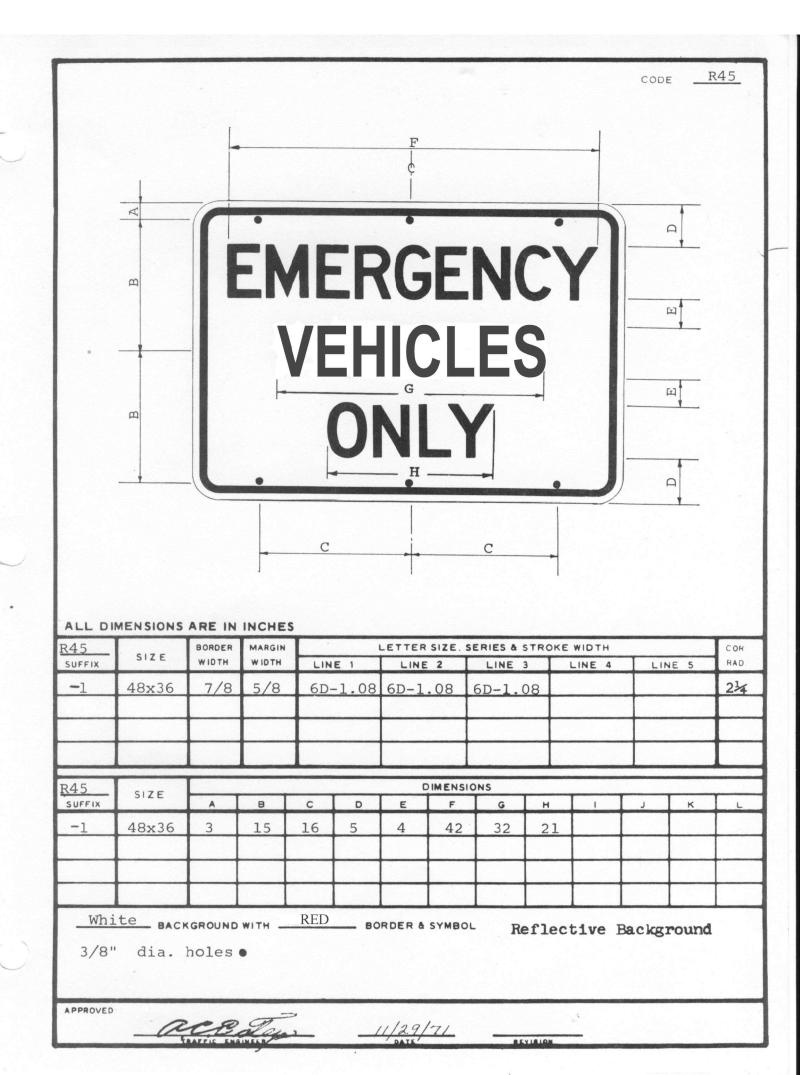
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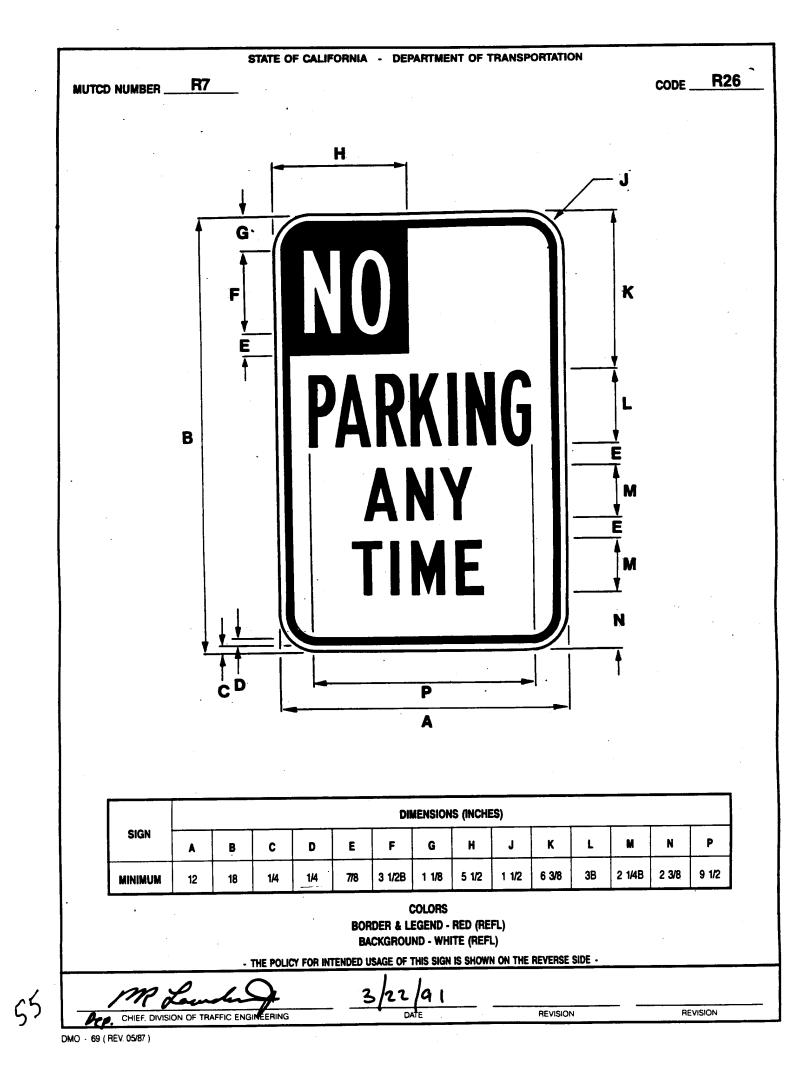


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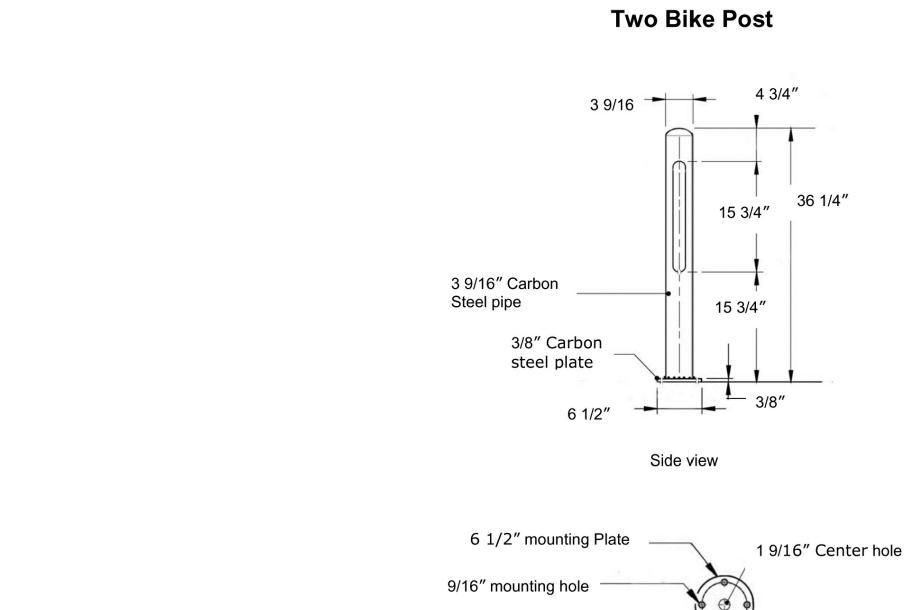


EMERGENCY VEHICLES ONLY SIGN NOT TO SCALE



NO PARKING SIGN

NOT TO SCALE



STATE OF CALIFORNIA - DEPARTMENT OF TRANSPORTATION

DIMENSIONS (INCHES)

A B C D E F G H J K L M N P

COLORS BORDER & LEGEND - RED (REFL)

BACKGROUND - WHITE (REFL)

THE POLICY FOR INTENDED USAGE OF THIS SIGN IS SHOWN ON THE REVERSE

NO SMOKING SIGN

NOT TO SCALE

12 18 1/4 1/4 7/78 3 1/2B 1 1/8 5 1/2 1 1/2 6 3/8 3B 2 1/4B 2 3/8 9 1/2

5 1/8" Bolt circle

Bottom Plate view


2 of 2

MUTCD NUMBER _____R7

CODE R26

Specification Sheet

Two Bike Post 05JA1372

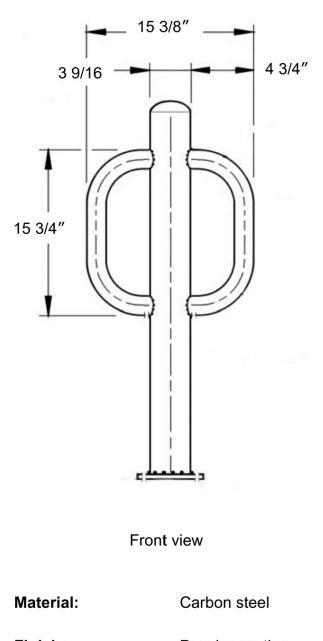

Powder coating


1 of 2

BIKE POST

NOT TO SCALE


TRENCH PAVEMENT RESTORATION NOTES: (SIMILAR TO CCSF STD. DRAWING 45,612 CH2) 1. THE EXISTING PAVEMENT SHALL BE SAW CUT.


- 2. THE BASE SHALL BE 8" PORTLAND CEMENT CONCRETE.
- THE TRENCH WIDTH SHALL NOT EXCEED THE OUTSIDE DIAMETER OF THE PIPE PLUS THREE FEET NOR THE OUTSIDE WIDTH OF THE STRUCTURE PLUS THREE FEET.
- 4. THE TRENCH PAVEMENT WIDTH FOR RESTORATION SHALL BE THE TRENCH WIDTH PLUS TWO FEET.

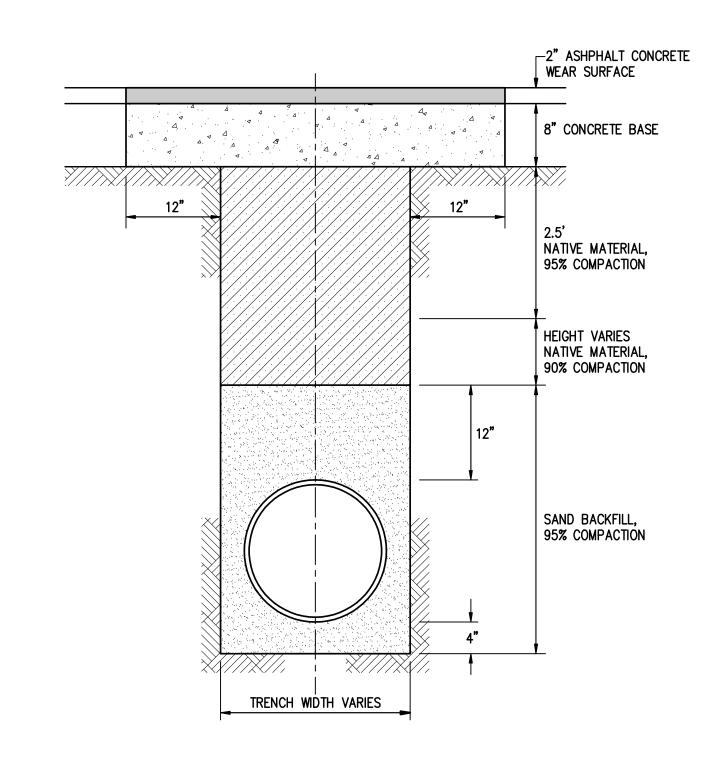

TRENCH & PAVEMENT RESTORATION DETAIL

NOT TO SCALE

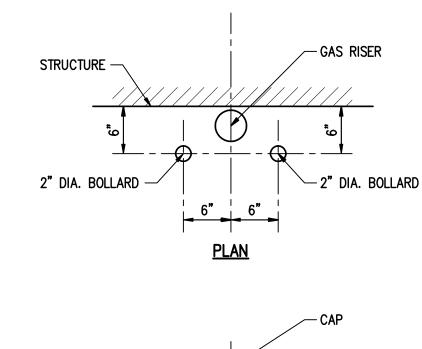

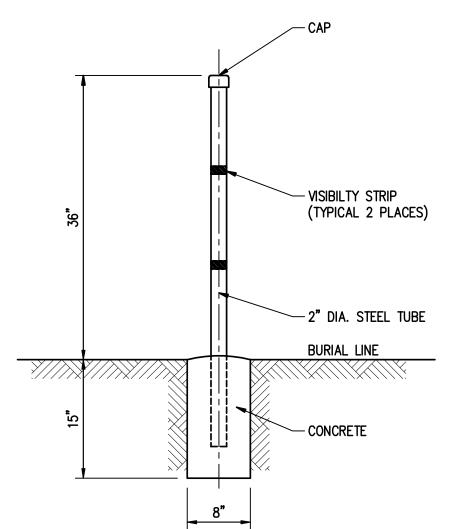

P.G. & E. METER GUARD NOT TO SCALE

COMPRESSED GAS SIGN

NOT TO SCALE

COMPRESSED

GAS

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CHINESE

845 JACKSON STREET SAN FRANCISCO, CA

OSHPD # IS-072017

Facility Number 14621

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Phone: 214.424.7500

MAZZETTI & ASSOCIATES

- F.W.ASSOCIATES, INC. - SJ ENGINEERS

OWNER CONSULTANTS:

TREADWELL & ROLLO

BID SET 07-23-12

KCA ENGINEERS SURE ENGINEERS

Suite 400, MB13 Dallas, TX 75206

CONSULTANTS:

ARUP

NEW ACUTE CARE

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ADDED DETAIL SHEET CITY RESUBMITTAL OSHPD RESUBMITTAL 02.04.13 FOR REVIEW OSHPD/CCSF RESUBMITTAL

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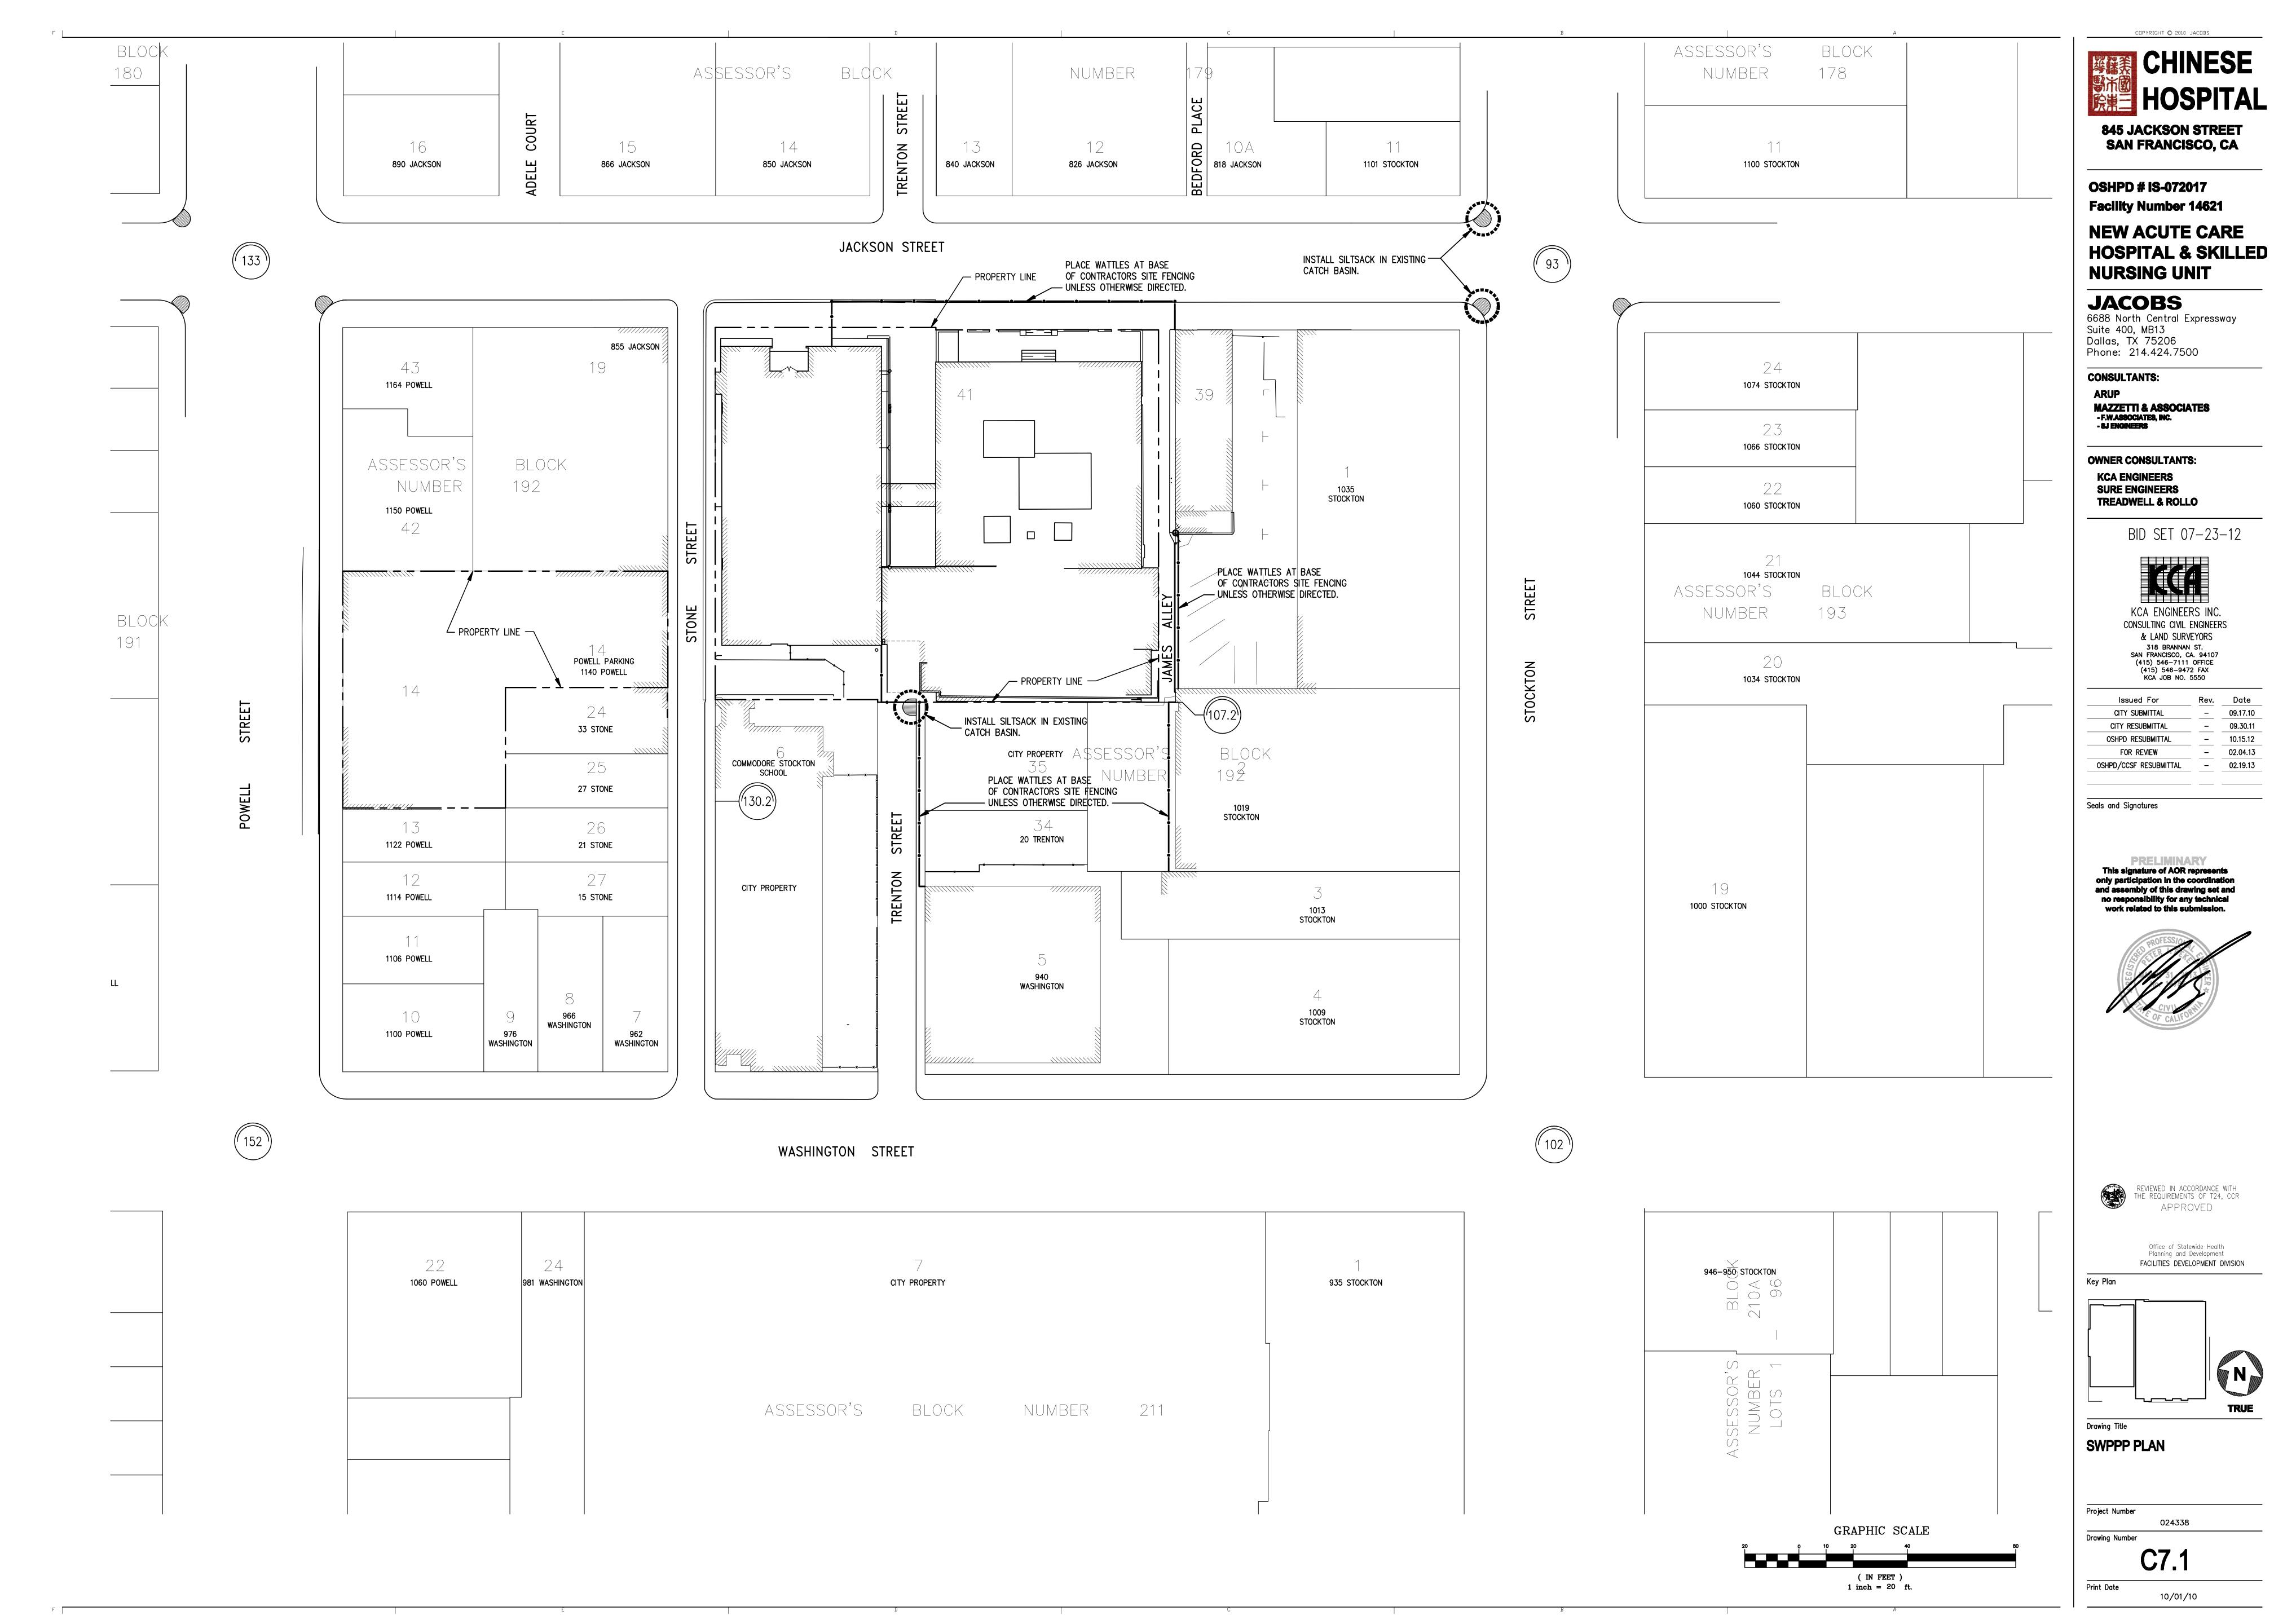





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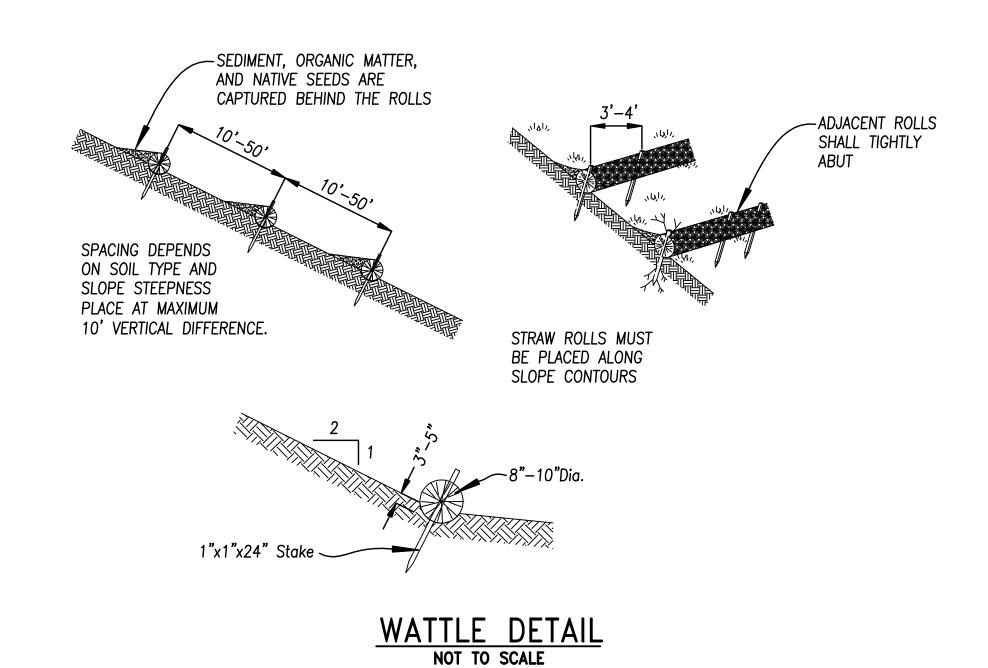






Bales shall be placed in a row with ends tightly abutting.


- 2. The dike shall be inspected after each storm, and repair or replacement shall be made promptly as required.
- Bales shall be removed when they have served their purpose so as not to block or impede storm flow or drainage.

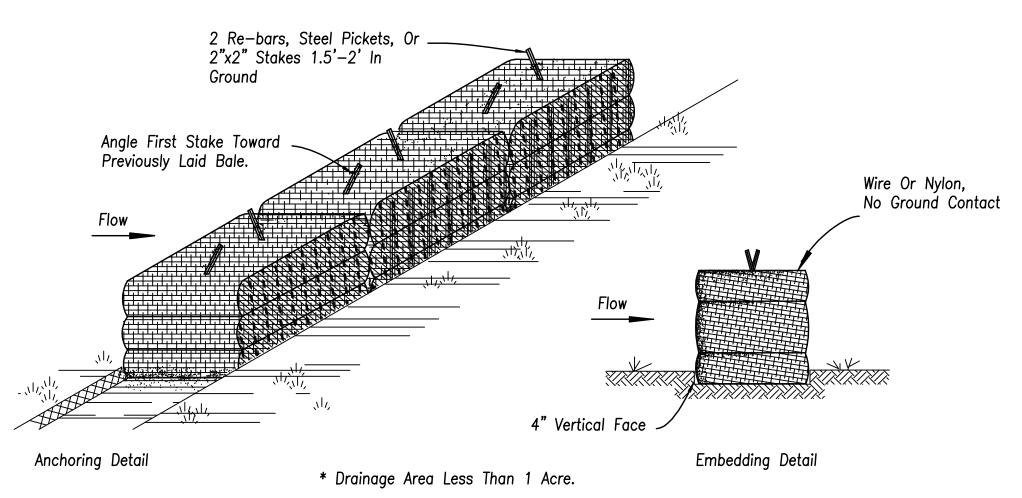STRAW BALE DIKE DETAIL NOT TO SCALE



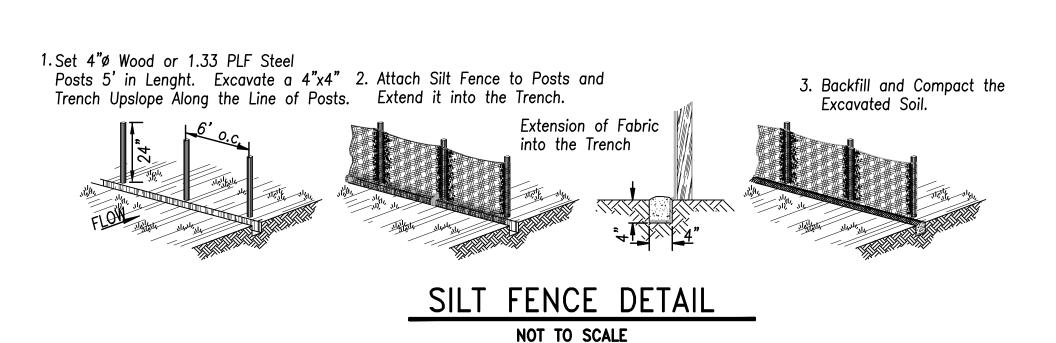

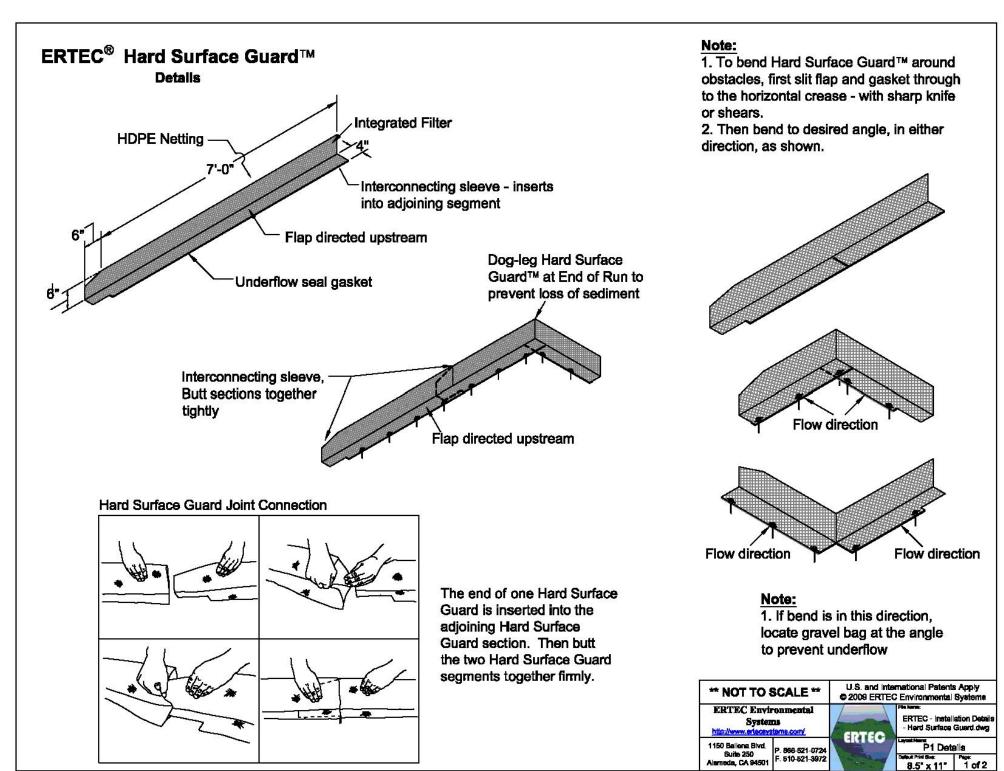

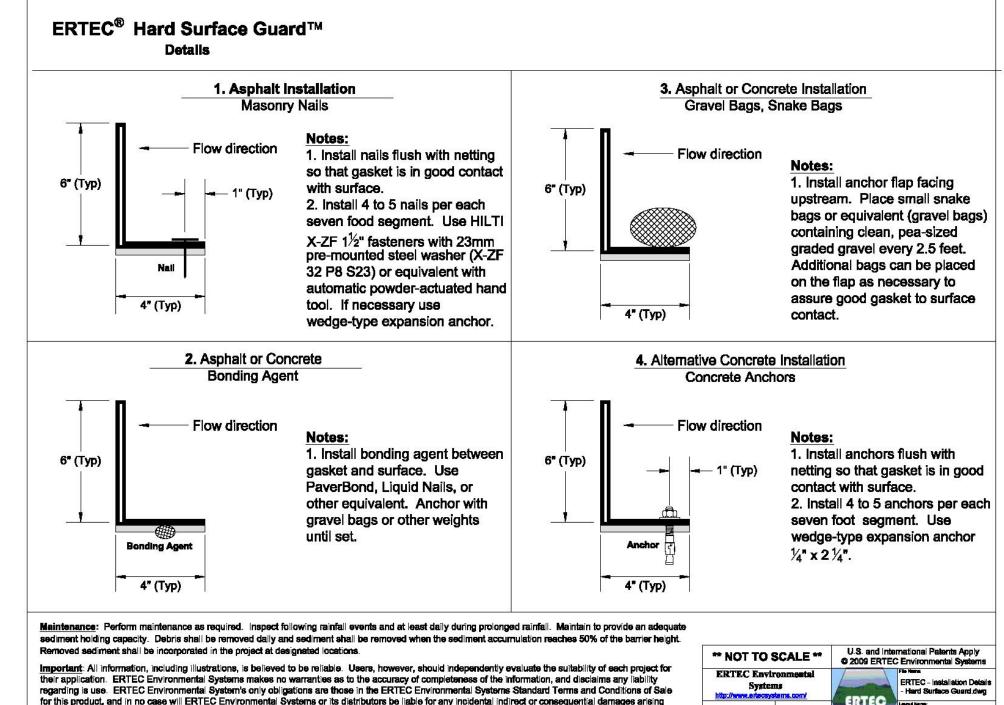

HARD SURFACE SILT GUARD (ALTERNATE TO WATTLES)

NOT TO SCALE

EROSION AND POLLUTION CONTROL NOTES:

end of each working day or more often during the rainy season.

3. Contractor is responsible for inspection and restoration of all aspects of the erosion control plan. Sediment on the sidewalks and

conforming to the elements shown on this plan or related documents.

5. Contractor to employ Best Management Practices (BMP's) in latest recommendations.

6. All dumpsters or other trash storage enclosures shall be utilized

7. During the rainy season, all paved areas shall be kept clear of earth material and debris, the site shall be maintained so that a minimum of sediment—laden runoff enters the storm drain system. These plans and/or requirements shall remain in effect until the improvements are accepted by the City.

8. Borrow areas and temporary stockpiles shall be protected with appropriate erosion control measures to the satisfaction of the City and the Civil Engineer.

9. Remove spoils promptly and avoid stockpiling of fill materials when rain is forecast. If rain is forecast or apparent, stockpiled soils and other materials shall be covered with plastic or a tarp, at the direction of the City and the City Engineer.

10. Store, handle and dispose of construction materials and wastes so as to prevent their entry to the storm drain system. Contractor must not allow concrete, washwaters, slurries, paint or other materials to enter the catch basins, storm drainage, or enter site runoff.

11. Use filtration or other approved measures to remove sediment from dewatering effluent.

12. Cleaning, fueling or maintaining vehicles on site shall not permit or allow deleterious materials from entering the catch basins,

14. Hydroseed or apply (non-toxic) soil stabilizers to inactive construction areas (previously graded areas inactive for ten days or

15. Replant vegetation in disturbed areas as quickly as possible.

16. Limit the area subject to excavation, grading and other construction

17. Prior to commencing construction, install silt sack or equivalent into

18. Place perimeter silt fence prior to commencement of any

19. On site storm drain facilities are to be protected to prevent intrusion

21. See sheet C7.3 for additional minimum requirements.

22. Contractor is responsible for conforming to the requirements of construction period pollution prevention practices as identified in "BLUE PRINT FOR A CLEAN BAY" which can be viewed at "www.flowstobay.org".

1. All erosion control facilities must be inspected and repaired at the

2. If significant sediment or other visual symptoms of impurities are noticed in the storm water, contact the design civil engineer immediately.

gutters shall be removed by shovel or broom and disposed of appropriately.

4. All employees, contractors, and subcontractors are responsible for

accordance with the Association of Bay Area Governments (ABAG)

solely for non-hazardous materials.

storm drainage, or enter site runoff.

13. Water all active construction areas at least twice a day, or as needed to prevent visible dust plumes from blowing onto or off the site.

activity at any one time.

catch basins adjacent to and down stream of the project.

construction activity.

of foreign materials into the storm drain system.

20. Trucks leaving the side must be covered to prevent spills.

CHINESE

845 JACKSON STREET SAN FRANCISCO, CA

OSHPD # IS-072017 Facility Number 14621

NEW ACUTE CARE HOSPITAL & SKILLED NURSING UNIT

JACOBS

6688 North Central Expressway Suite 400, MB13 Dallas, TX 75206 Phone: 214.424.7500

CONSULTANTS:

ARUP **MAZZETTI & ASSOCIATES** - F.W.ASSOCIATES, INC. - SJ ENGINEERS

OWNER CONSULTANTS: KCA ENGINEERS SURE ENGINEERS

TREADWELL & ROLLO

BID SET 07-23-12



318 BRANNAN ST. SAN FRANCISCO, CA. 94107 (415) 546-7111 OFFICE (415) 546-9472 FAX Issued For 09.17.10 CITY SUBMITTAL

09.30.11 CITY RESUBMITTAL 10.15.12 OSHPD RESUBMITTAL 02.04.13 FOR REVIEW 02.19.13 OSHPD/CCSF RESUBMITTAL


Seals and Signatures

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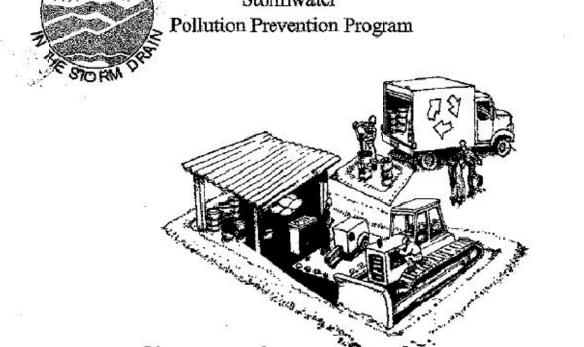
Office of Statewide Health Planning and Development FACILITIES DEVELOPMENT DIVISION



Drawing Title **SWPPP DETAILS**

Project Number

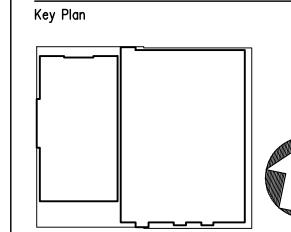Stormwater Pollution Prevention Program



General Construction

Advance planning prevents pollution

Schedule excavation and grading activities for dry weather periods. To reduce soil erosion, plant temporary vegetation or place other erosion controls before

& Site Supervision

Locate and protect storm drains in the vicinity of the site with berms or filters during wet weather periods. Control the amount of runoff crossing your site (especially during excavation) by using berms or tempo rary or permanent drainage ditches to divert water flow around the site. Reduce stormwater runoff velocities by constructing temporary check dams or berms where appropriate.

Train your employees and subcontractors. Make these brochures available to everyone who works on the construction site. Inform subcontractors about the new stomwater requirements and their responsibilities.

Good housekeeping practices

Designate one completely contained area for auto parking, vehicle refueling, and routine equipment maintenance. The designated area should be well away from streams or storm drain inlets, and bermed if necessary. Make major repairs off site.

✓Keep materials out of the rain - prevent runoff contamination at the source. Cover exposed piles of soil or construction materials with plastic sheeting or

✓ Keep poliutants off exposed surfaces. Place trash cans and recycling receptacles around the site to minimize

✓Dry sweep paved surfaces that drain to storm drains. creeks, or channels. If pavement flushing is necessary, use silt pends or other techniques to trap sediment and other pollutants.

√Clean up leaks, drips and other spills immediately so they do not contaminate soil or groundwater or leave residue on paved surfaces. Use dry cleanup methods whenever possible. If you must use water, use just encugh to keep the dust down.

✓ Cover and maintain dumpsters. Check frequently for leaks. Place dumpsters under roofs or cover with tarps or plastic sheeting secured around the outside of the dumpster. A plastic liner is recommended to prevent lealage of liquids. Never clean out a dumpster by hosing it down on the construction site.

✓ Make sure portable toilets are maintained in good working order by the leasing company and that wastes are disposed of properly. Check toilets frequently for

Materials/waste handling ✓ Practice source reduction – minimize waste when

you order materials. Order only the amount you need to finish the job.

✓ Use recyclable materials whenever possible. Arrange forpick-up of recyclable materials such as concrete, asphalt, scrap metal, solvents, degreasers, cleared vegetation, paper, rock, and vehicle maintenance materials such as used oil, antifreeze, batteries, and tires.

✓ Dispose of all wastes and demolition debris properly. Many construction materials and wastes can be recycled, including solvents, water-based paints, vehicle fluids, broken asphalt and concrete, wood, and cleared vegetation. Materials and debris that cannot be recycled must be taken to an appropriate landfill or disposed of as hazardous waste. Never bury waste materials or leave them in the street or near a creek or stream bed.

Pollution Prevention — It's Part of the Plan It is your responsibility to do the job right!

Runoff from streets and other paved areas is a major source of pollution in local creeks, San Francisco Bay and the Pacific Ocean. Construction activities can directly affect the health of our waters unless contractors and crews plan ahead to keep dirt, debris, and other construction waste away from storm drains and creeks. Following these guidelines will ensure your compliance with local stormwater ordinance requirements. Remember, ongoing monitoring and maintenance of installed controls is crucial to proper implementation.

Heavy Equipment Operation



Site planning and preventive vehicle maintenance ✓ Designate a completely contained area of the construction site, well away from streams or storm drain inlets, for auto and equipment parking, refueling, and routine vehicle and equipment maintenance.

✓ Maintain all vehicles and heavy equipment. Inspect frequently for and repair leaks.

✓ Perform major maintenance, repair jobs, and vehicle and equipment washing off site.

If you must drain and replace motor oil, radiator coolant, or other fluids on site, use drip pans or drop cloths to catch drips and spills. Collect all spent fluids, store in separate containers, and recycle whenever possible, or dispose of fluids as hazardous waste.

✓ Do not use diesel oil to lubricate or clean equipment or

✓ Recycle used vehicle batteries.

Clean up spills immediately when they happen

√ Never hose down "dirty" pavement or impermeable surfaces where fluids have spilled. Use dry cleanup methods (absorbent materials, cat litter, and/orrags) whenever possible. If you must use water, use just enough to keep the dust down.

Sweep up spilled dry materials immediately. Never attempt to "wash them away" with water, or bury them. Use as little water as possible for dust control.

✓ Clean up spills on dirt areas by digging up and properly disposing of contaminated soil.

✓ Report significant spills to the appropriate spill response agencies immediately. You are required by law to report all significant releases o hazardous materials, including oil. To report a spill, call the following agencies: 1) Dial 911 or your local emergency response number, 2) Call the Governor's Office of Emergency Services Warning Center, (800) 852-7550(24 hours).

Earth-Moving Activities



√Remove existing vegetation only when absolutely neces-

✓ Seed or plant temporary vegetation for erosion control on slopes or where construction is not immediately planned.

✓ Protect downslope drainage courses, streams, and storm drains with hay bales, temporary drainage swales, silt fences, berms or storm drain inlet filters.

✓ Use check dams or disches to divert runoff around excavations and graded areas.

✓ Cover stockniles and excavated soil with secured tarps of plastic sheeting.

✓ Properly monitor and maintain all erosion and sediment

✓ Properly report failures of ercsion and sediment controls to the local stormwater authority.

General Business Practices ✓ Schedule excavation and grading work for dry weather.


✓ Perform major equipment repairs away from the job site.

✓ When refueling or when vehicle/equipment maintenance must be done on site, work within a completely bermed area away from storm drains.

✓ Do not use diesel oil to lubricate or clean equipment or parts.

Watch for soil and ponded groundwater that may be con-If any of these conditions are observed, test for contamination

- and contact the Regional Water Quality Control Board:
- Unusual soil conditions, discoloration, or odor Abandoned underground tanks
- Abandoned wells Buried barrels, debris, or trash.

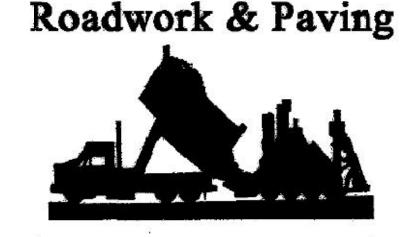

Develop and implement erosion/sediment control plans for

✓ Schedule excavation and grading work for dry weather. ✓ Check all equipment for leaks and repair leaking equipment

✓ Perform major mantenance, repairs, and washing of equipment away from the construction site. ✓ When refueling or vehicle/equipment maintenance must be cone on site, designate a completely contained area away

from storm drains and creeks. ✓ Do not use diesel oil to lubricate or clean equipment or

✓ Recycle used oil, batteries, concrete, broken asphalt, etc., whenever possible.

✓ Train employees in using these best management practices.

During Construction ✓ Avoid paving and seal coating in wet weather, or when rain

is forecast before fresh pavement will have time to cure. ✓ Cover and seal catch basins and manholes when applying seal coat, slurry seal, fog seal, etc.

✓ Use check dams, ditches, or berms to divert runoff around. excavations. ✓ Never wash excess material from exposed- aggregate con-

crete or similar treatments into a street or storm drain. Collect and recycle, or dispose to dirt area. ✓ Cover stockpiles and other construction materials with

plastic tarps. Protect from rainfall and prevent runoff with temporary roofs or plastic sheets and berms. ✓ Catch drips from paver with drip pans or absorbent material

(cloth, rags, etc.) placed under machine when not in use. ✓ Clean up all spills and leaks using "dry" methods (with absorbent materials/rags), or dig up and remove contami-

✓ Collect and recycle or appropriately dispose of excess abrasive gravel or sand. Avoid over-application by water trucks for dust control.

Asphalt/Concrete Removal

✓ Avoid creating excess dust when breaking asphalt or con-

Storm drain polluters may be liable for fines of up to \$25,000 per day!

✓ After breaking up old pavement, be sure to remove all chunks and pieces from the site.

✓ Make sure broken pavement does not come in contact with rainfall or runoff. ✓ Protect nearby sto:m drain inlets during saw-cutting. Shovel or vacuum saw-cut slurry deposits and remove from the

✓ Never hose down streets to clean up tracked dirt. Use dry sweep methods.

Fresh Concrete



General Business Practices ✓ Both at your yard and the construction site, always store both dry and wet materials under cover, protected from rainfall and runoff. Protect dry materials from wind.

✓ Secure bags of cement after they are open. Be sure to keep wind-blown cement powder away from gutters, storm drains, rainfall, and runoff.

✓ Wash out concrete mixers only in designated wash-out areas in your yard, where the water will flow into containment ponds or onto dirt. Let concrete harden and dispose of as garbage. Whenever possible, recycle washout by pumping back into mixers for reuse. Never dispose of washout into the street, storm drains, drainage ditches, or streams.

During Construction ✓ Don't mix up more fresh concrete or cement than you will

use in a day. ✓ Set up and operate small mixers on tarps or heavy plastic

✓ When cleaning up after driveway or sidewalk construction,

wash fines onto dirt areas, not down the driveway or into the street or storm drain. ✓ Prevent aggregate wash from driveway/patio construction from entering storm drains. Hose aggregate wash onto dirt

✓ Place hay bales or other erosion controls downslope to capture runoff carrying mortar or cement before it reaches the storm drain.

✓ When breaking up paving, be sure to pick up all the pieces and dispose properly.

✓ Recycle large chunks of broken concrete at a landfill.

reas and spade into dirt.

✓ Dispose of small amounts of excess dry concrete, grout, and mortar in the trash.

✓ Never bury solid or hazardous waste material.

Painting & Application & Mortar Application of Solvents & Adhesives



the gutter, street, and storm drains. Liquid residues from

paints, thinners, solvents, glues, and cleaning fluids are hazardous wastes and must be disposed of at a hazardous waste collection facility (contact your local stormwater

Painting cleanup ✓ Never clean brushes or rinse paint containers into a street, gutter, storm drain, or stream.

For water-based paints, paint out brushes to the extent possible. Rinse to the sanitary sewer once you have gained permission from the local wastewater treatment authority. Never pour paint down a drain.

✓ For oil-based paints, paint out brushes to the extent possible and clean with thinner or solvent in a proper container. Filter and reuse thinners and solvents. Dispose of excess liquids and residue as hazardous waste.

Paint removal

✓ Paint chips and dust from non-hazardous dry stripping and sand blasting may be swept up or collected in plastic drop cloths and disposed of as trash.

✓ Chemical paint stripping residue and chips and dust from marine paints or paints containing lead or tributyl tin must be disposed of as hazardous wastes.

✓ When stripping or cleaning building exteriors with highpressure water, block storm drains. Wash water onto a dirt area and spade into soil. Or, check with the local wastewater treatment authority to find out if you can collect (mop or vacuum) building cleaning water and dispose to the sanitary \(\sqrt{Do not blow or rake leaves, etc. into the street.} \) sewer. Sampling of the water may be required to assist the wastewater treatment authority in making its decision.

Recycle/reuse leftover paints whenever possible.

✓ Recycle or dispose of excess water-based paint at a household hazardous waste collection facility, or use up When they are thoroughly dry, empty paint cans, used brushes, rags, and drop cloths may be disposed of as garbage in a sanitary landfill.


✓ Reuse leftover oil-based paint. Dispose of excess liquid, including sludges, as hazardous waste.

or hazardous waste disposal. ✓ Unopened cans of paint may be able to be returned to the paint vendor. Check with the vendor regarding its "buy-

✓ Small quantity generators should check with the San Mateo

County Environmental Health Division regarding recycling

Landscaping, Gardening, and Pool Maintenance

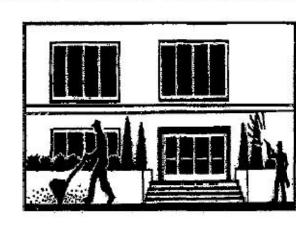

Schedule grading and excavation projects for dry weather.

from storm drains. ✓ Protect stormdrain inlets with hay bales, berms, filter mats

✓ Revegetation is an excellent form of erosion control for

Landscaping/Garden Maintenance

✓ Use up pesticides and follow label directions. Rinse containers, and use rinsewater as product. Dispose of rinsed containers in the trash.

✓ Dispose of unused pesticides as hazardous waste.

✓ Collect lawn and garden clippings, pruning waste, and tree trimmings. Chip if necessary, and compost.

Pool/Fountain/Spa Maintenance ✓ Never discharge chlorinated pcol or spa water to a street or

✓ When emptying a pool or spa, let chlorine dissipate for 5 to 7 days. Then recycle water by craining it gradually onto a landscaped area, or drain the dechlorinated water to a storm

✓ Chlorinated water may be to discharged to the sanitary sewer (if allowed by the local sewage treatment authority) by running a hose to a utility sink or sewer pipe cleanout junc-

✓ Do not use copper-based algaecides. Control algae with chlorine or other alternatives to copper-based pool chemicals. Copper is harmful to aquatic life and cannot be completely removed by the sewage treatment plant.



✓ Protect stockpiles and landscaping materials from wind and rain by storing them under tarps or secured plastic sheeting.

in a shed or storage cabinet.

✓ Store pesticides, fertilizers, and other chemicals indoors or

✓ Use temporary check dams or ditches to divert runoff away

or other inlet protection measures.


✓ Do not place yard waste in gutters. In communities with curbside yardwaste recycling, leave clippings and pruning waste for pickup in approved bags or containers. Or, take to a landfill that composts yard waste.

Office of Statewide Health FACILITIES DEVELOPMENT DIVISION

REVIEWED IN ACCORDANCE WITH

APPROVED

REQUIREMENTS OF T24, CCR

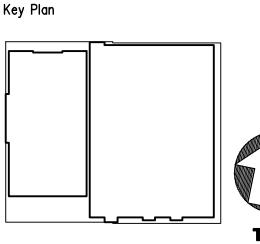

SWPPP DETAILS

MAZZETTI & ASSOCIATES OWNER CONSULTANTS:

09.17.10

CHINESE

845 JACKSON STREET SAN FRANCISCO, CA

OSHPD # IS-072017

Facility Number 14621

NURSING UNIT

JACOBS

Phone: 214.424.7500

Suite 400, MB13 Dallas, TX 75206

CONSULTANTS:

- F.W.ASSOCIATES, INC.

KCA ENGINEERS

SURE ENGINEERS

TREADWELL & ROLLO

NEW ACUTE CARE

6688 North Central Expressway

HOSPITAL & SKILLED

BID SET 07-23-12

KCA ENGINEERS INC CONSULTING CIVIL ENGINEER & LAND SURVEYORS

SAN FRANCISCO, CA. 9410


09.30.11 CITY RESUBMITTAL OSHPD RESUBMITTA 10.15.12 02.04.13 FOR REVIEW OSHPD/CCSF RESUBMITTAL 02.19.13 Seals and Signatures

Issued For

CITY SUBMITTA

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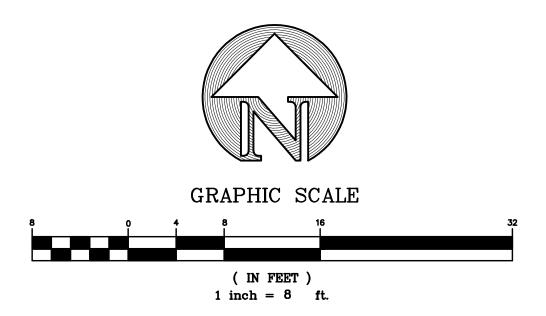


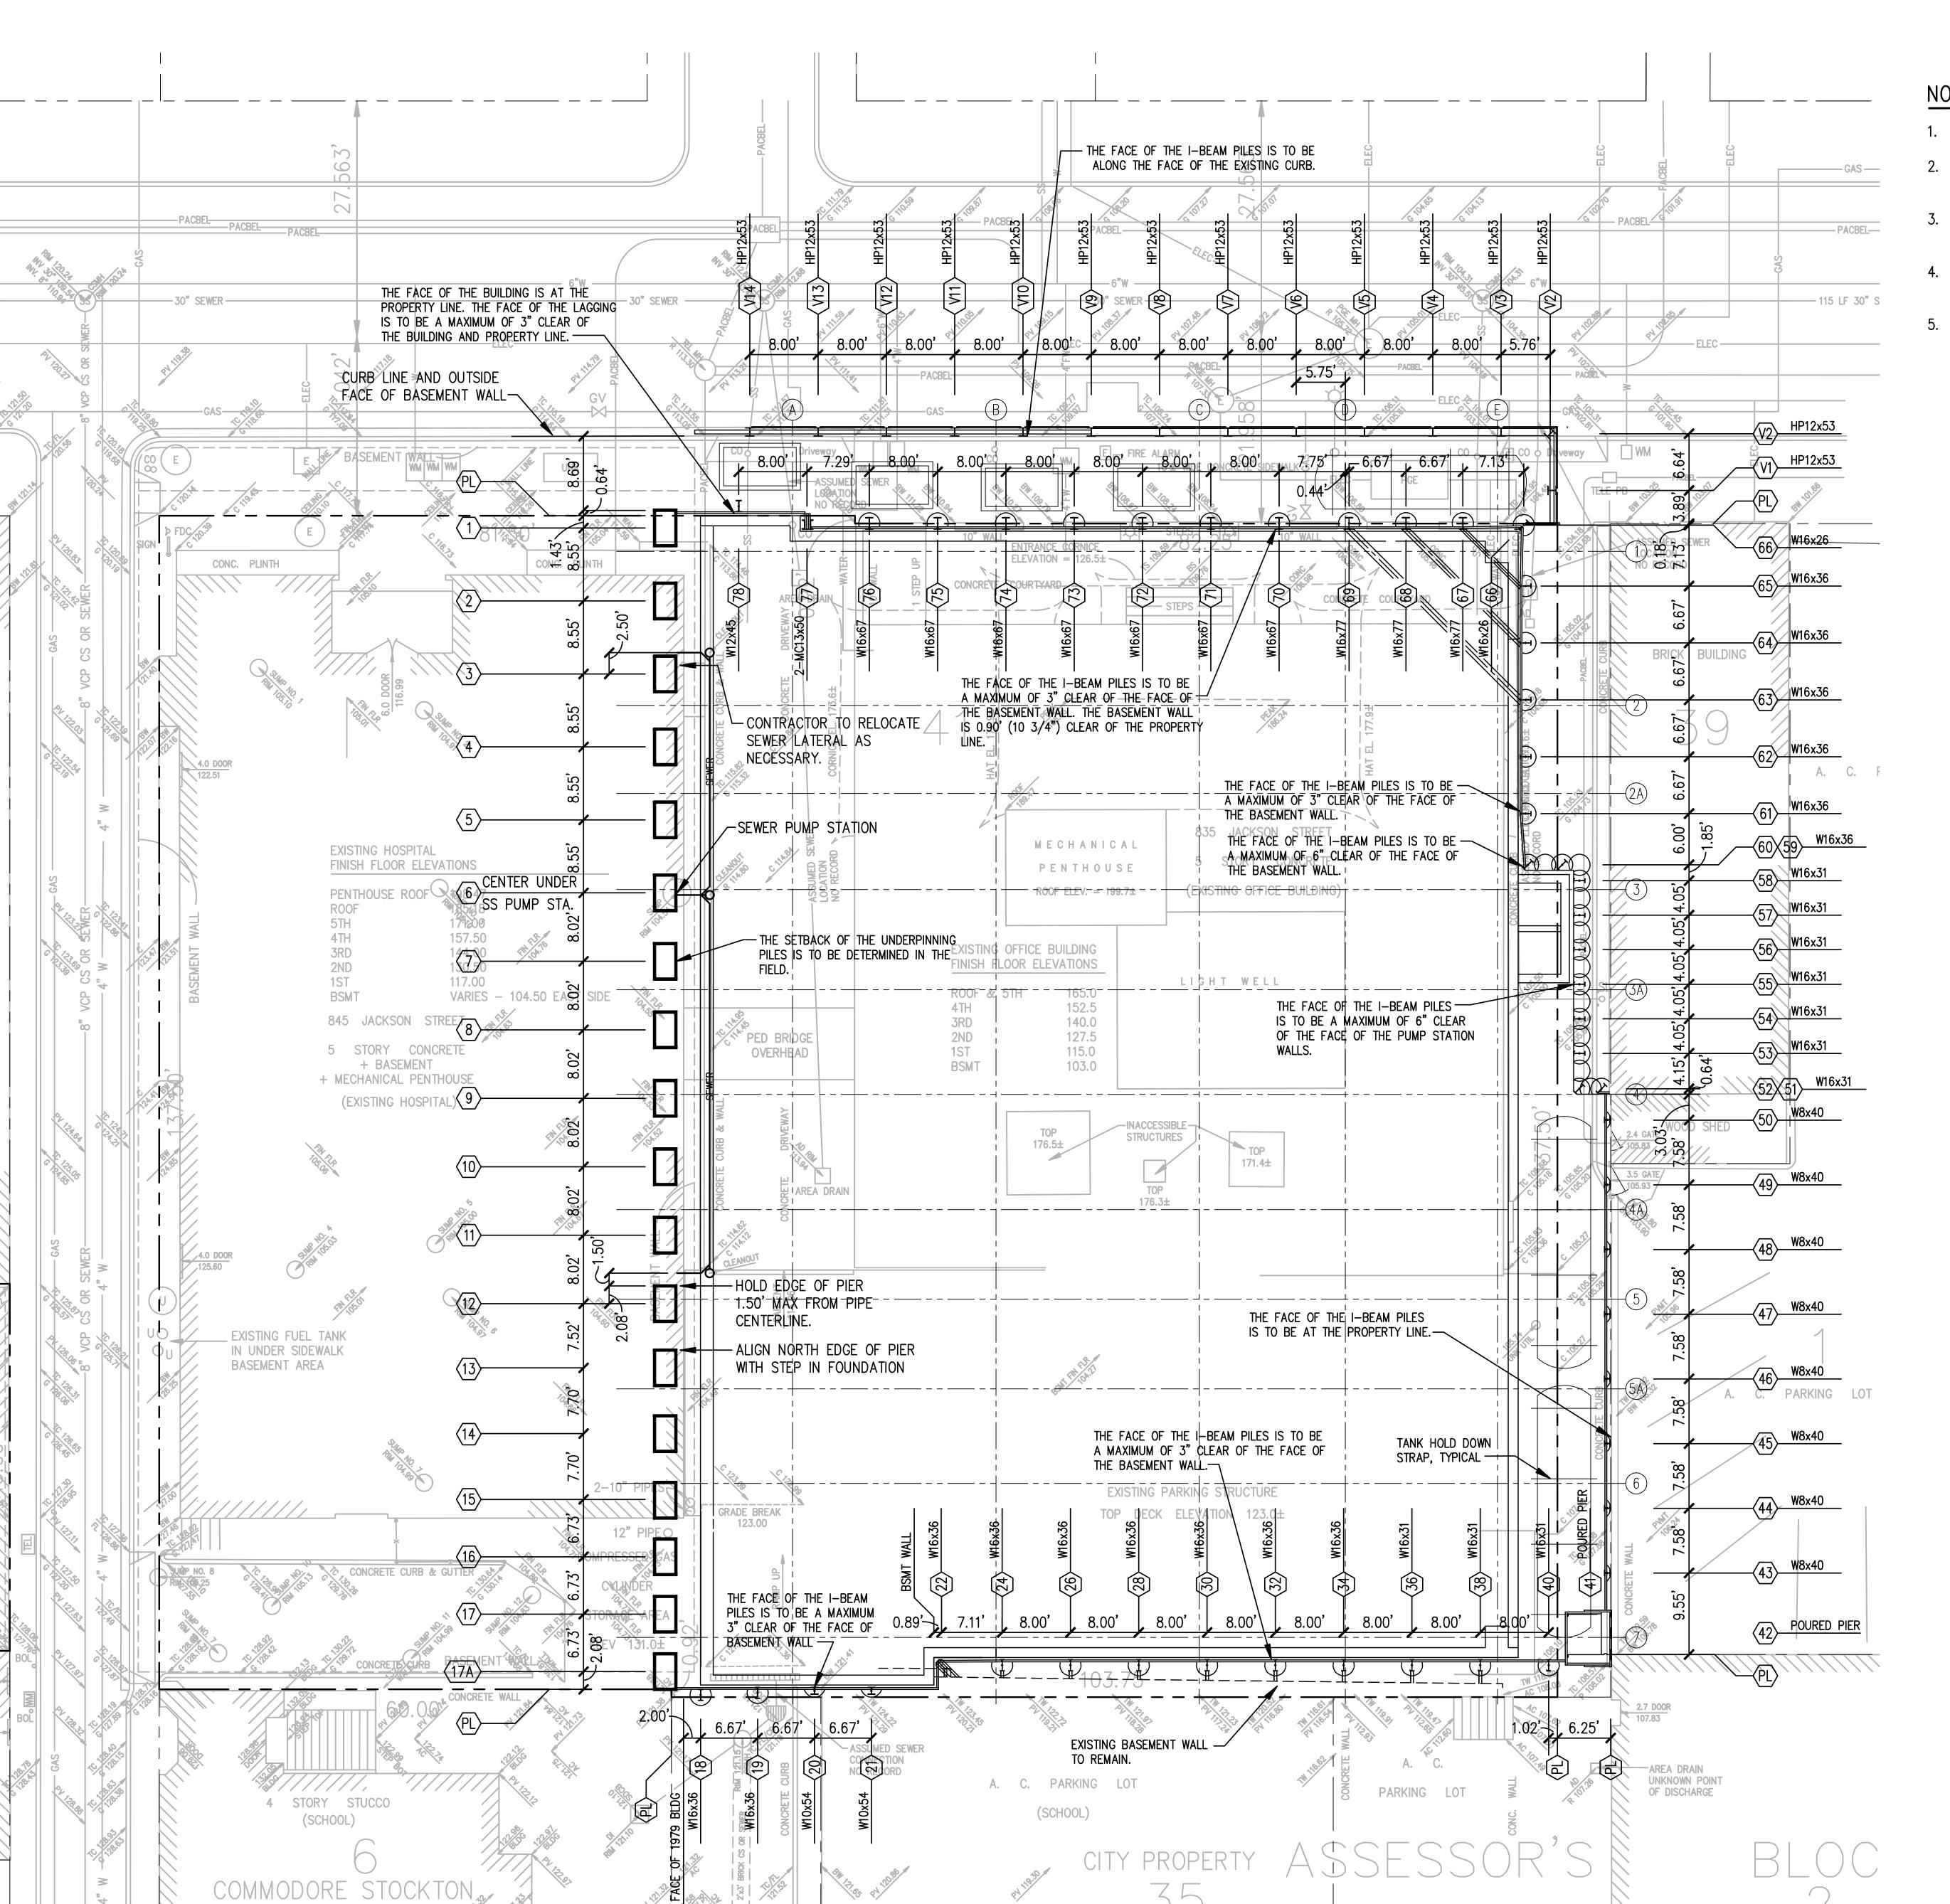

SCHOOL

NOTES:

- SEE SHORING PLANS BY SURE ENGINEERING FOR NOTES AND DETAILS.
- SEWER LINES ARE TO BE LOCATED PRIOR TO START OF UNDERPINNING CONSTRUCTION
- LOCATION OF UNDERPINNING PILES MAY VARY BASED ON THE LOCATION OF THE FIELD LOCATED SEWER PIPES AND PUMP STATION.
- CONTRACTOR IS RESPONSIBLE FOR MAINTAINING SEWER SERIVCE DURING THE UNDERPINNING CONSTRUCTION OF THE SITE.
- 5. SOME TYPE OF DESIGN FOR THE RELOCATION OF THE SEWER SYSTEM WILL BE SUBMITTED TO THE CONTRACTOR PRIOR TO THE COMPLETION OF THE EXCAVATION.





845 JACKSON STREET SAN FRANCISCO, CA

OSHPD # IS-072017 Facility Number 14621

NEW ACUTE CARE HOSPITAL & SKILLED NURSING UNIT

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OWNER CONSULTANTS: KCA ENGINEERS

TREADWELL & ROLLO

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BID SET 07-23-12

KCA ENGINEERS INC. CONSULTING CIVIL ENGINEERS & LAND SURVEYORS 318 BRANNAN ST. SAN FRANCISCO, CA. 94107


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Issued For	Rev.	Date
PRELIMINARY		10.02.12
SHORING COMMENTS		10.02.12
UPDATE PER PHONE CONF.	_	10.24.12
ADDED TANKS & HOLD DOWNS	_	11.13.12
UPDATE PER 1.15.13 DRAWNGS	_	1.18.13
FOR REVIEW	_	02.04.13
OSHPD/CCSF RESUBMITTAL	_	02.19.13

Seals and Signatures


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Office of Statewide Health Planning and Development

FACILITIES DEVELOPMENT DIVISION

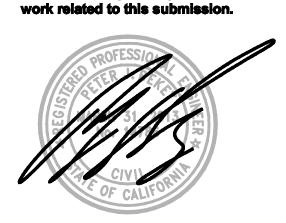


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UNDERPINNING LAYOUT

Project Number

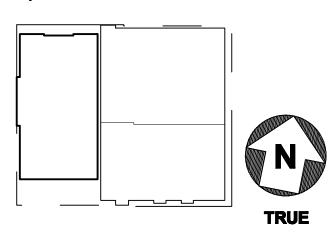024338 Drawing Number

Print Date



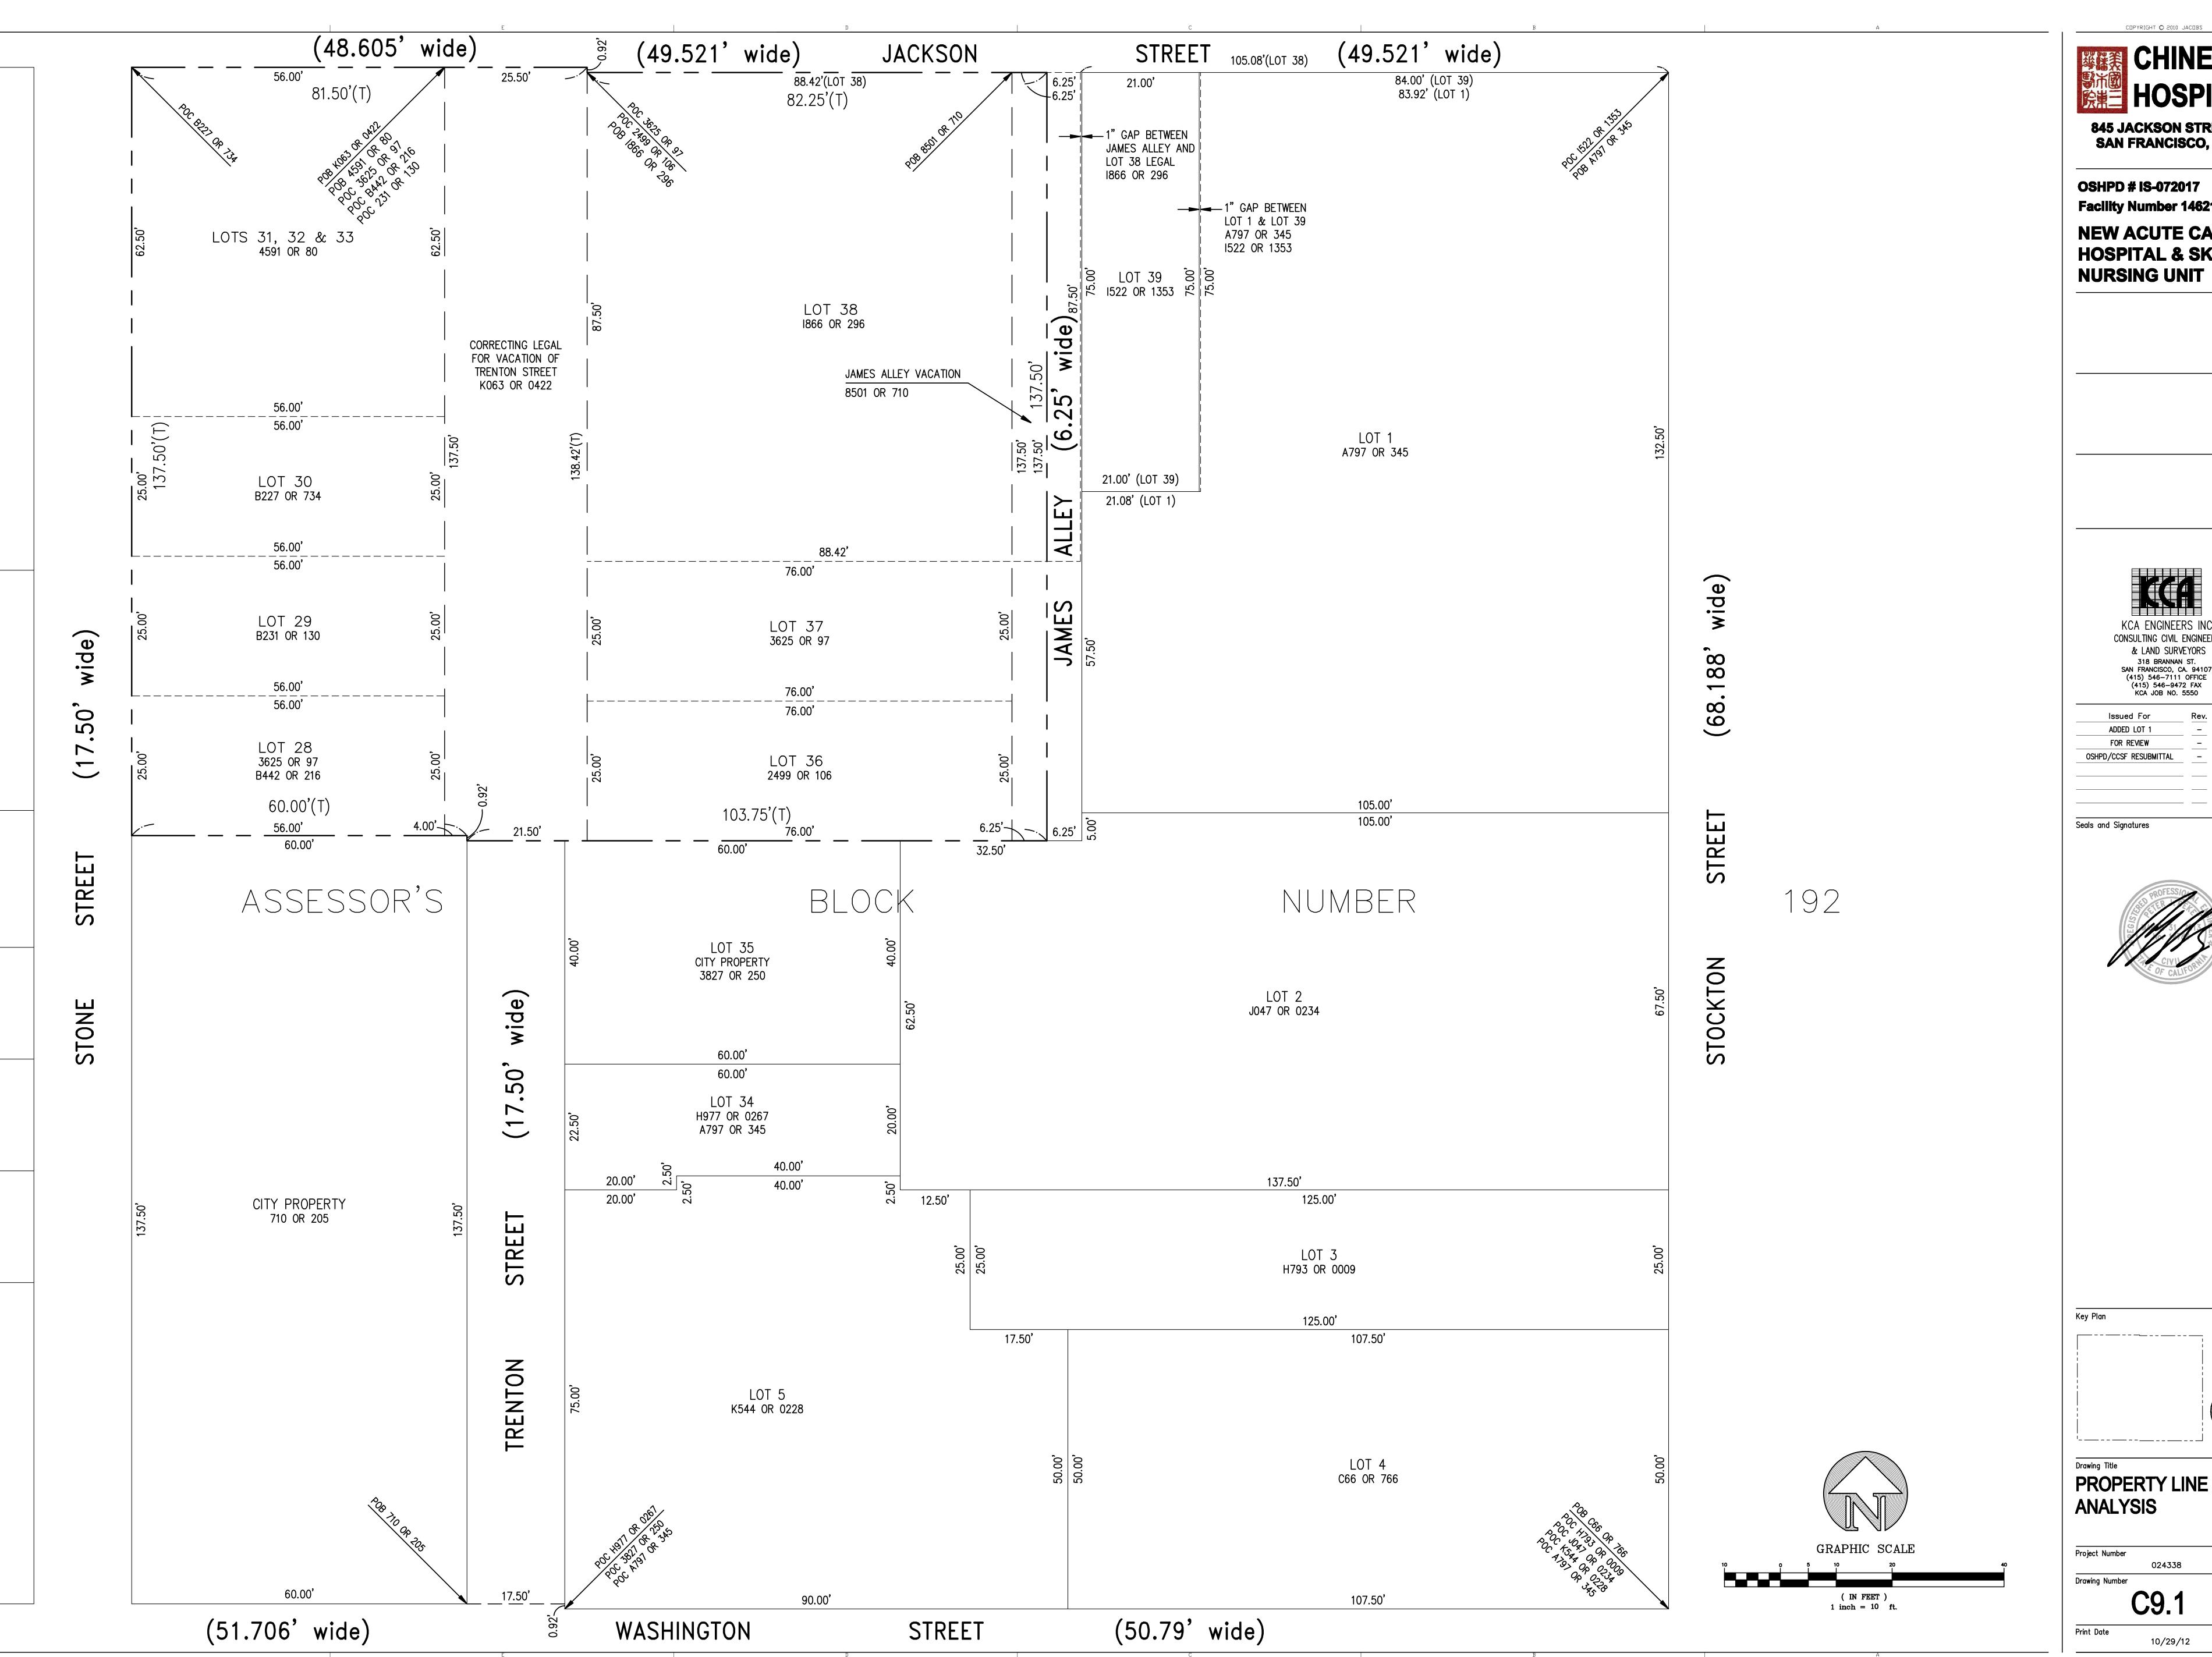

OSHPD # IS-072017 Facility Number 14621 **NEW ACUTE CARE HOSPITAL & SKILLED**

KCA ENGINEERS INC.

CONSULTING CIVIL ENGINEERS

& LAND SURVEYORS

318 BRANNAN ST.

SAN FRANCISCO, CA. 94107


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KCA LOB NO. 5550

FOR REVIEW OSHPD/CCSF RESUBMITTAL

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Drawing Title
PROPERTY LINE **ANALYSIS**

Project Number Drawing Number

C9.1

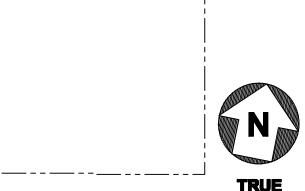10/29/12

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845 JACKSON STREET SAN FRANCISCO, CA

OSHPD # IS-072017 Facility Number 14621

NEW ACUTE CARE HOSPITAL & SKILLED NURSING UNIT

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OWNER'S CONSULTANTS: KCA ENGINEERS SURE ENGINEERS TREADWELL & ROLLO

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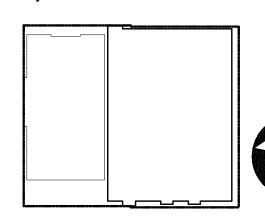
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UTIL CO. INFO SUPPLIED	_	09.24.12
BASEMENT WALL CONFLICT	_	10.24.12
PGE GAS ADDED		10.26.12
NEW ARCH BASE	_	11.02.12
PGE COMMENTS	_	12.04.12
PGE COMMENTS		12.27.12
FOR REVIEW	_	02.04.13
OSHPD/CCSF RE-SUBMITTAL		
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Seals and Signatures

PRELIMINARY



Key Plan





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1" = 4' Project Number Drawing Number

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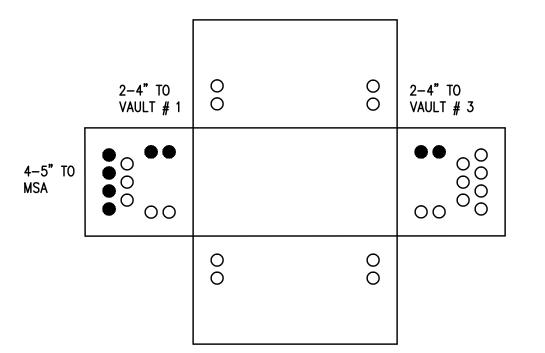
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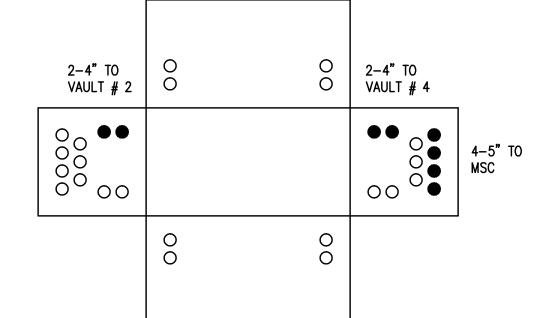




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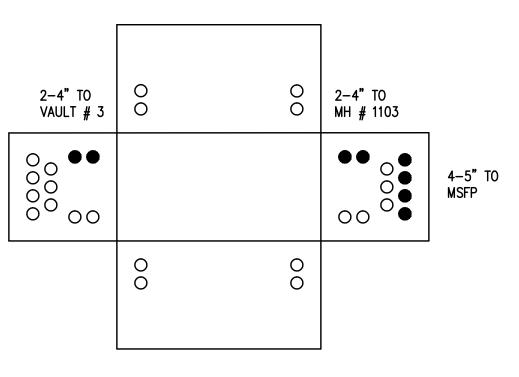
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 $\frac{\text{VAULT NO. 3}}{\text{SCALE: 1" = 4'}}$

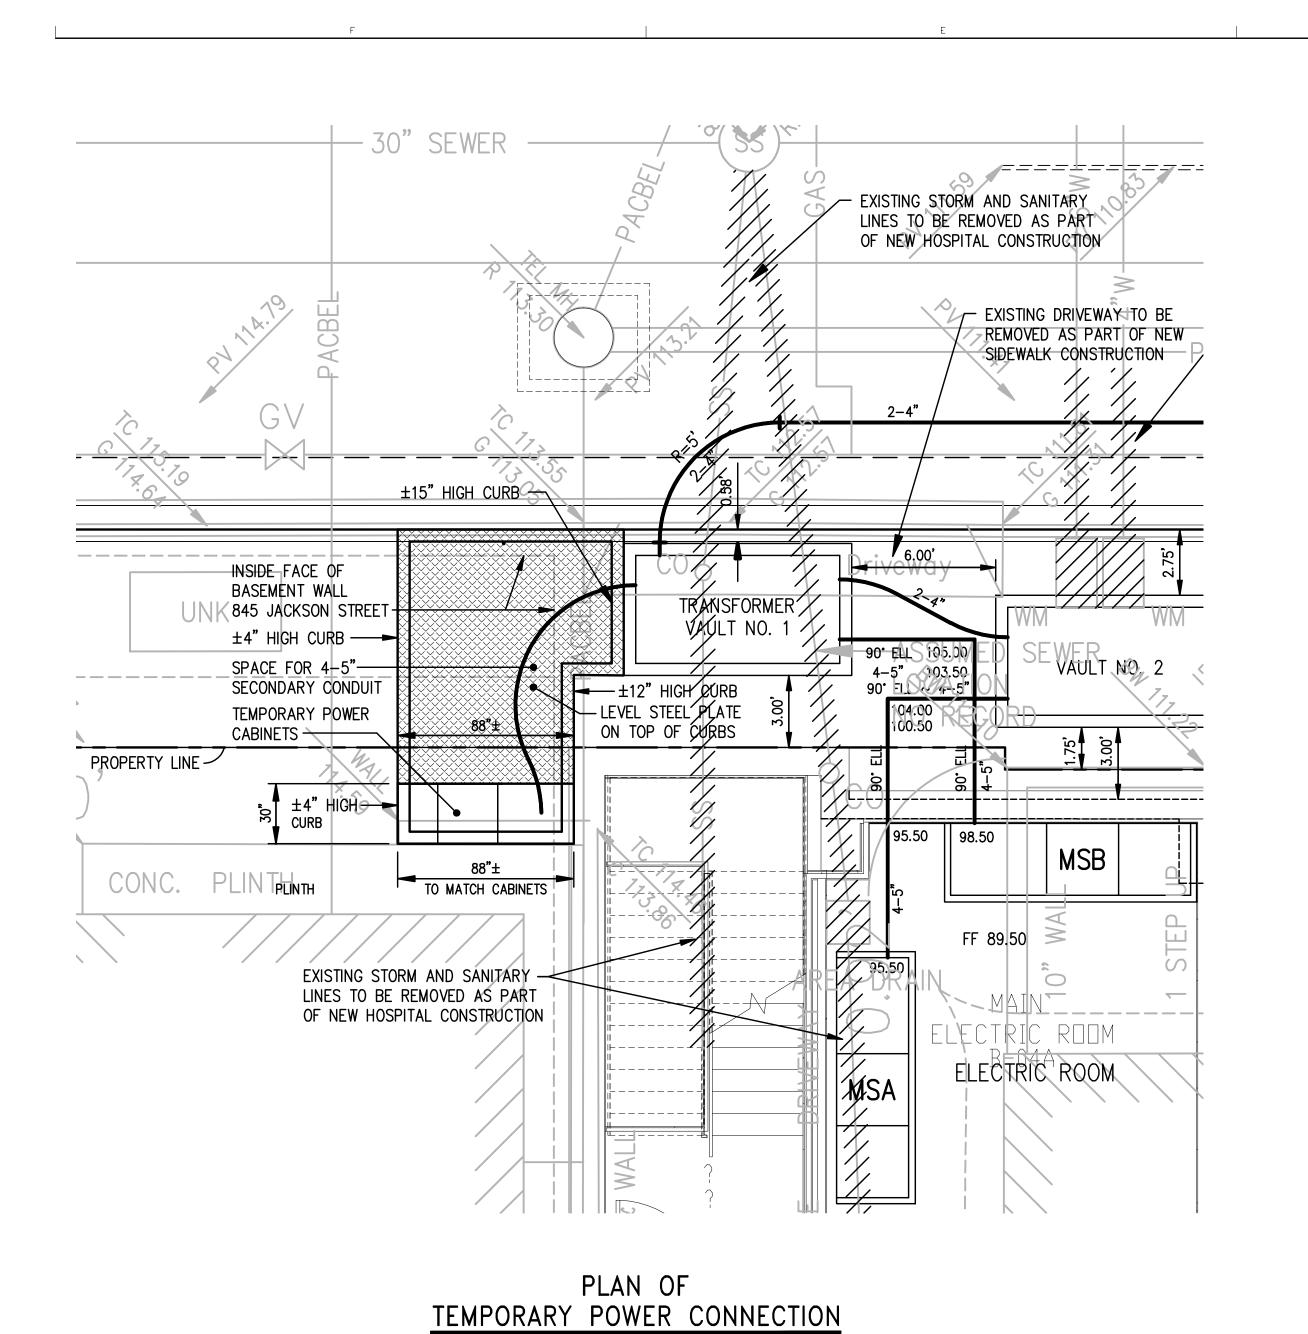

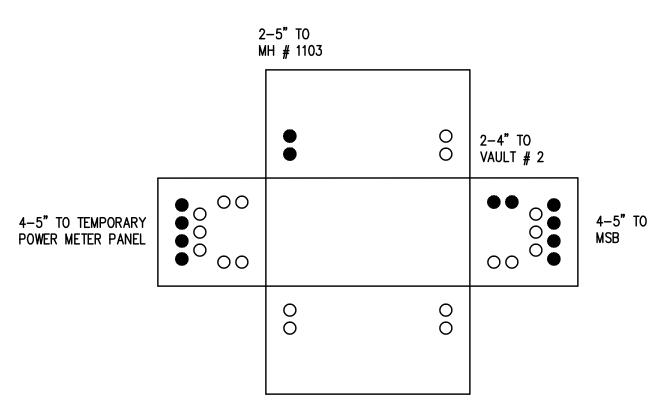
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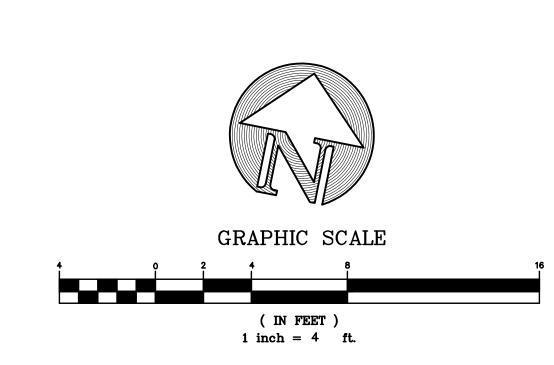
SCALE: 1" = 4'

MANHOLE NO. 1

PLAN OF
BUTTERFLYS OF VAULTS

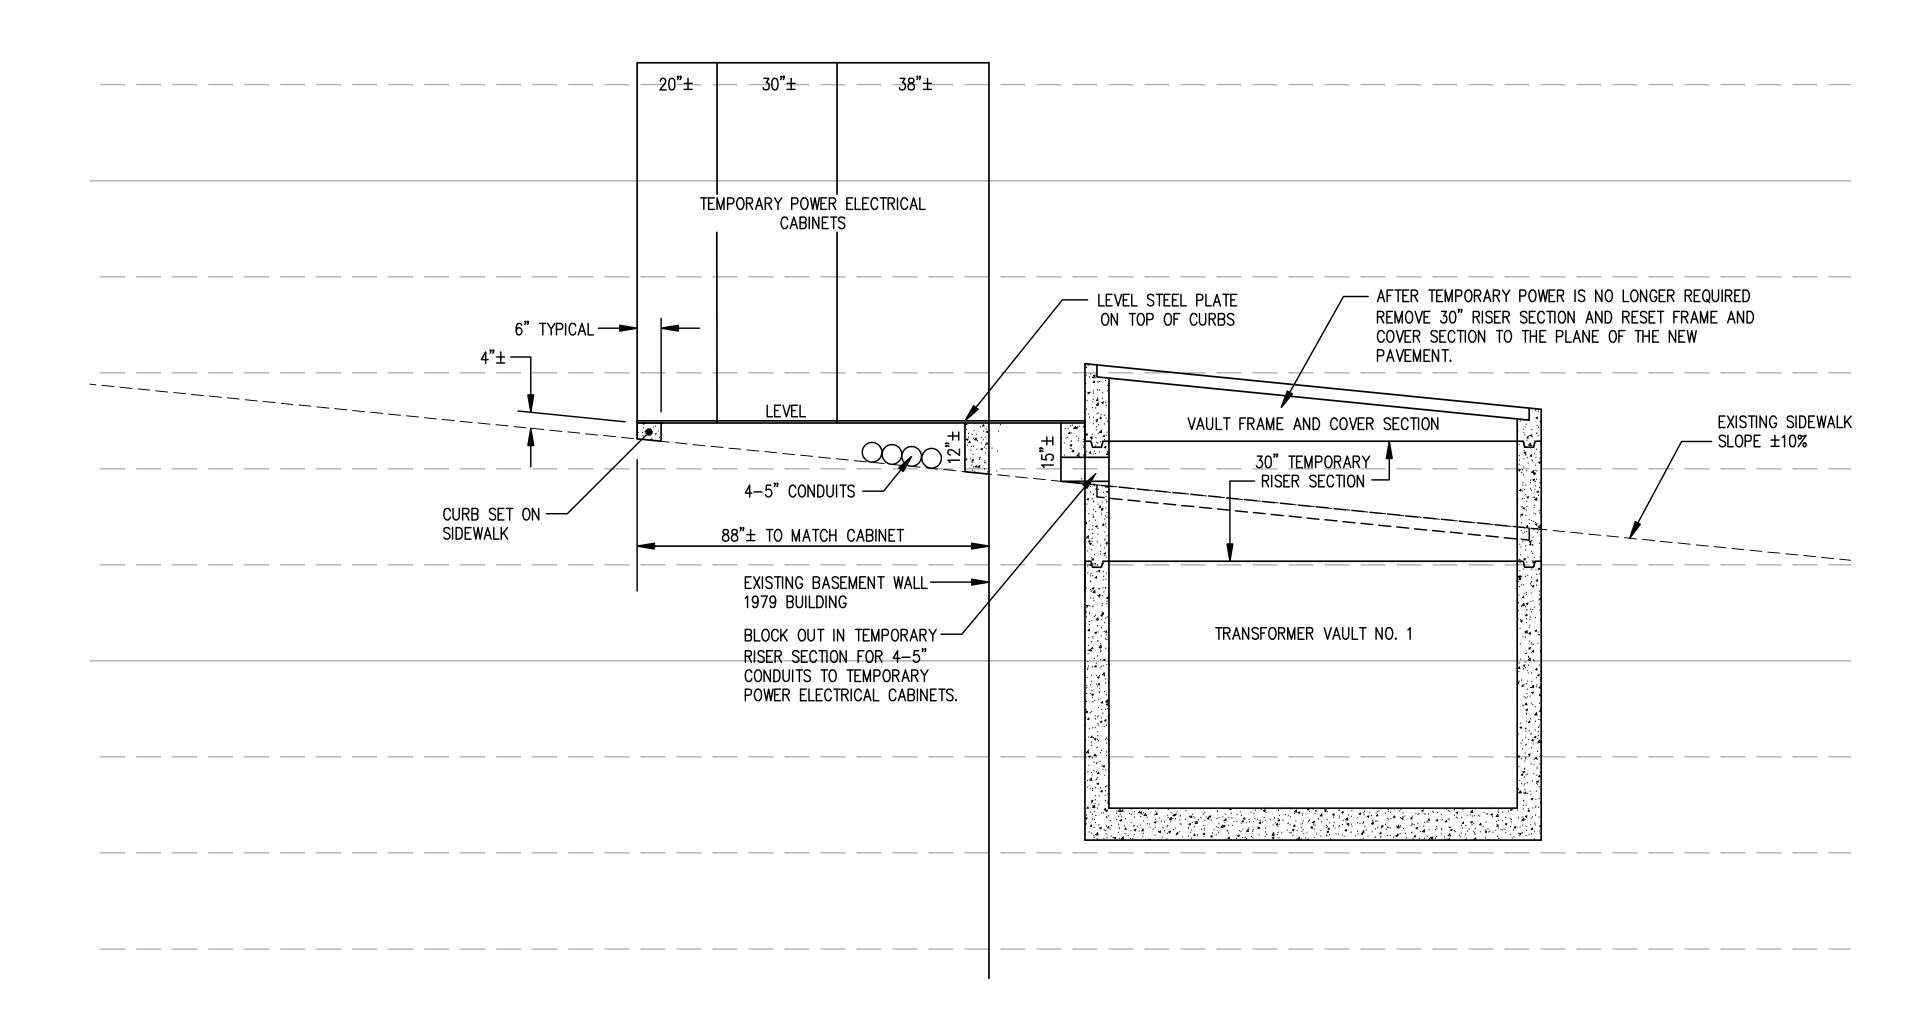

SECTION LOOKING NORTH



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CHINESE
HOSPITAL

845 JACKSON STREET

OSHPD # IS-072017 Facility Number 14621

SAN FRANCISCO, CA

NEW ACUTE CARE HOSPITAL & SKILLED NURSING UNIT

JACOBS CARTER BURGESS 900 Kearny Street, Suite 500 San Francisco, CA 94133 Phone: 713/859-8801

CONSULTANTS: ARUP

MAZZETTI & ASSOCIATES F.W.ASSOCIATES, INC. SJ ENGINEERS

OWNER'S CONSULTANTS:
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SURE ENGINEERS
TREADWELL & ROLLO


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& LAND SURVEYORS

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Issued For	Rev.	Date
PRELIMINARY DESIGN		08.21.12
UTIL CO. INFO SUPPLIED	_	09.24.12
BASEMENT WALL CONFLICT	_	10.24.12
PGE GAS ADDED		10.26.12
NEW ARCH BASE	_	11.02.12
PGE COMMENTS		12.04.12
PGE COMMENTS		12.27.12
FOR REVIEW		02.04.13
OSHPD/CCSF RESUBMITTAL		02.19.13

PRELIMINARY
FOR REVIEW ONLY
This signature represents on participation in the coordination assembly of this drawing set of responsibility for any technical related to this submission.

tional Professional Seal When Required

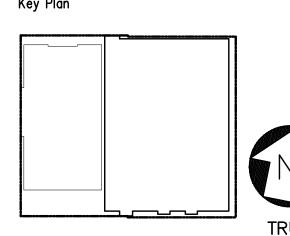

P.G.& E. VAULTS
PRELIMINARY DESIGN

T" = 4'

Project Number

024338

Drawing Number

C10.2

Print Date